

## **PLANS AND SPECIFICATIONS**

# **CONTRACT PLANS FOR**

---

## **CITY OF VENICE**

## **DOWNTOWN ROADWAY**


## **CORRIDOR IMPROVEMENTS**

**CITY PROJECT #: 2017-03**  
**FDOT FINANCIAL PROJECT ID: 435092-1-58-01**  
**FDOT EDTF #: 439455-1-54-01**  
**FEDERAL FUNDS**

FEBRUARY 1980

CITY of VENICE  
ENGINEERING DEPARTMENT  
401 WEST VENICE AVENUE  
Venice, Florida 34285  
ph: (941) 486-2626

CITY OF VENICE

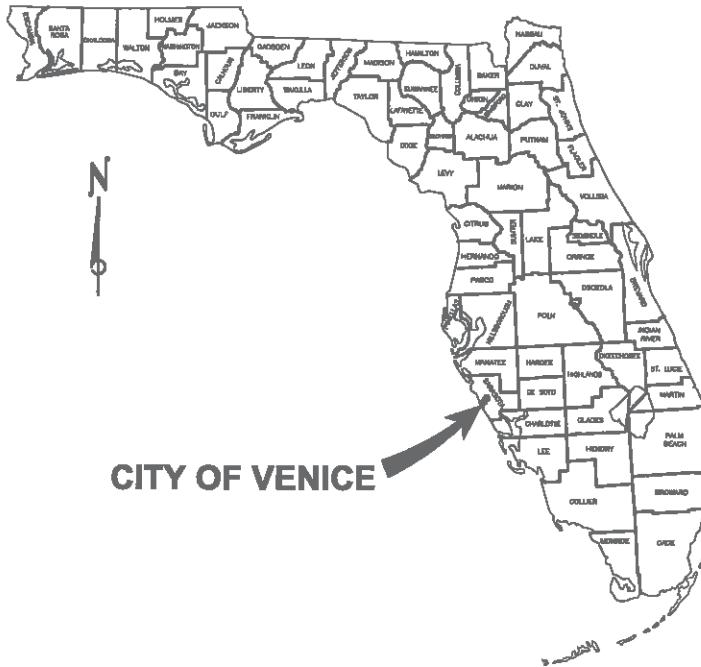

## **GOVERNING DESIGN STANDARDS:**

**Florida Department of Transportation, FY 2017-18 Design Standards eBook (DSeB) and applicable Design Standards Revisions (DSRs) at the following website:**  
<http://www.fdot.gov/marway/DesignStandards/Standards.shtml>

## **GOVERNING STANDARD SPECIFICATIONS:**

Florida Department of Transportation, January 2018 Standard Specifications for Road and Bridge Construction at the following website:  
<http://www.fdot.gov/programmanagement/ImplementedSpecBooks>



## LOCATION MAP

**PREPARED BY:**

**PRINCIPAL ADDRESS:**  
4030 W. BOY SCOUT BLVD  
SUITE 700  
TAMPA, FL. 33607-1712  
CERT. OF AUTH. No. 24



**Know what's below.  
Call before you dig.**

## CONTRACT PLANS COMPONENTS

**ROADWAY PLANS  
LANDSCAPE PLANS  
SIGNING & PAVEMENT MARKING PLANS  
LIGHTING PLANS (PHASE 1)**


## INDEX OF ROADWAY PLANS

SHEET #	TITLE
1	KEY SHEET
2	KEY PLAN
3	DRAINAGE MAP
4-12	DEMOLITION PLANS
13-15	TYPICAL SECTIONS
16	SIDEWALK SUMMARY
17-24	DRAINAGE STRUCTURE TABLES
25	CONTROL PLAN
26	GENERAL NOTES
27-42	PLAN AND PROFILES
43-49	INTERSECTION PLANS
50-54	SPECIAL DETAILS
55-66	CROSS SECTIONS - ROADWAYS
67-70	CROSS SECTIONS - DRIVEWAYS
71-93	TEMPORARY TRAFFIC CONTROL PLANS
94	STORMWATER POLLUTION PREVENTION PLAN (SPPP)
95	EROSION CONTROL DETAILS

BID PLANS  
02-28-18

LENGTH OF PROJECT		
	LINEAR FEET	MILES
ROADWAY	6,422.96	1.216
BRIDGES	-----	-----
NET LENGTH OF PROJECT	6,422.96	1.216
EXCEPTIONS	-----	-----
GROSS LENGTH OF PROJECT	6,422.96	1.216

**PROFESSIONAL ENGINEER  
JOHN SALATINO  
LICENSE # 60921  
PHONE 813-282-7275**

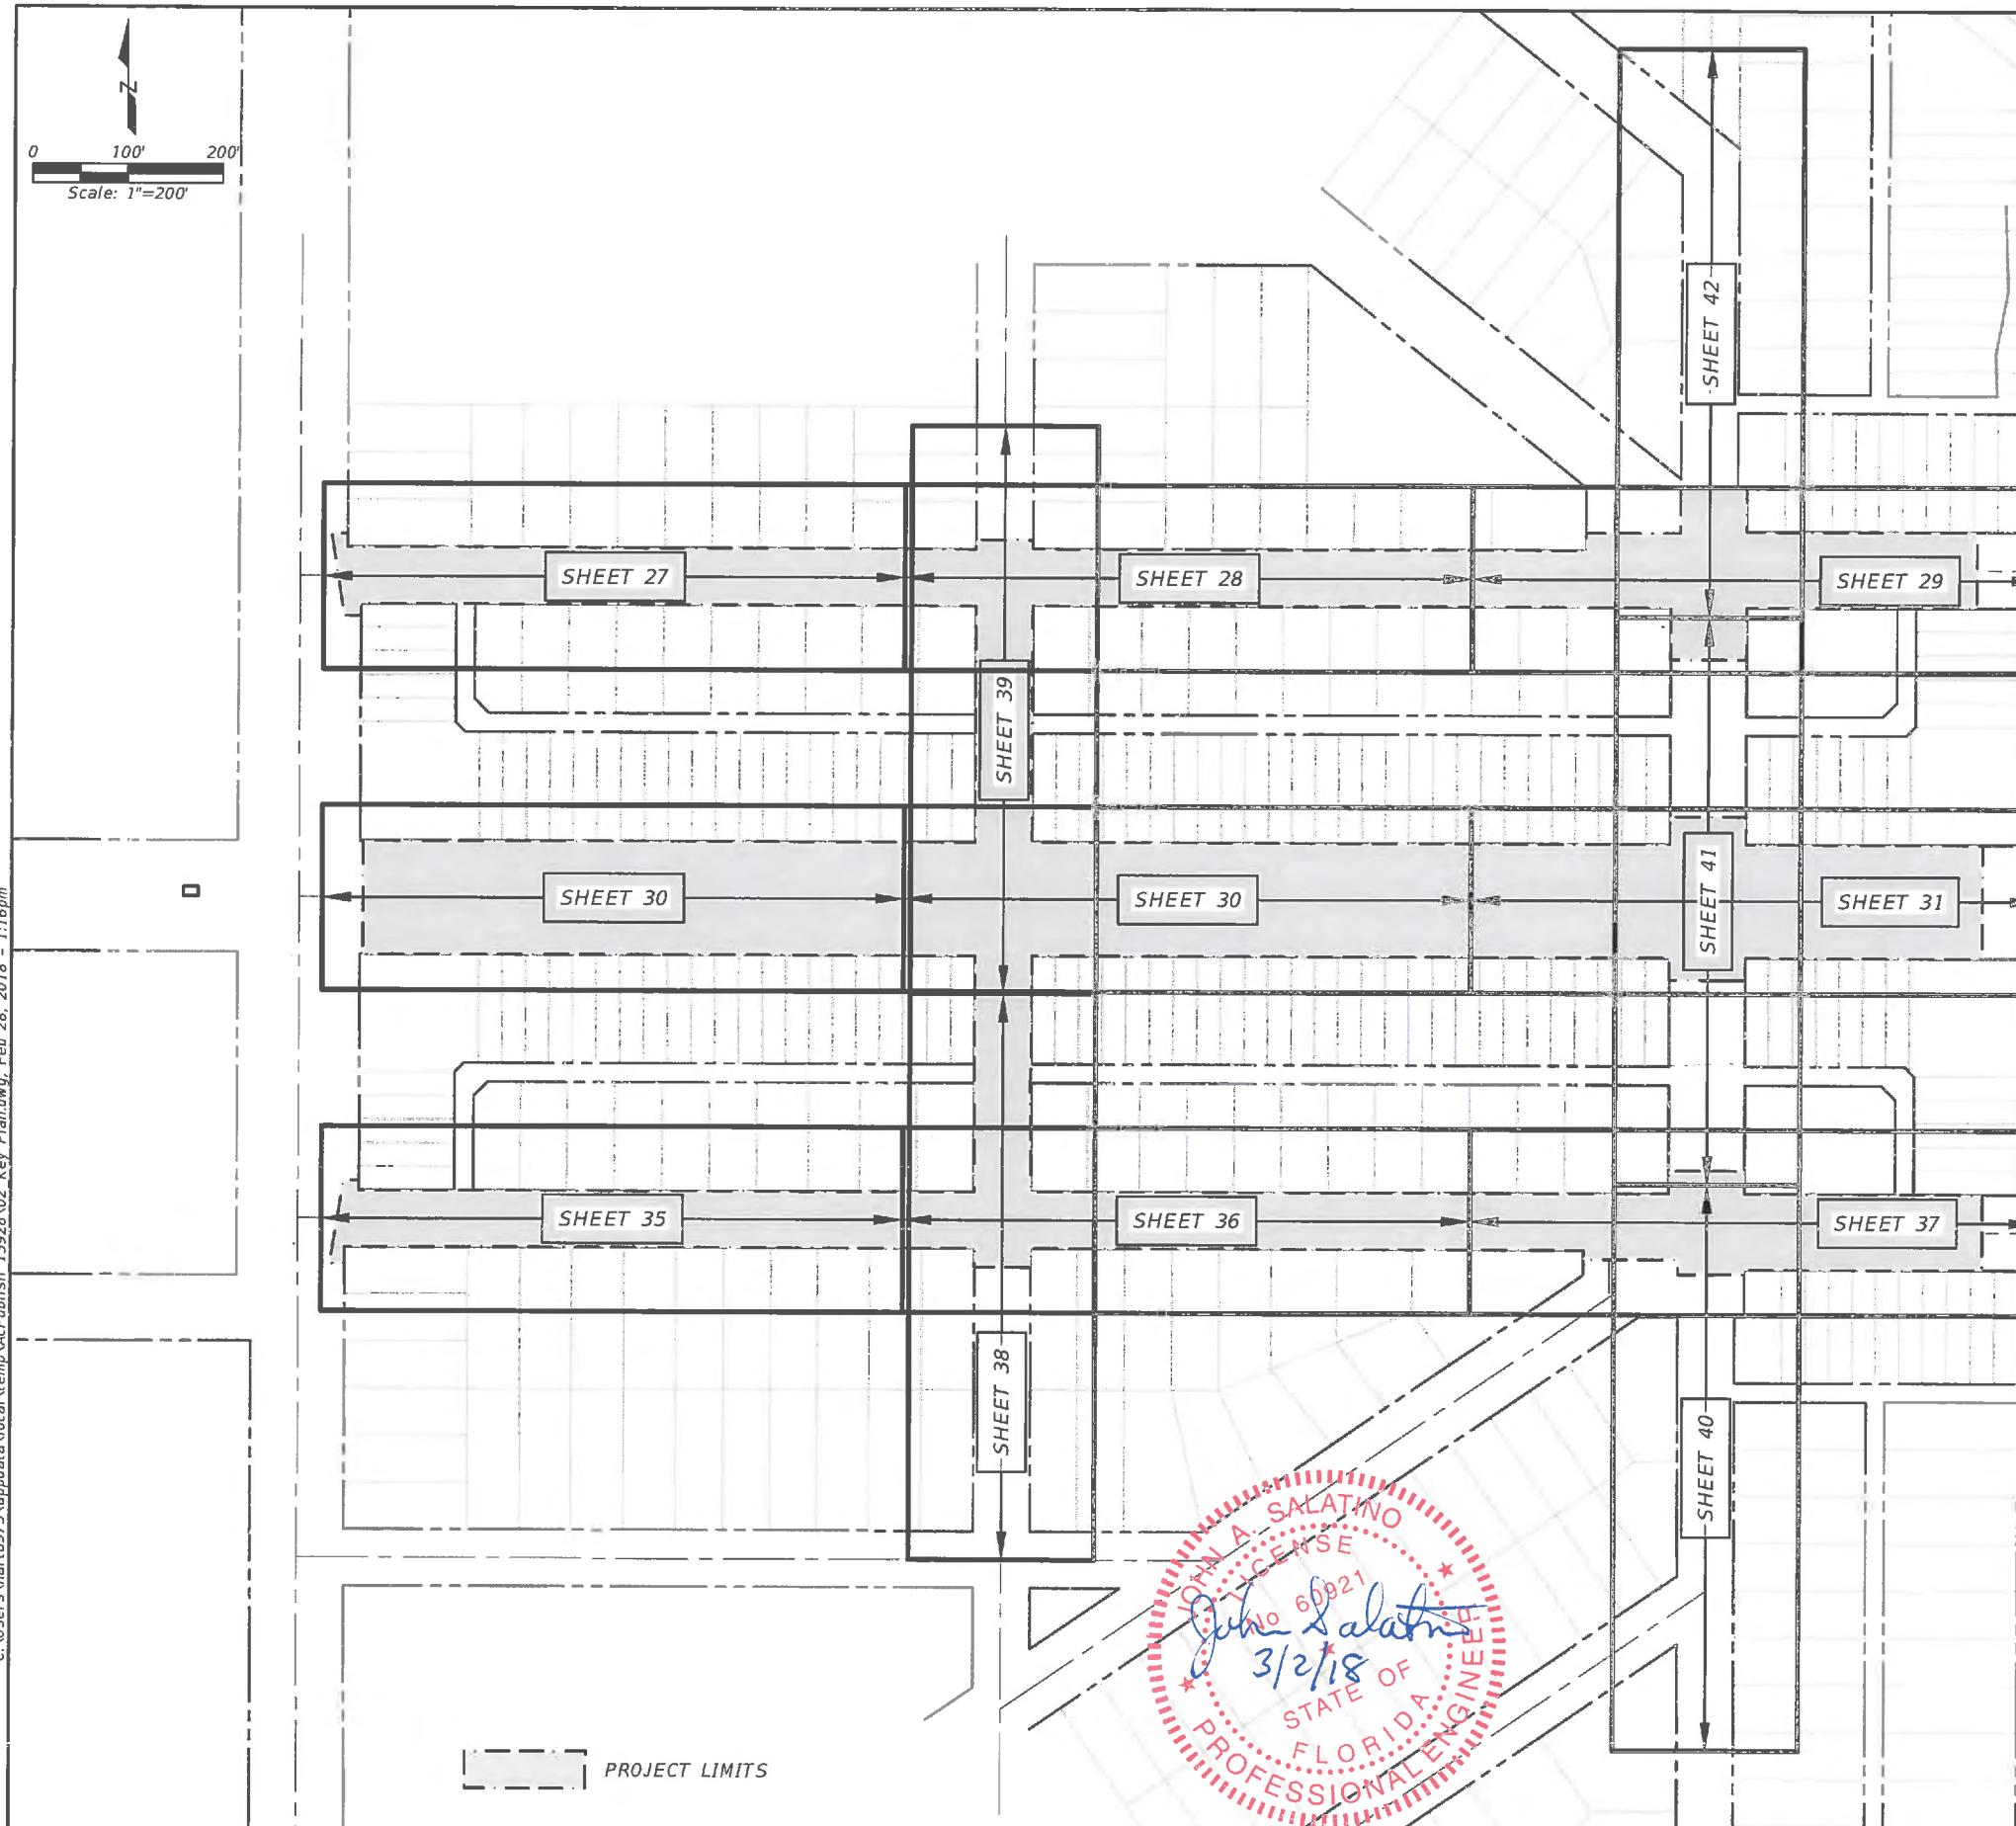FIELD SURVEY LEGEND:

- Back Flow Preventer
- Water Valve
- Fire Hydrant
- Wood Power Pole
- Concrete Power Pole
- Electric Hand Held
- Sprinkler Head
- Above Ground Water Meter
- ↑ Guy Wire & Anchor
- ⊗ Bollard
- ⊗ Gas Meter
- TP Telephone Manhole
- ☒ Water Service
- Overhead Power Lines
- ADA Access Ramp
- Drainage Structure
- Flow Line
- 0.0 Spot Elevation
- ☒ Cable Service
- Park Bench
- \* Electric Outlet Post
- Roof Drain End
- Traffic Hand Held
- Traffic Control Pole
- Planter & Statue
- Concrete Pedestal
- Flag Pole
- Well
- In Ground Light
- Metal Awning Support
- ↑ Above Ground Light
- SS Sanitary Manhole
- SM Storm Sewer Manhole
- Phone Riser
- \* Light Pole
- ☒ Irrigation Valve Box
- Street Sign
- 2'x2' Wood Trash Enclosure
- CP Clay Pipe
- RCP Reinforced Concrete Pipe
- Overhang
- S Sewer Valve
- Fire Department Control
- Light Pole in Planter
- Sewer Service
- R Reuse Valve
- EP Edge of Pavement

TREE LEGEND

- PALM TREE
- OAK TREE
- PINE TREE
- WILLOW TREE
- CEDAR TREE
- UNKNOWN TREE
- PYGMY PALM DATE

DESIGNED	PREPARED FOR:	PREPARED BY:	PROJECT:	DESCRIPTION:	APPROVED BY:	DATE:
DRAWN	Venice, FL City on the Gulf	ATKINS	CITY OF VENICE DOWNTOWN ROADWAY CORRIDOR IMPROVEMENTS	KEY PLAN	JOHN SALATINO, P.E. P.E. LICENSE NUMBER 60921 ATKINS NORTH AMERICA (CERT. OF AUTH. NO. 24) 4030 WEST BOY SCOUT BOULEVARD, SUITE 700 TAMPA, FL 33607-1712	2/28/2018
CHECKED	MA	MLM	REV. NO.	DATE	DESCRIPTION	PROJECT NO.: 100054389




0  
100'  
200'  
Scale: 1"=200'




MANHOLE NOTE: FOR PLAN CLARITY, PROPOSED STORM SEWER MANHOLES ARE NOT ALL LABELED ON THIS MAP. SEE PLAN-PROFILE SHEETS FOR THESE STRUCTURES.

**LEGEND**  
 — PROPOSED STORMWATER PIPE  
 - EXISTING STORMWATER PIPE  
 — CATCHMENT DIVIDES


			DESIGNED MLM	DRAWN MA	PREPARED FOR: 	PREPARED BY: <b>ATKINS</b>	PROJECT: CITY OF VENICE DOWNTOWN ROADWAY CORRIDOR IMPROVEMENTS	DESCRIPTION: DRAINAGE MAP	APPROVED BY: JOHN SALATINO, P.E. P.E. LICENSE NUMBER 60921 ATKINS NORTH AMERICA (CERT. OF AUTH. NO. 24) 4030 WEST BOY SCOUT BOULEVARD, SUITE 700 TAMPA, FL 33607-1712	DATE: 2/28/2018	
Page 892 of 1140	REV. NO.	DATE	DESCRIPTION							PROJECT NO.: 100054389	SHEET: 3

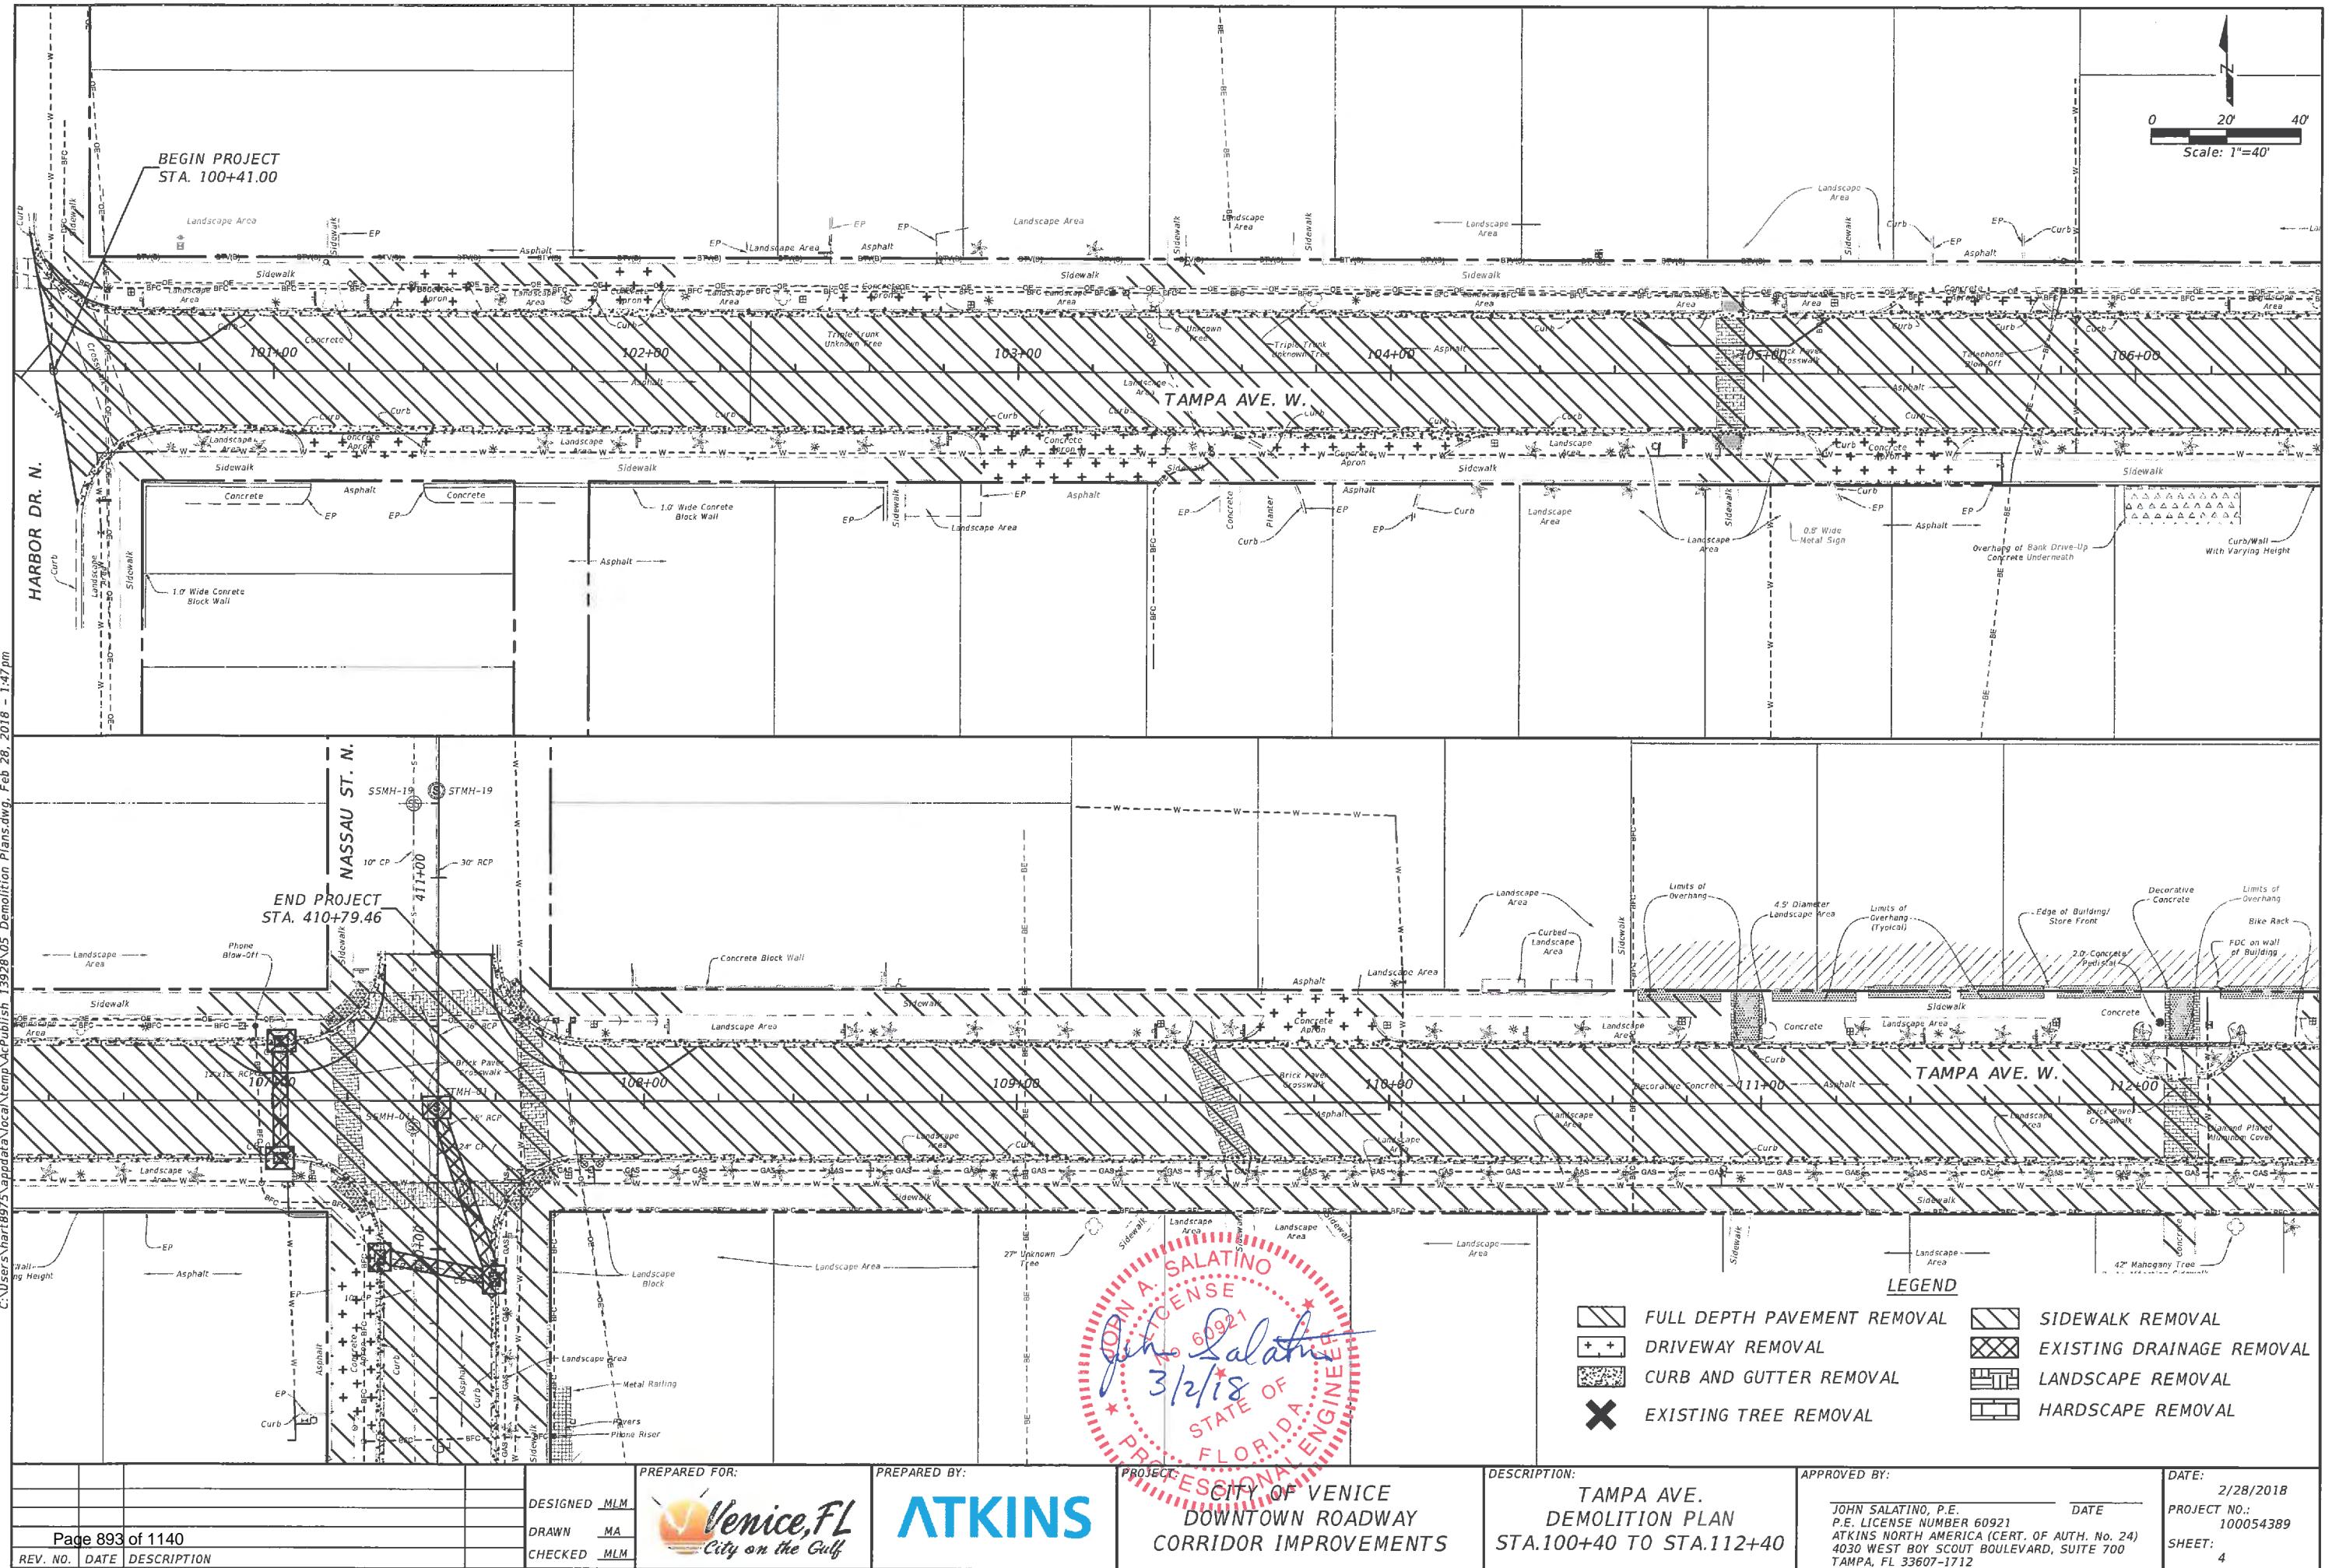


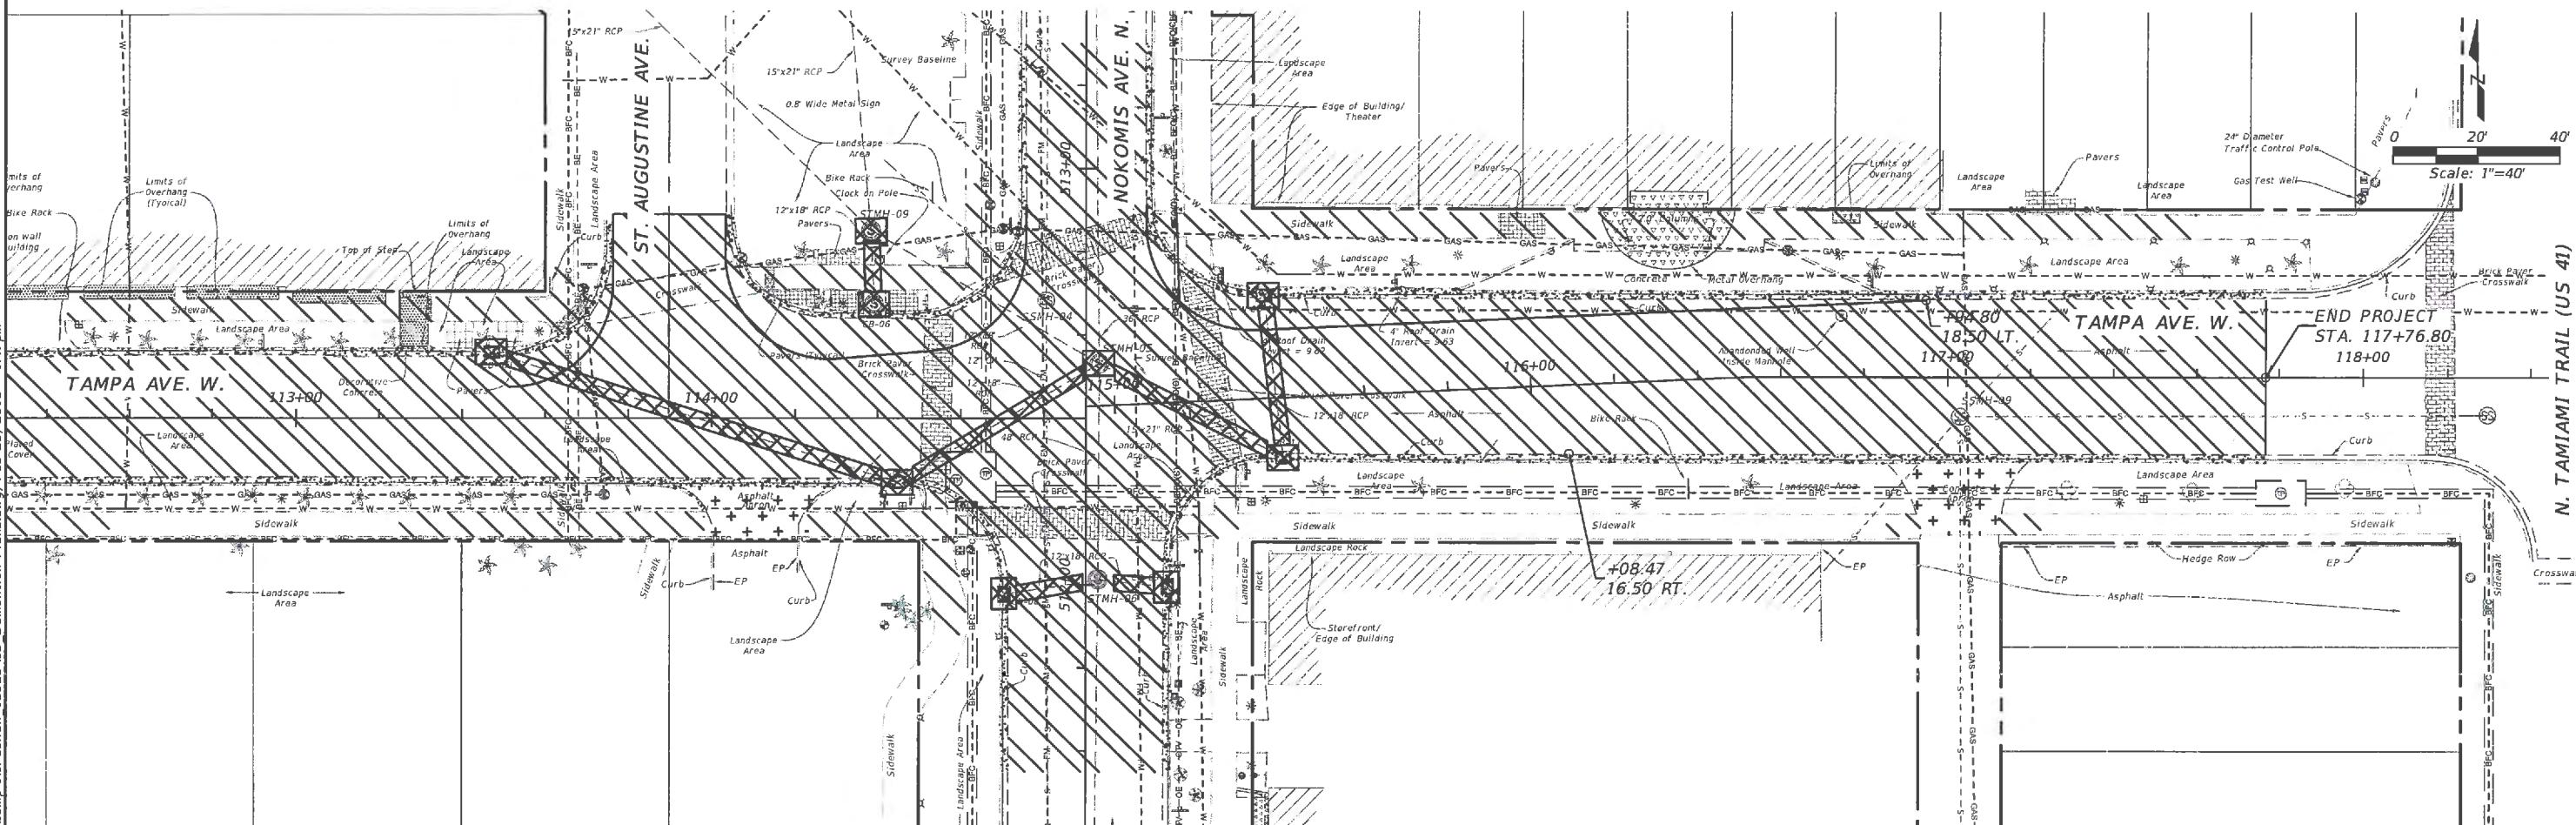LEGEND


- |  |                             |  |                           |
|--|-----------------------------|--|---------------------------|
|  | FULL DEPTH PAVEMENT REMOVAL |  | SIDEWALK REMOVAL          |
|  | DRIVEWAY REMOVAL            |  | EXISTING DRAINAGE REMOVAL |
|  | CURB AND GUTTER REMOVAL     |  | LANDSCAPE REMOVAL         |
|  | EXISTING TREE REMOVAL       |  | HARDSCAPE REMOVAL         |

			DESIGNED <u>MLM</u>	DRAWN <u>MA</u>	PREPARED FOR: Venice, FL	PREPARED BY: ATKINS	PROJECT: CITY OF VENICE DOWNTOWN ROADWAY CORRIDOR IMPROVEMENTS	DESCRIPTION: TAMPA AVE. DEMOLITION PLAN STA.112+40 TO STA.118+40	APPROVED BY: JOHN SALATINO, P.E. P.E. LICENSE NUMBER 60921 ATKINS NORTH AMERICA (CERT. OF AUTH. NO. 24) 4030 WEST BOY SCOUT BOULEVARD, SUITE 700 TAMPA, FL 33607-1712	DATE: 2/28/2018	
Page 894	of 1140		REV. NO.	DATE	DESCRIPTION					PROJECT NO.: 100054389	SHEET: 5

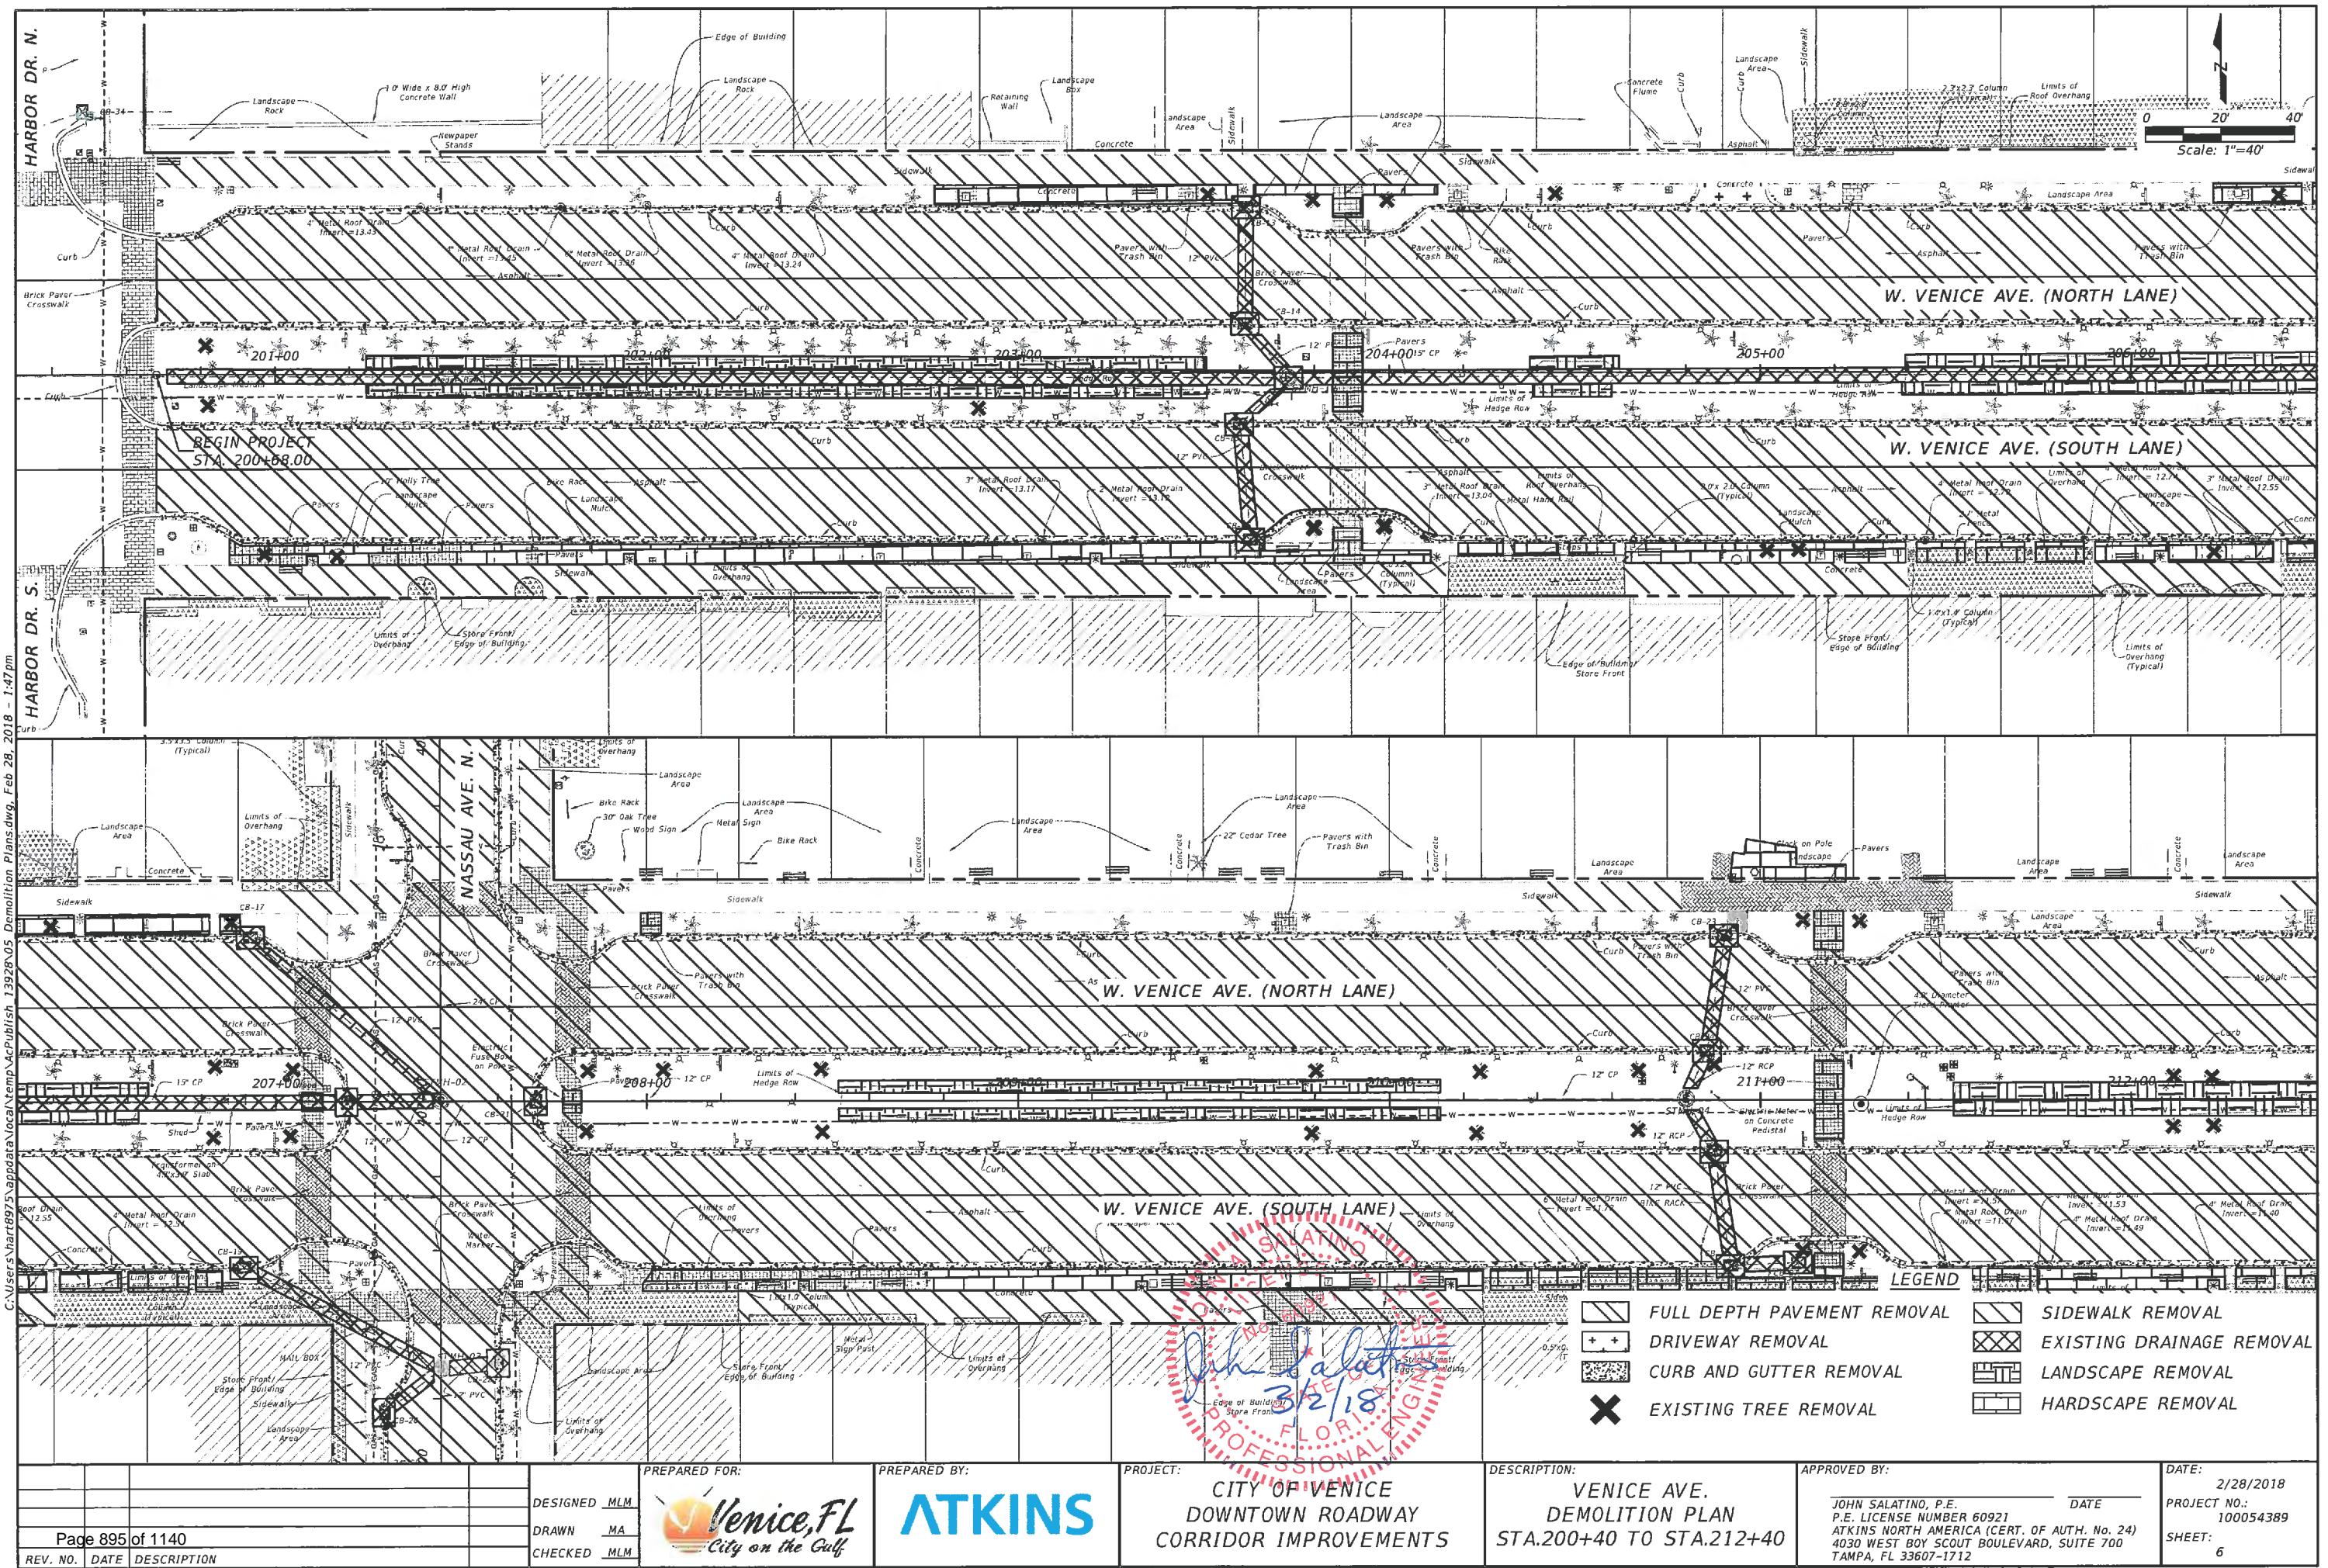

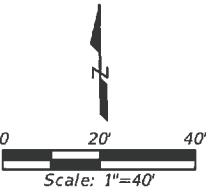


Scale: 1"=40'

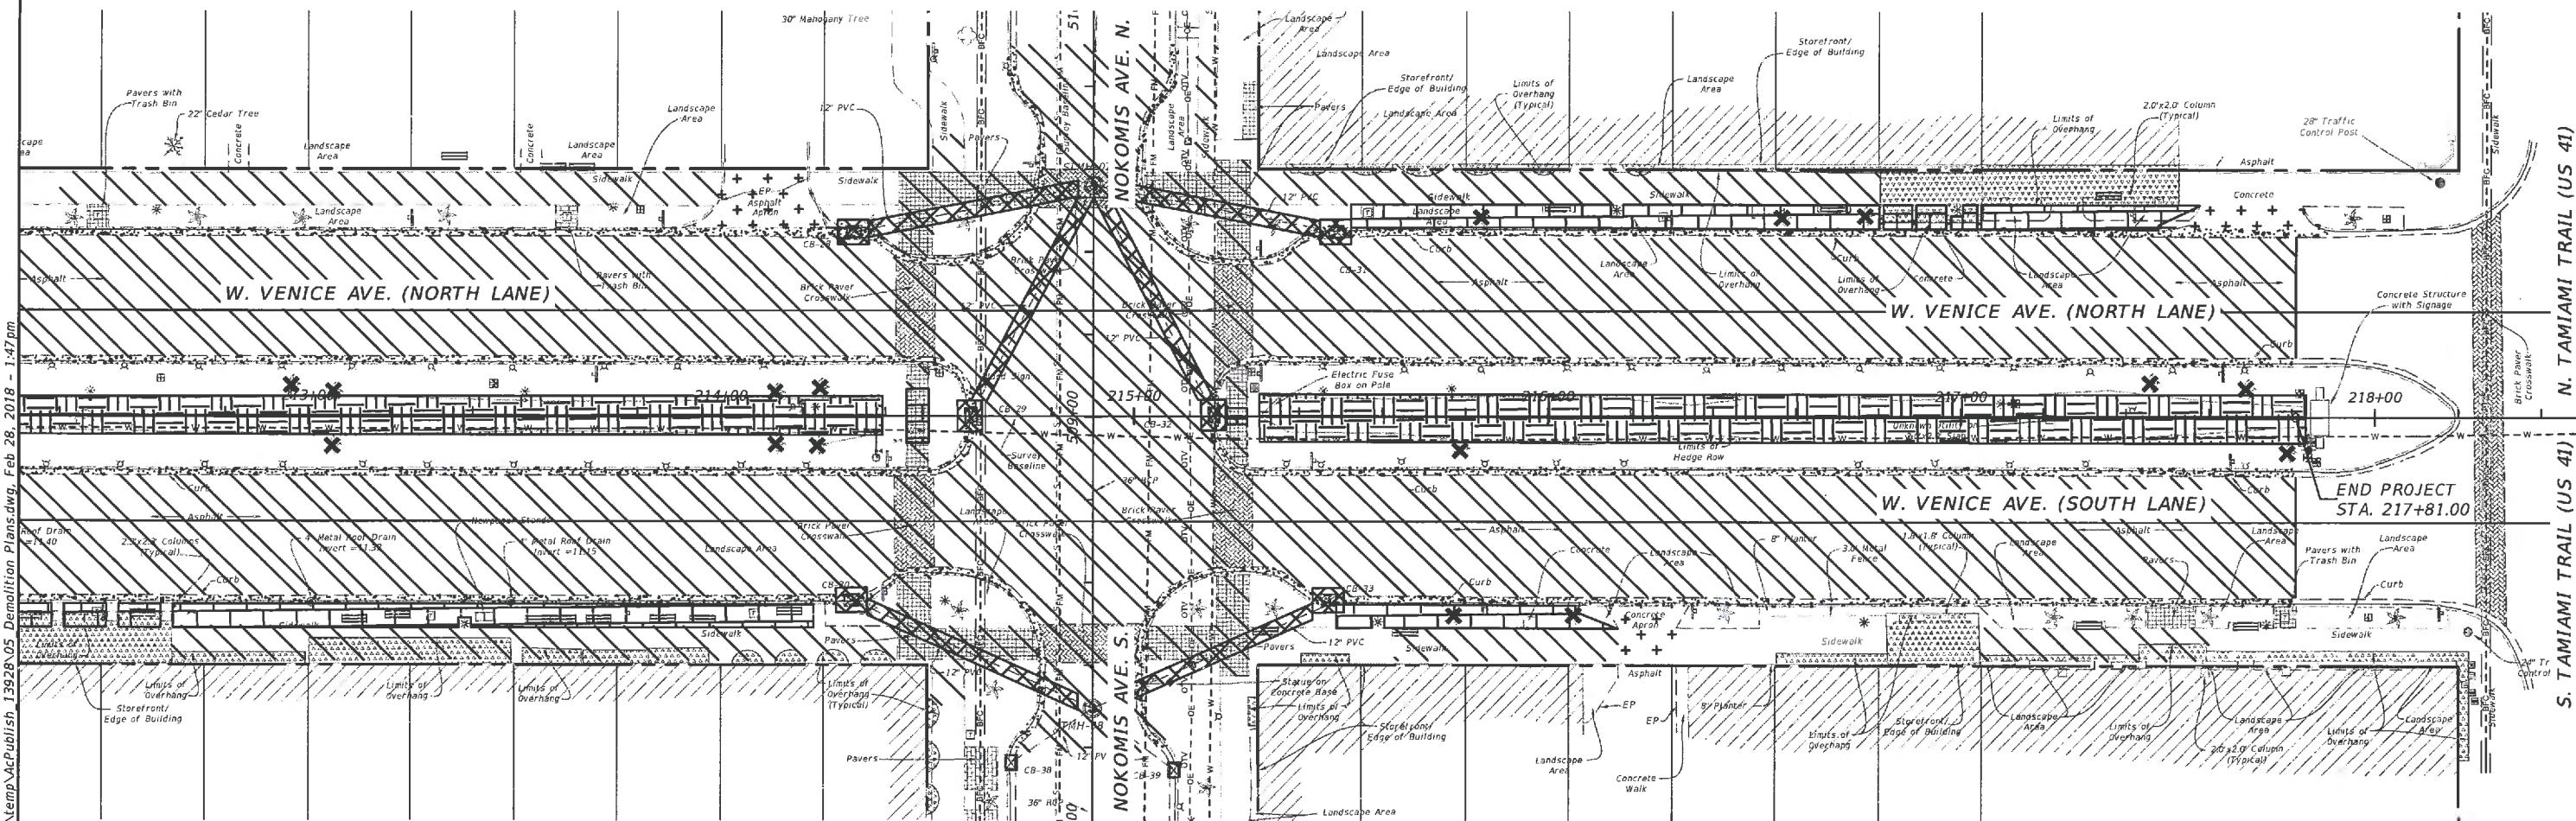


LEGEND

- |  |                             |  |                           |
|--|-----------------------------|--|---------------------------|
|  | FULL DEPTH PAVEMENT REMOVAL |  | SIDEWALK REMOVAL          |
|  | DRIVEWAY REMOVAL            |  | EXISTING DRAINAGE REMOVAL |
|  | CURB AND GUTTER REMOVAL     |  | LANDSCAPE REMOVAL         |
|  | EXISTING TREE REMOVAL       |  | HARDSCAPE REMOVAL         |

PREPARED FOR:	PREPARED BY:	PROJECT:	DESCRIPTION:	APPROVED BY:	DATE:
DESIGNED MLM DRAWN MA CHECKED MLM	PREPARED BY: Atkins	PROJECT: CITY OF VENICE DOWNTOWN ROADWAY CORRIDOR IMPROVEMENTS	DESCRIPTION: VENICE AVE. DEMOLITION PLAN STA.212+40 TO STA.218+40	JOHN SALATINO, P.E. P.E. LICENSE NUMBER 60921 ATKINS NORTH AMERICA (CERT. OF AUTH. NO. 24) 4030 WEST BOY SCOUT BOULEVARD, SUITE 700 TAMPA, FL 33607-1712	2/28/2018 PROJECT NO.: 100054389 SHEET: 7
Page 896 of 1140					

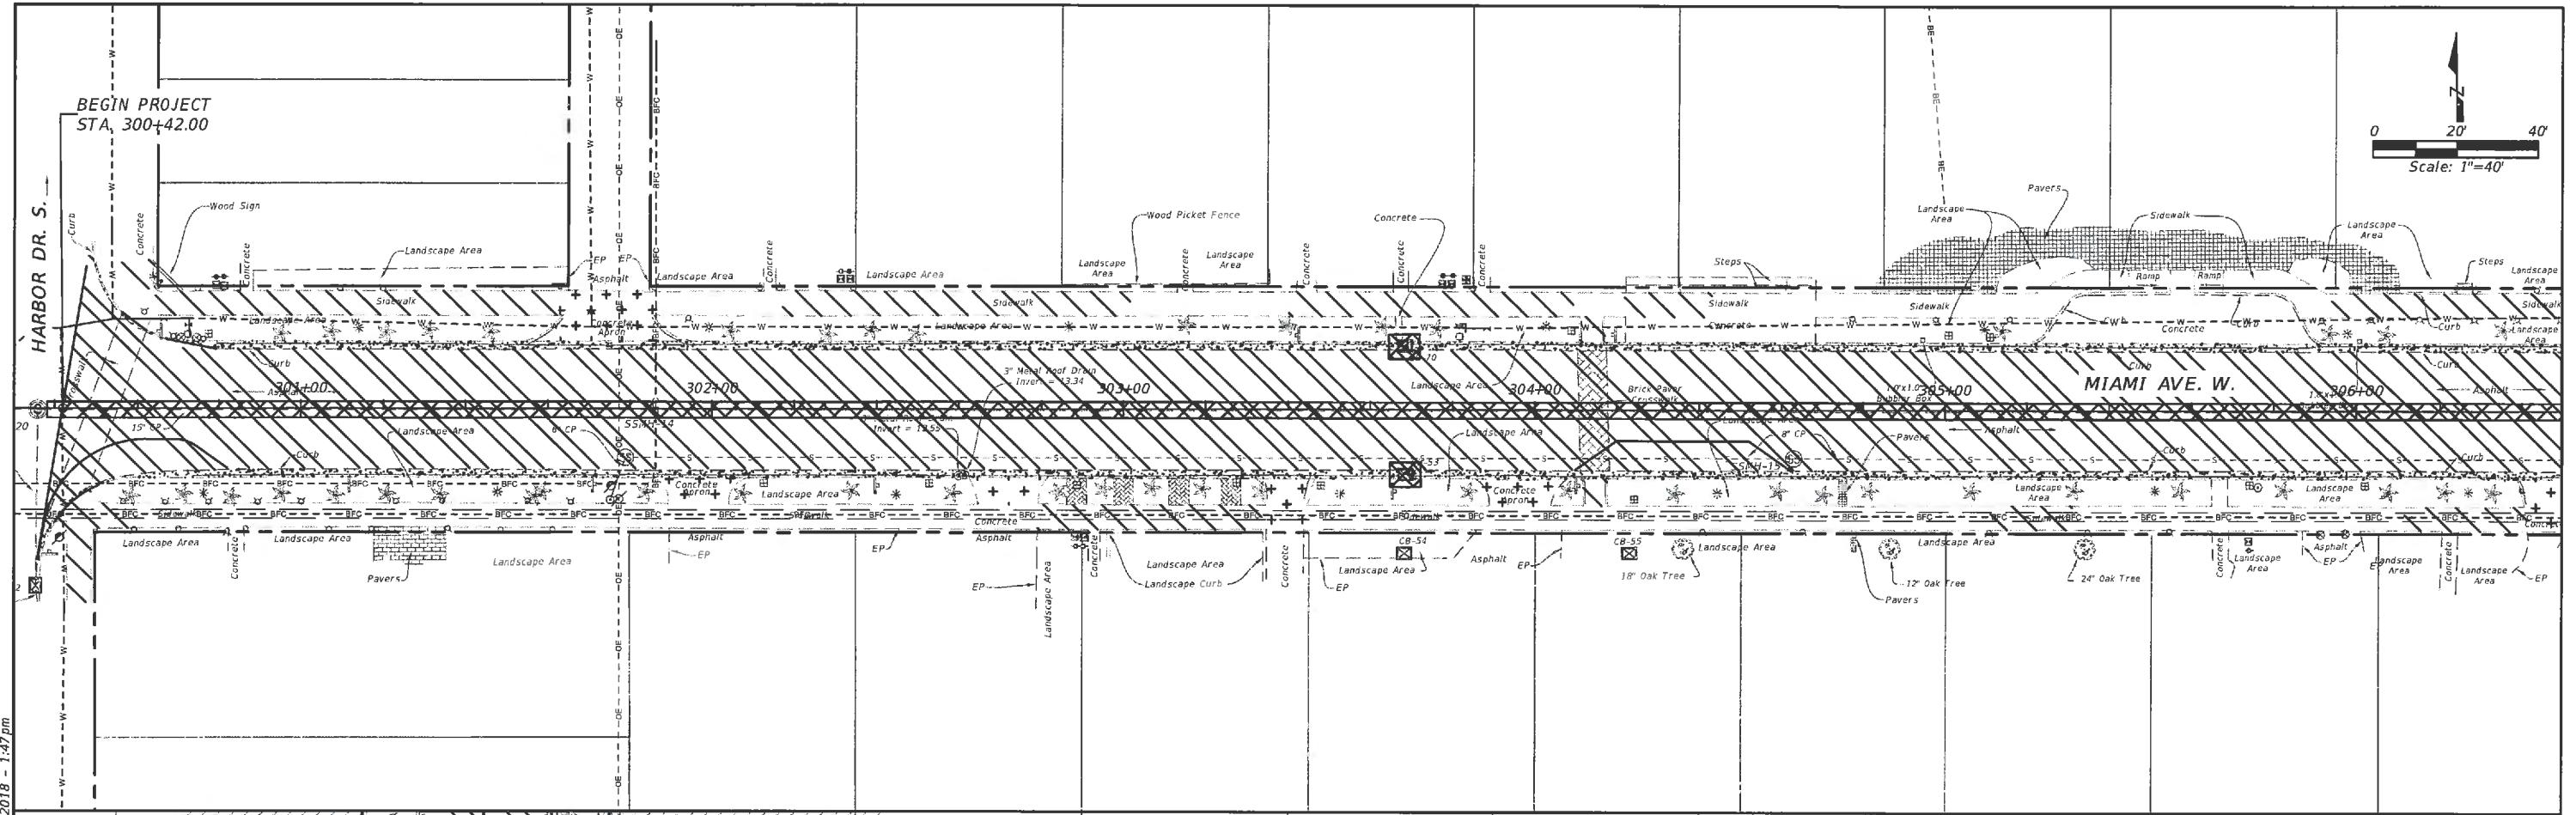


C:\Users\har895\appdata\local\temp\>publish 13628.05 Demolition Plans.dwg, Feb 28, 2018 - 1:47 pm

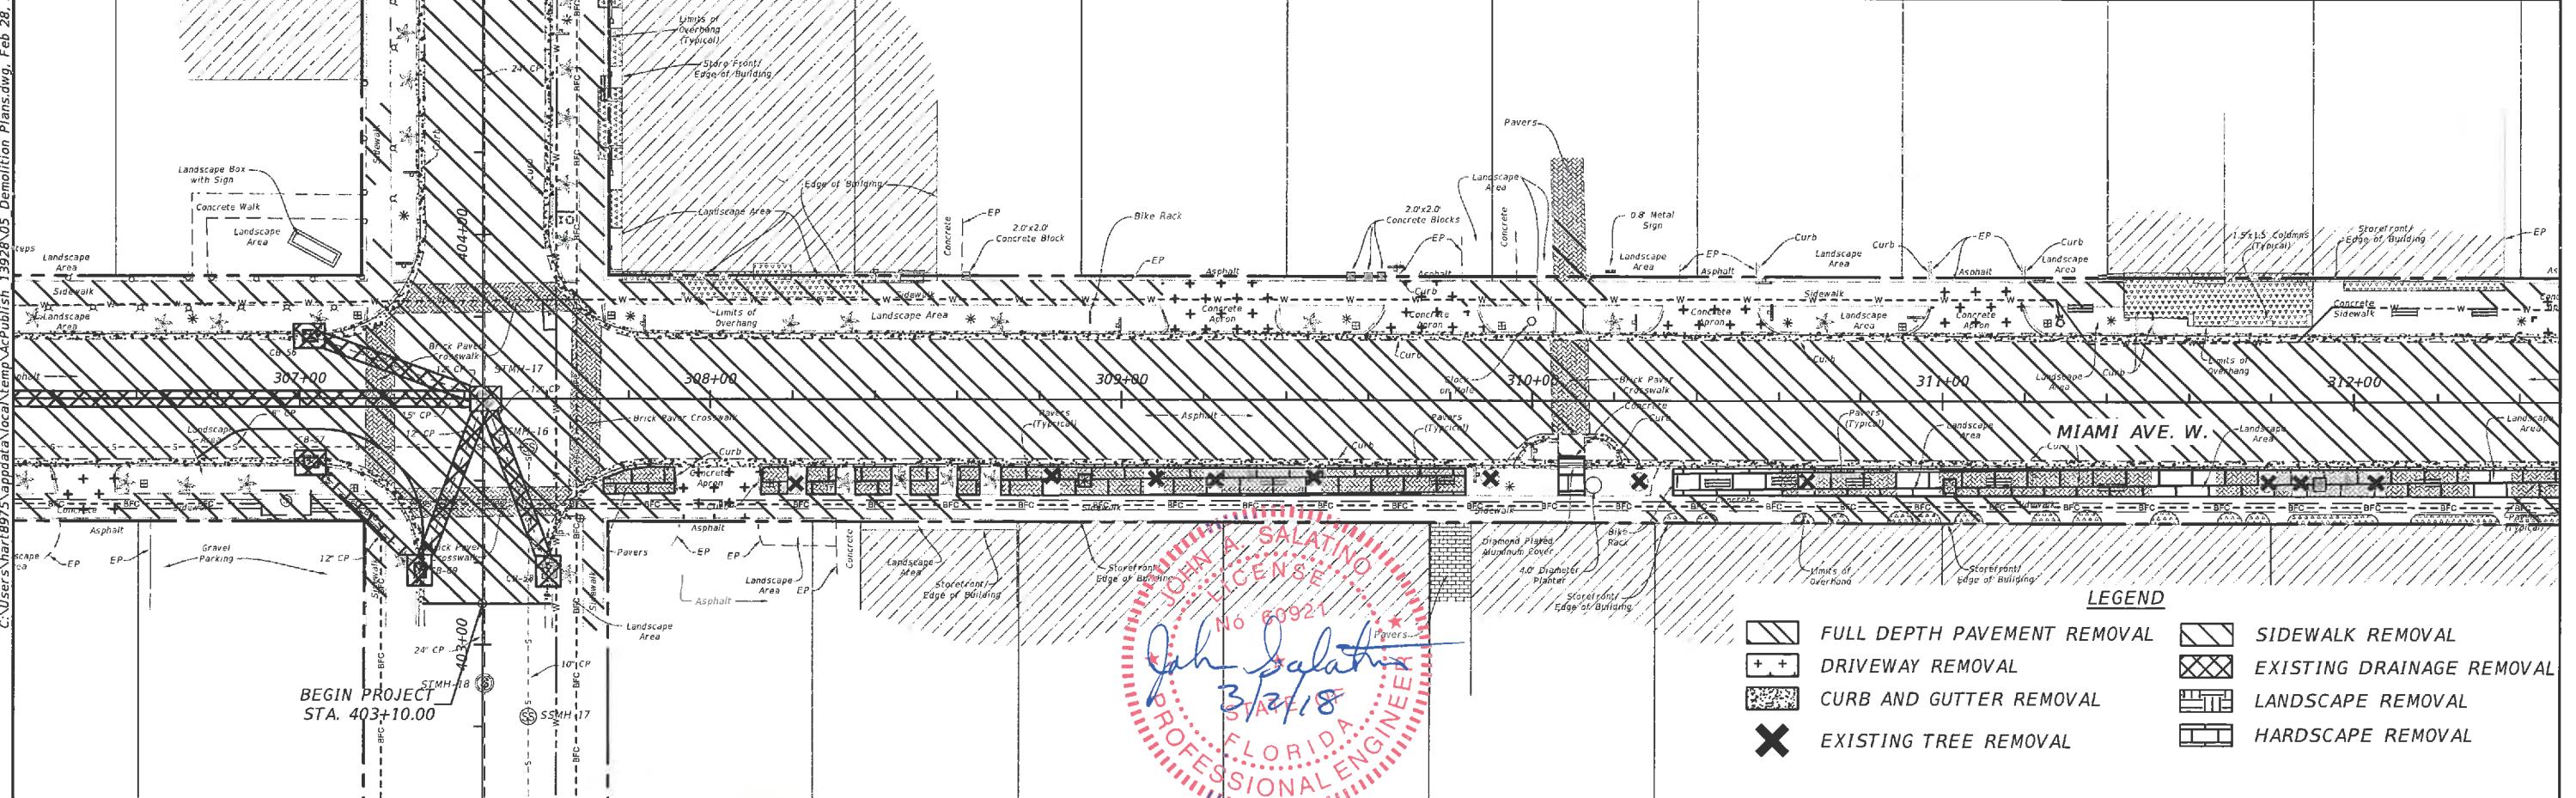

PREPARED FOR:	PREPARED BY:	PROJECT:	DESCRIPTION:	APPROVED BY:	DATE:
DESIGNED MLM	DRAWN MA	ATKINS	CITY OF VENICE DOWNTOWN ROADWAY CORRIDOR IMPROVEMENTS	MIAMI AVE. DEMOLITION PLAN STA.300+40 TO STA.312+40	2/28/2018
REVIEWED MLM	MAILED MA			JOHN SALATINO, P.E. P.E. LICENSE NUMBER 60921 ATKINS NORTH AMERICA (CERT. OF AUTH. NO. 24) 4030 WEST BOY SCOUT BOULEVARD, SUITE 700 TAMPA, FL 33607-1712	PROJECT NO.: 100054389
Page 897 of 1140	REV. NO. DATE DESCRIPTION				SHEET: 8

\\Users\\hart8975\\appdata\\local\\temp\\AcPublish 13928\\05 Demolition Plans.dwg, Feb 28, 2018 - 1:47 pm

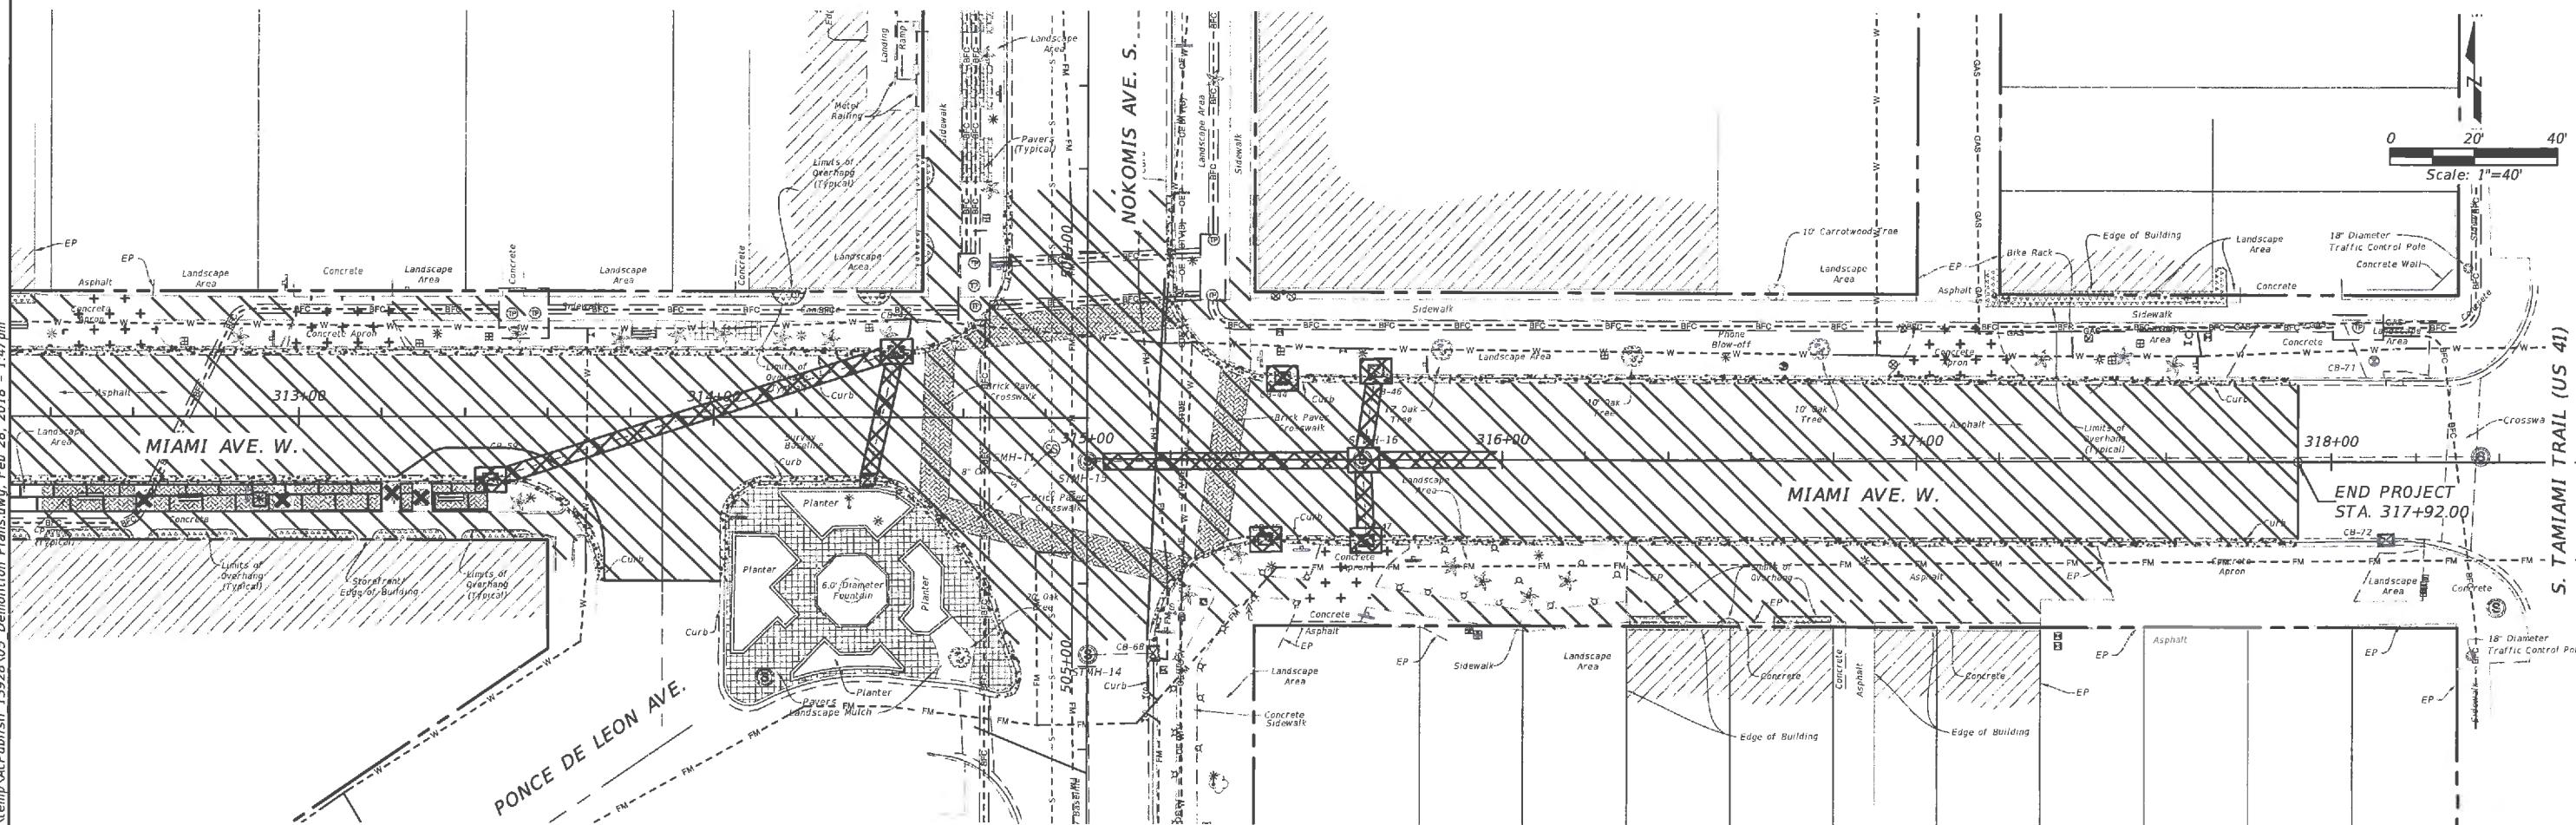

A circular red ink stamp for a Florida Professional Engineer license. The outer ring contains the text "FLORIDA PROFESSIONAL ENGINEER". Inside the ring, at the top, is "JOHN A. SALATINO" and below it "LICENSE". In the center, it says "No. 60921" above the signature. Below the number is the date "3/2/8". There are small stars at the ends of the signature line.



## LEGEND

- |  |                             |  |                           |
|--|-----------------------------|--|---------------------------|
|  | FULL DEPTH PAVEMENT REMOVAL |  | SIDEWALK REMOVAL          |
|  | DRIVEWAY REMOVAL            |  | EXISTING DRAINAGE REMOVAL |
|  | CURB AND GUTTER REMOVAL     |  | LANDSCAPE REMOVAL         |
|  | EXISTING TREE REMOVAL       |  | HARDSCAPE REMOVAL         |


				PREPARED FOR:	PREPARED BY:	PROJECT:	DESCRIPTION:	APPROVED BY:	DATE:
				DESIGNED MLM	DRAWN MA	CITY OF VENICE DOWNTOWN ROADWAY CORRIDOR IMPROVEMENTS	MIAMI AVE. DEMOLITION PLAN STA.312+40 TO STA.318+40	JOHN SALATINO, P.E. _____ DATE P.E. LICENSE NUMBER 60921 ATKINS NORTH AMERICA (CERT. OF AUTH. NO. 24) 4030 WEST BOY SCOUT BOULEVARD, SUITE 700 TAMPA, FL 33607-1712	2/28/2018
Page 898 of 1140				DRAWN MLM	ATKINS			PROJECT NO.:	100054389
REV. NO.	DATE	DESCRIPTION		CHECKED MLM				SHEET:	9

## LEGEND


	FULL DEPTH PAVEMENT REMOVAL
	SIDEWALK REMOVAL
	EXISTING DRAINAGE REMOVAL
	CURB AND GUTTER REMOVAL
	EXISTING TREE REMOVAL
	LANDSCAPE REMOVAL
	HARDSCAPE REMOVAL

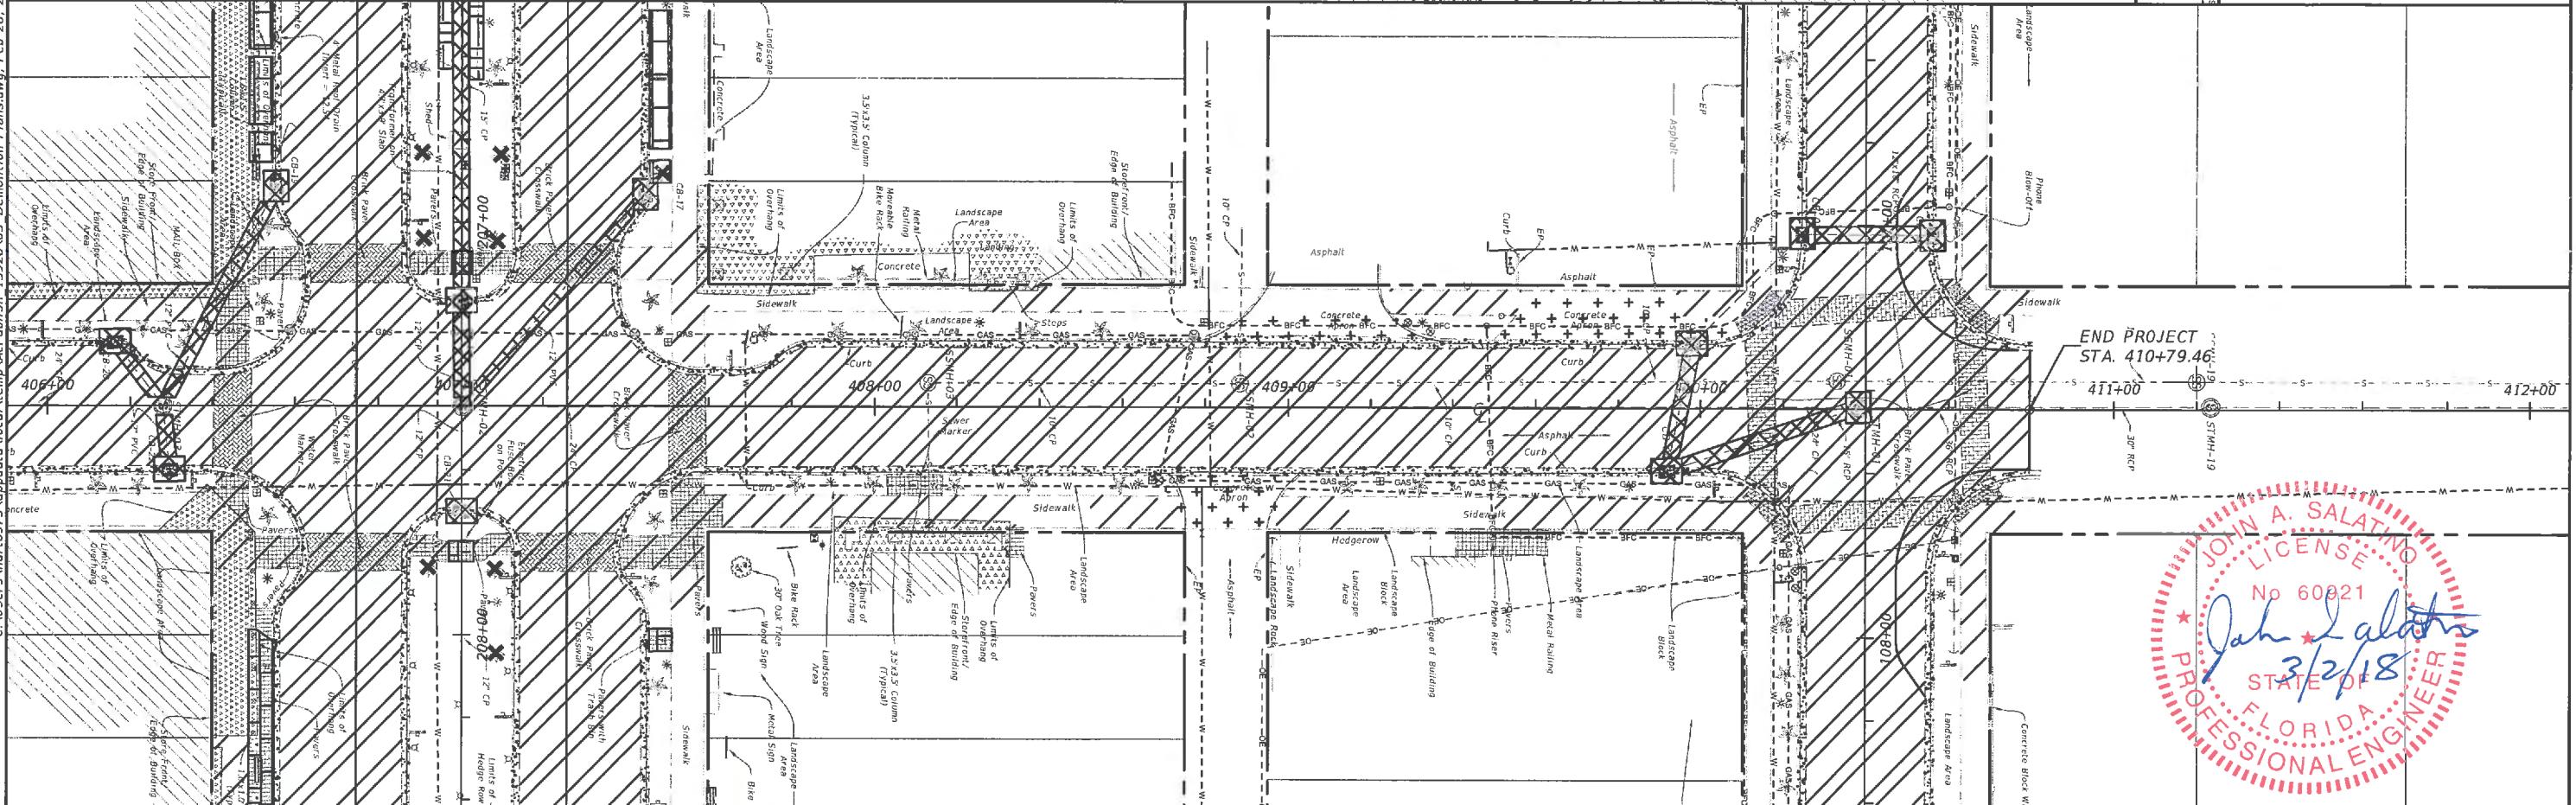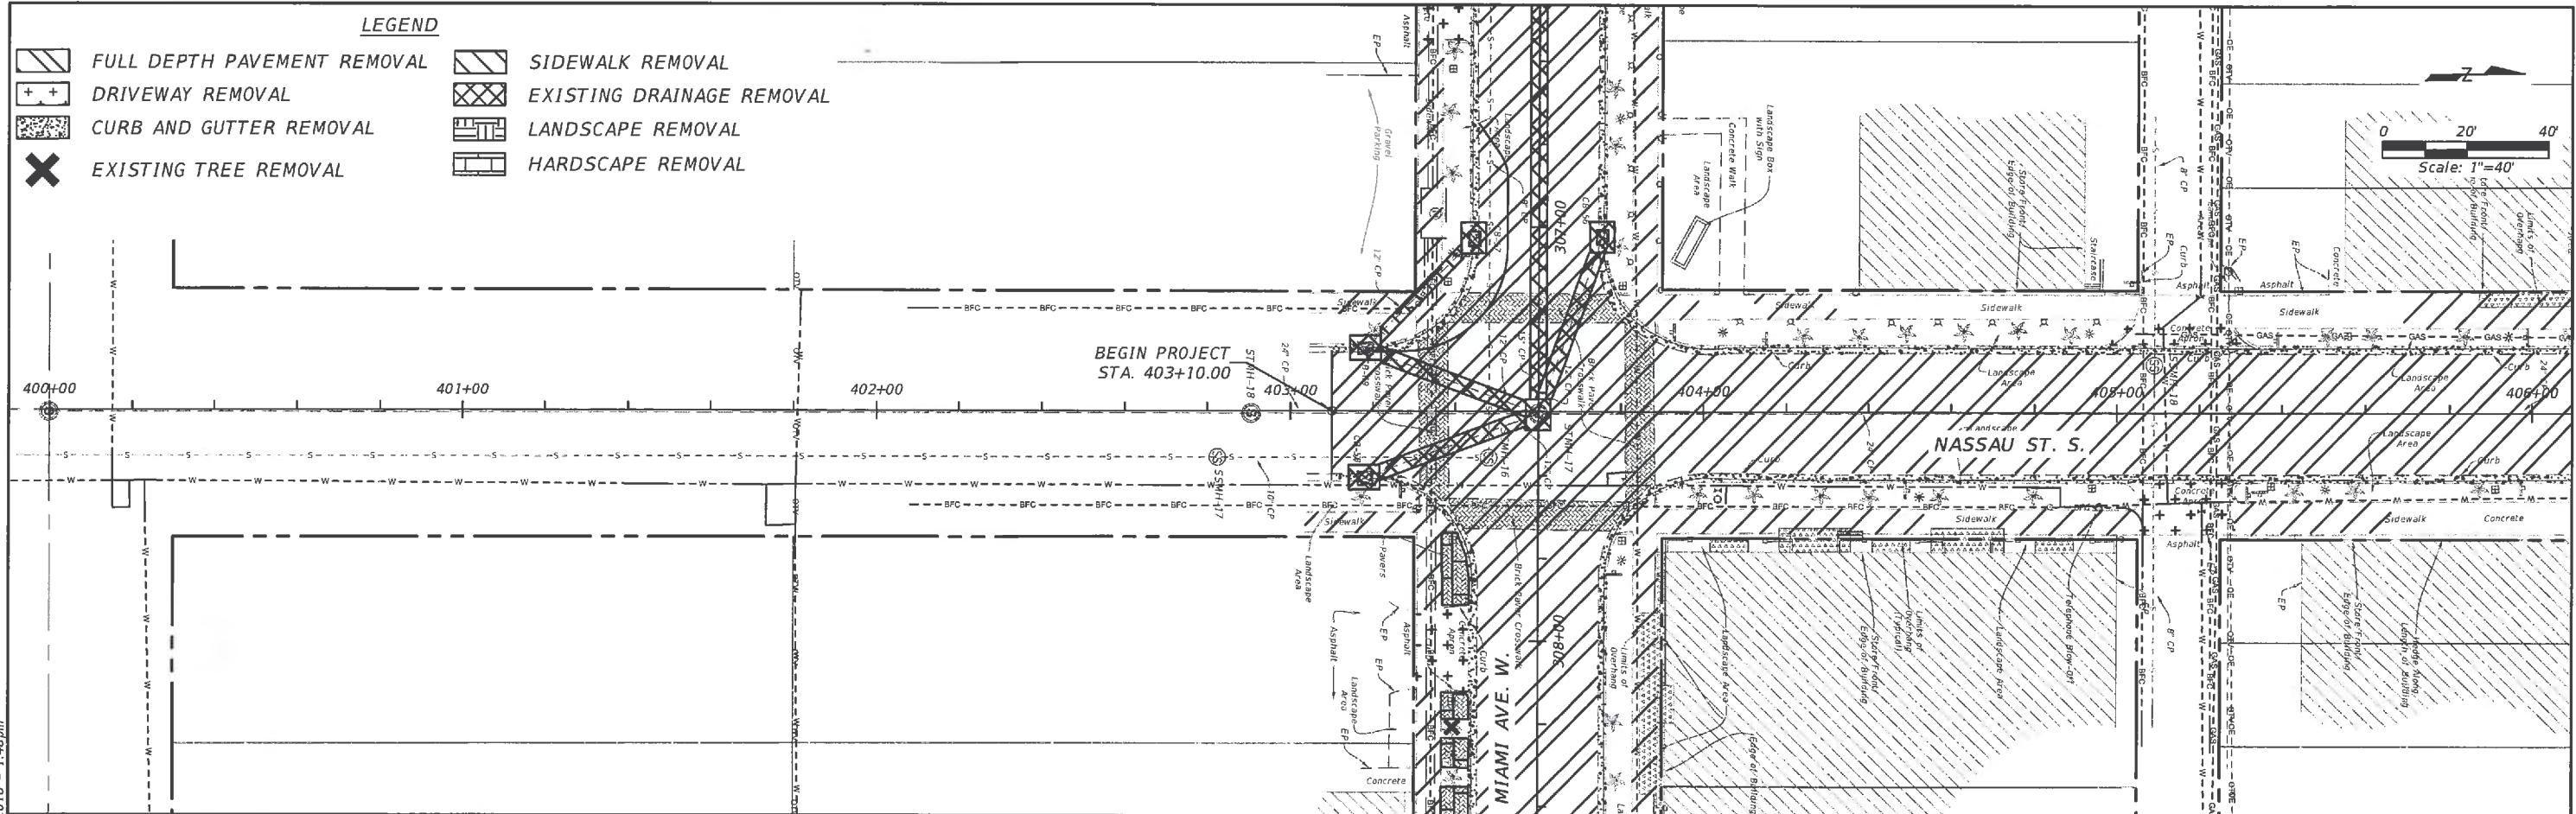

PREPARED FOR:	PREPARED BY:	PROJECT:	DESCRIPTION:	APPROVED BY:	DATE:
DESIGNED MLM	DRAWN MA	ATKINS	CITY OF VENICE DOWNTOWN ROADWAY CORRIDOR IMPROVEMENTS	NASSAU ST. DEMOLITION PLAN STA.400+00 TO STA.412+00	2/28/2018
Page 899 of 1140	Venice, FL City on the Gulf	REV. NO. DATE DESCRIPTION	CHECKED MLM	JOHN SALATINO, P.E. P.E. LICENSE NUMBER 60921 ATKINS NORTH AMERICA (CERT. OF AUTH. NO. 24) 4030 WEST BOY SCOUT BOULEVARD, SUITE 700 TAMPA, FL 33607-1712	DATE PROJECT NO.: 100054389 SHEET: 10

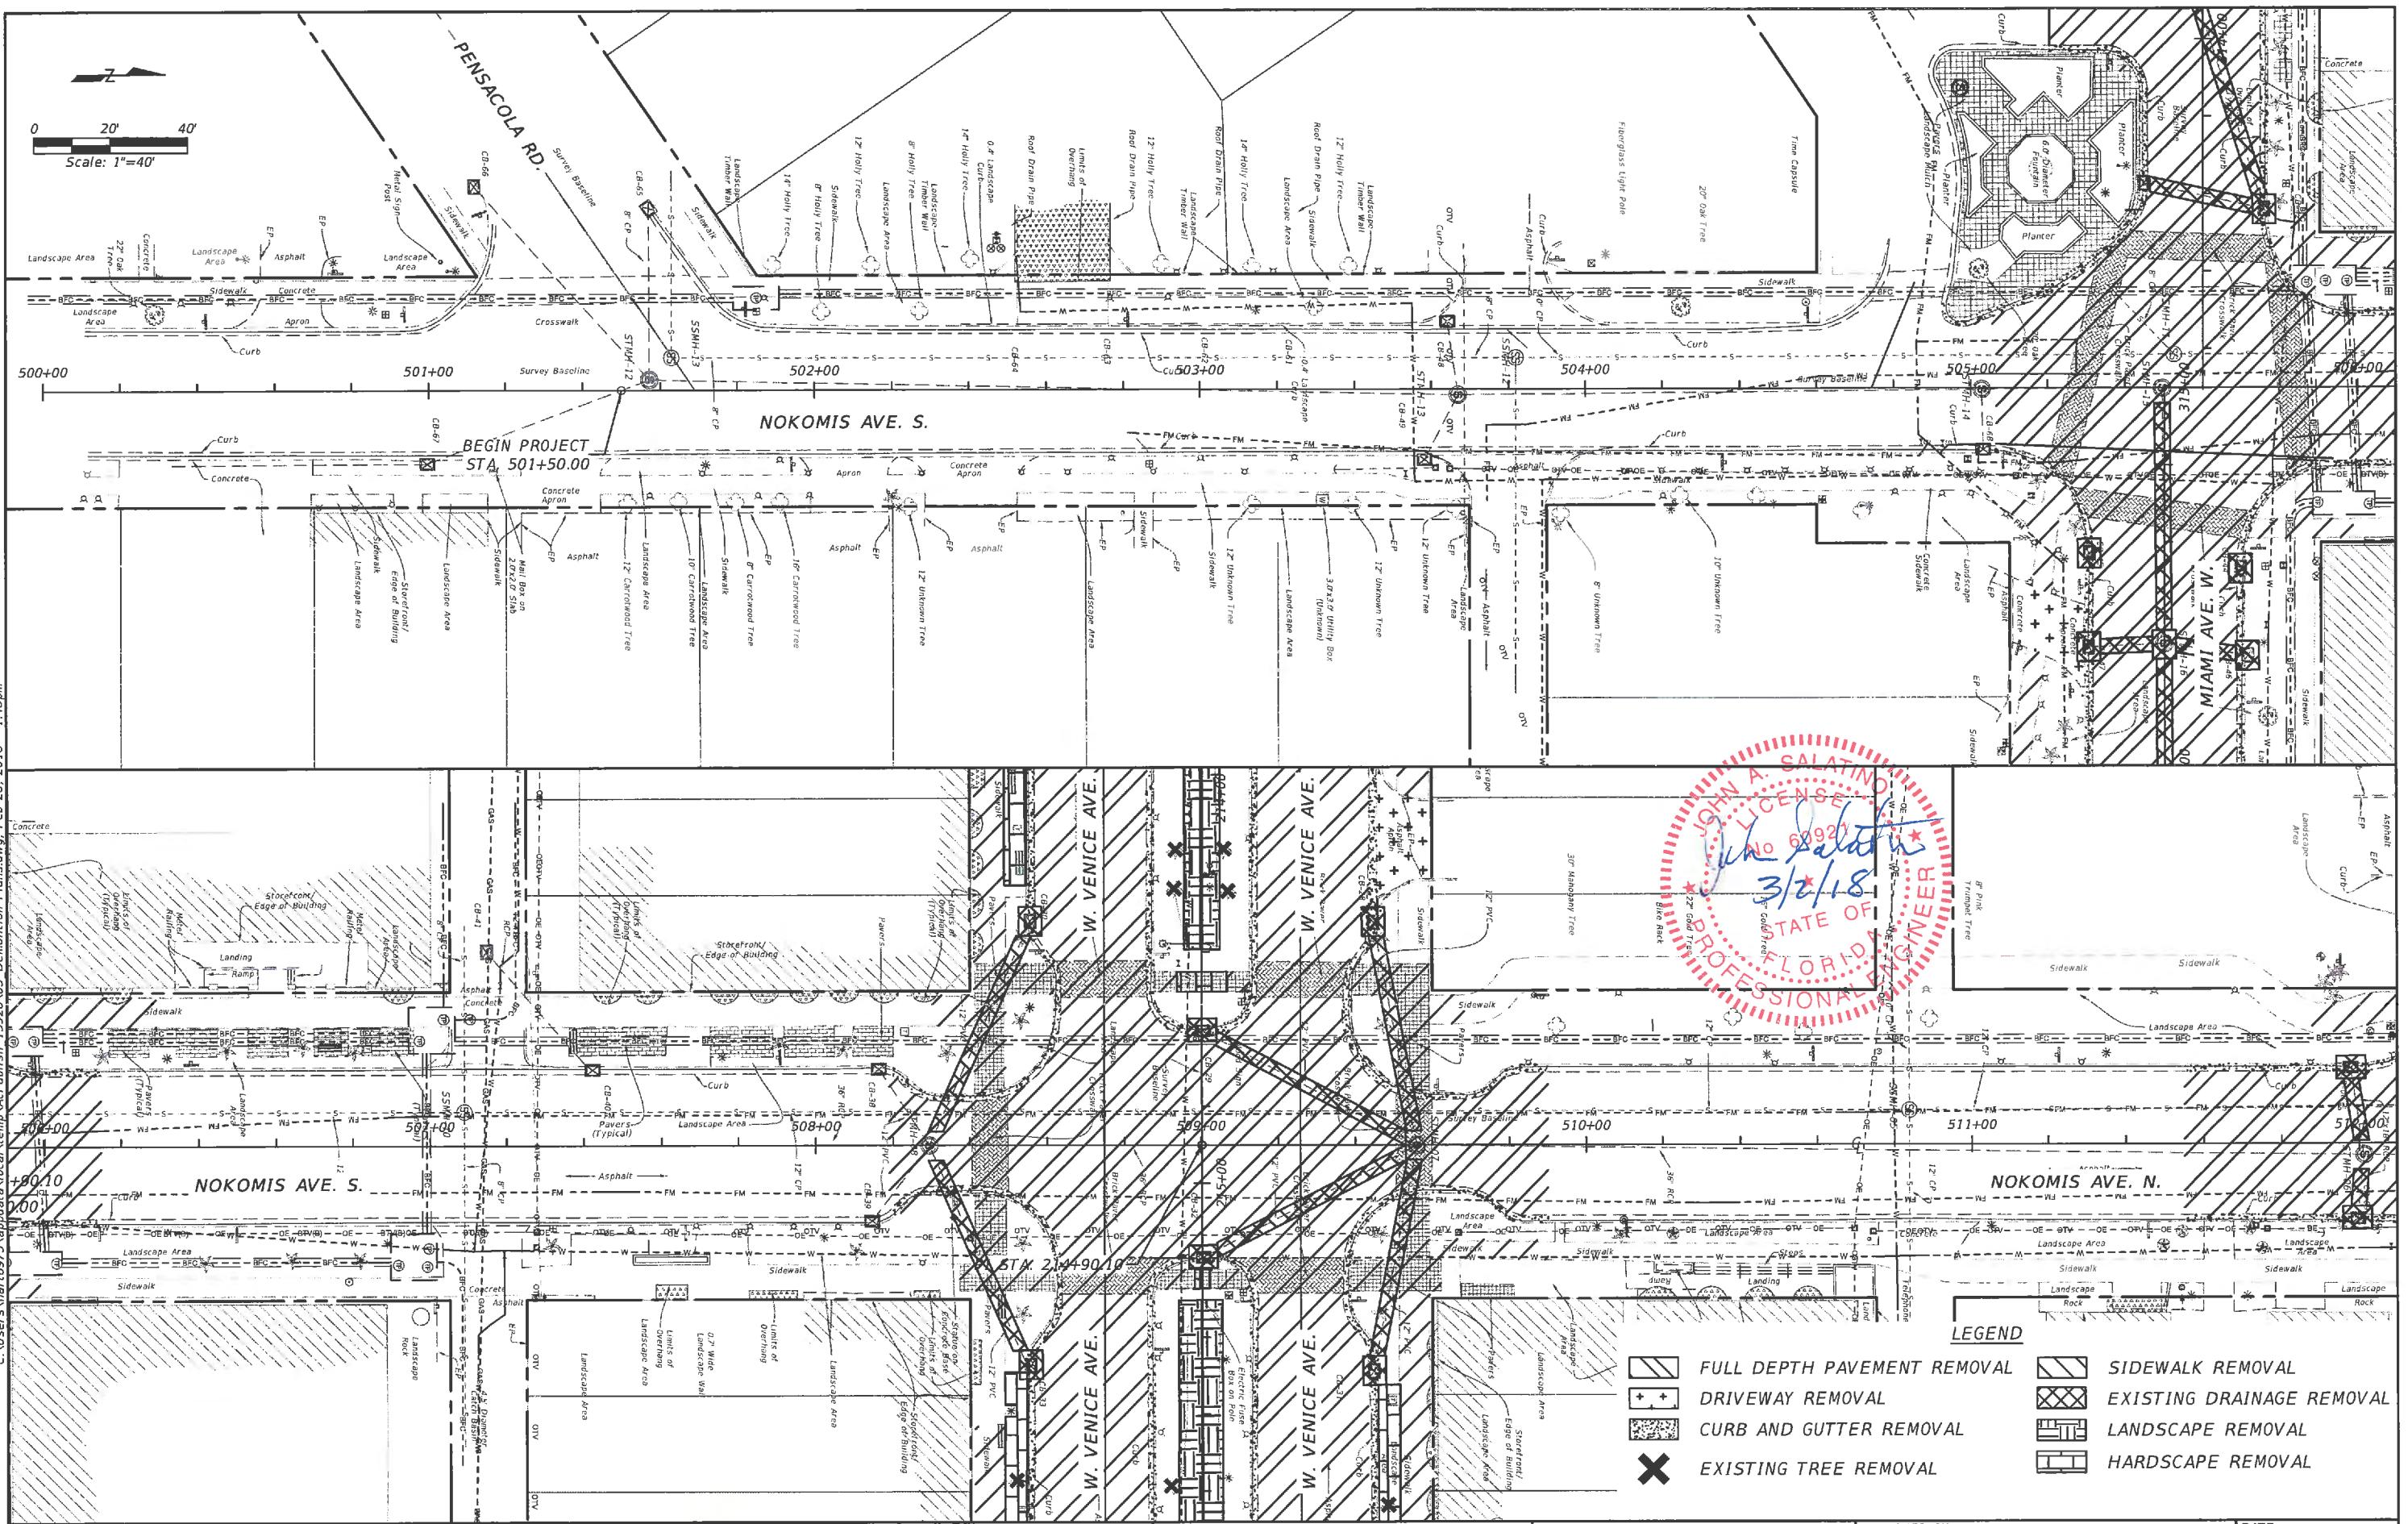


C:\Users\hart8975\appdata\local\temp\AcPublish\_13928\05 Demolition Plans.dwg, Feb 28, 2018 - 1:48pm

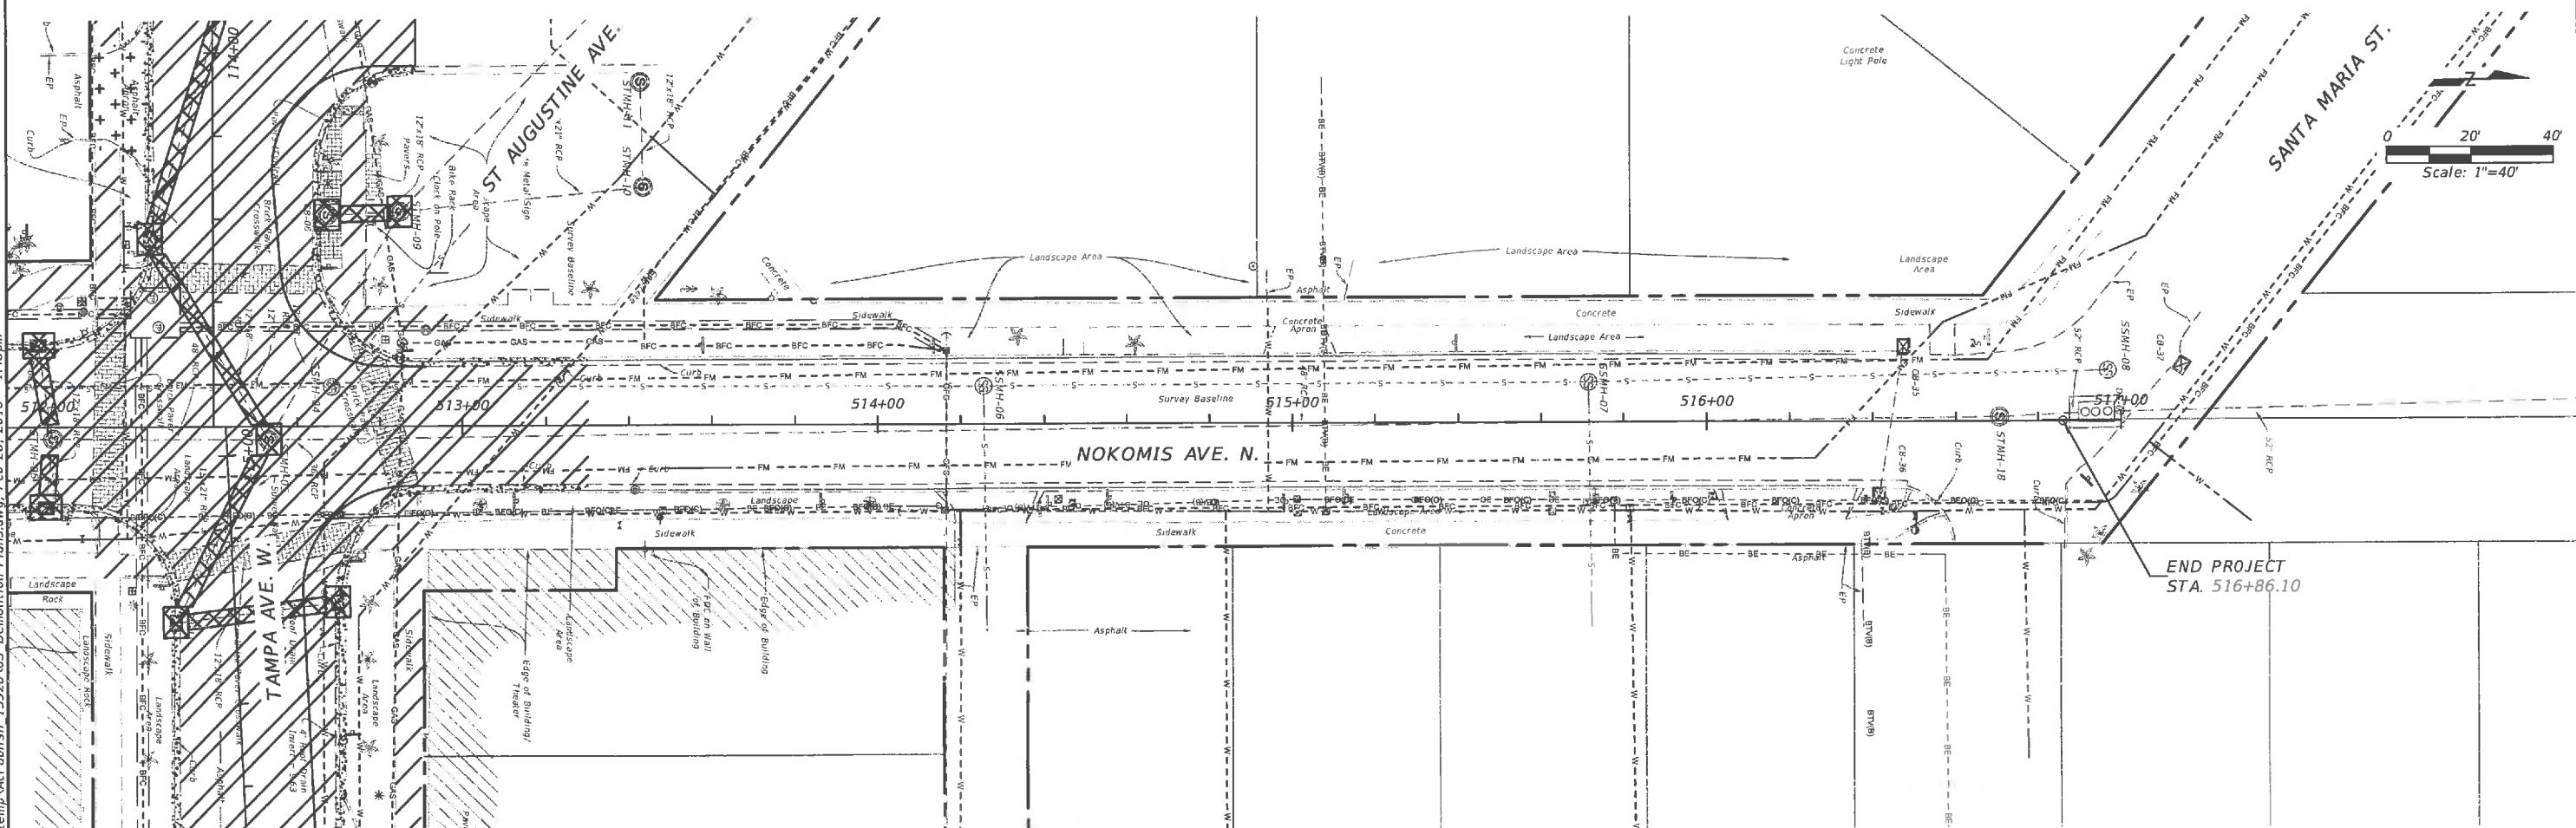

*LEGEND*

- |  |                             |  |                           |
|--|-----------------------------|--|---------------------------|
|  | FULL DEPTH PAVEMENT REMOVAL |  | SIDEWALK REMOVAL          |
|  | DRIVEWAY REMOVAL            |  | EXISTING DRAINAGE REMOVAL |
|  | CURB AND GUTTER REMOVAL     |  | LANDSCAPE REMOVAL         |
|  | EXISTING TREE REMOVAL       |  | HARDSCAPE REMOVAL         |

				PREPARED FOR:	PREPARED BY:	PROJECT:	DESCRIPTION:	APPROVED BY:	DATE:
				DESIGNED MLM	 <b>ATKINS</b>	CITY OF VENICE DOWNTOWN ROADWAY CORRIDOR IMPROVEMENTS	NOKOMIS AVE. DEMOLITION PLAN STA.512+00 TO STA.518+00	JOHN SALATINO, P.E. P.E. LICENSE NUMBER 60921 ATKINS NORTH AMERICA (CERT. OF AUTH. NO. 24) 4030 WEST BOY SCOUT BOULEVARD, SUITE 700 TAMPA, FL 33607-1712	2/28/2018
				DRAWN MA					DATE PROJECT NO.: 100054389
				CHECKED MLM					SHEET: 12
Page 901 of 1140				REV. NO.	DATE	DESCRIPTION			

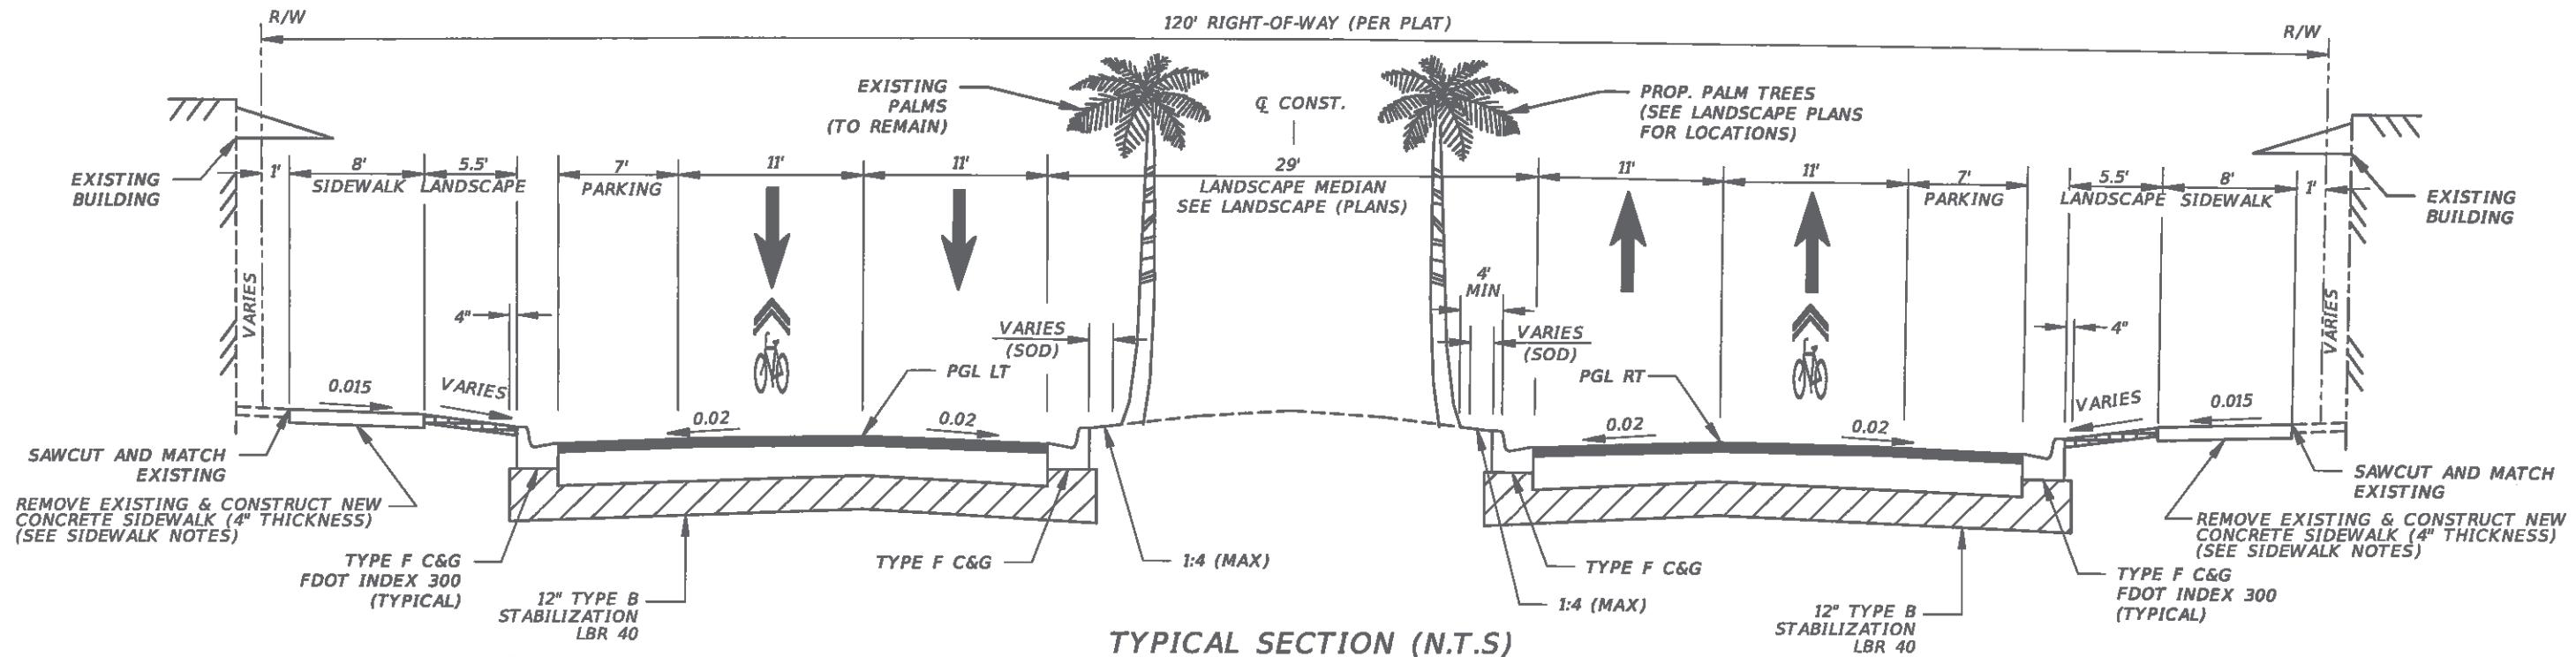

**TYPICAL SECTION (N.T.S.)**  
**W. VENICE AVENUE - HARBOR DRIVE TO N. TAMiami TRAIL (US 41)**  
**RECONSTRUCTION**  
**(STA. 200+68.00 TO STA. 217+81.00)**

#### TRAFFIC DATA

CURRENT YEAR = 2018 AADT = 8200-9500 (VPD)

T = 3.5 % (24 HOUR)

DESIGN SPEED = 20 MPH

POSTED SPEED = 20 MPH

#### SIDEWALK NOTES:

- EXISTING CONCRETE SIDEWALKS UNDERNEATH BUILDING CANOPIES WITH EXISTING COLUMNS ARE TO REMAIN.
- SOME EXISTING SIDEWALKS ARE TO BE REMOVED/REPLACED DUE TO POOR CONDITIONS OR NON-COMPLIANCE WITH ADA REQUIREMENTS. (SEE PLANS FOR APPROXIMATE LIMITS)
- SIDEWALK THICKNESS ACROSS DRIVEWAYS SHALL BE 6 INCHES THICK IN ACCORDANCE WITH FDOT INDEX 310.
- THE LIMITS OF SIDEWALK REMOVAL / REPLACEMENT ARE APPROXIMATE. THE LIMITS MAY BE ADJUSTED IN THE FIELD BY THE ENGINEER.

#### PROPOSED PAVEMENT STRUCTURE (ALL STREETS)

##### RECONSTRUCTION:

TYPE B STABILIZATION (12") (LBR 40) WITH OPTIONAL BASE GROUP 9 AND TYPE SP-9.5 STRUCTURAL COURSE (TRAFFIC B) (2.0")

ALTERNATIVE A - FULL-DEPTH PAVEMENT RECLAMATION: FULL-DEPTH RECLAMATION (8") (SEE NOTE TO THE RIGHT) WITH TYPE SP-9.5 STRUCTURAL COURSE (TRAFFIC B) (2.0")

#### PERMITTED OPTIONAL BASE NOTES


FOR RECONSTRUCTION, THE FOLLOWING BASE MATERIALS ARE PERMITTED FOR USE:


TYPE B-12.5 ASPHALT BASE (6.0") OR RECYCLED CONCRETE AGGREGATE (LBR 150)(10.0")

FOR ALTERNATIVE A, FULL-DEPTH PAVEMENT RECLAMATION, THE FOLLOWING WILL APPLY:

THE EXISTING PAVEMENT AND SOIL CEMENT BASE MATERIAL AND SUBGRADE SHALL BE CRUSHED AND BLENDED TO A MINIMUM DEPTH OF 8 INCHES BELOW THE PROPOSED FIRST LIFT OF ASPHALT. SEE THE TECHNICAL SPECIAL PROVISIONS FOR ADDITIONAL REQUIREMENTS. THE CONTRACTOR IS REQUIRED TO SUBMIT A RECYCLING MIX DESIGN TO THE ENGINEER FOR APPROVAL PRIOR TO CONSTRUCTION. THE RECYCLING MIX DESIGN SHALL PROVIDE A MINIMUM LAYER COEFFICIENT OF 0.34 PER INCH. RESILIENT MODULUS TESTING ASTM D7369 BY A CERTIFIED TESTING LABORATORY IS REQUIRED FOR VERIFICATION THAT THE CONSTRUCTED BASE COURSE COMPLIES WITH THE TECHNICAL SPECIAL PROVISIONS.

				PREPARED FOR: 	PREPARED BY: 	PROJECT: CITY OF VENICE DOWNTOWN ROADWAY CORRIDOR IMPROVEMENTS	DESCRIPTION: TYPICAL SECTIONS	APPROVED BY: JOHN SALATINO, P.E. P.E. LICENSE NUMBER 60921 ATKINS NORTH AMERICA (CERT. OF AUTH. NO. 24) 4030 WEST BOY SCOUT BOULEVARD, SUITE 700 TAMPA, FL 33607-1712	DATE: 3/13/2018
Page 902 of 1140	DESIGNED MLM	DRAWN MA	CHECKED MLM						PROJECT NO.: 100054389 SHEET: 13

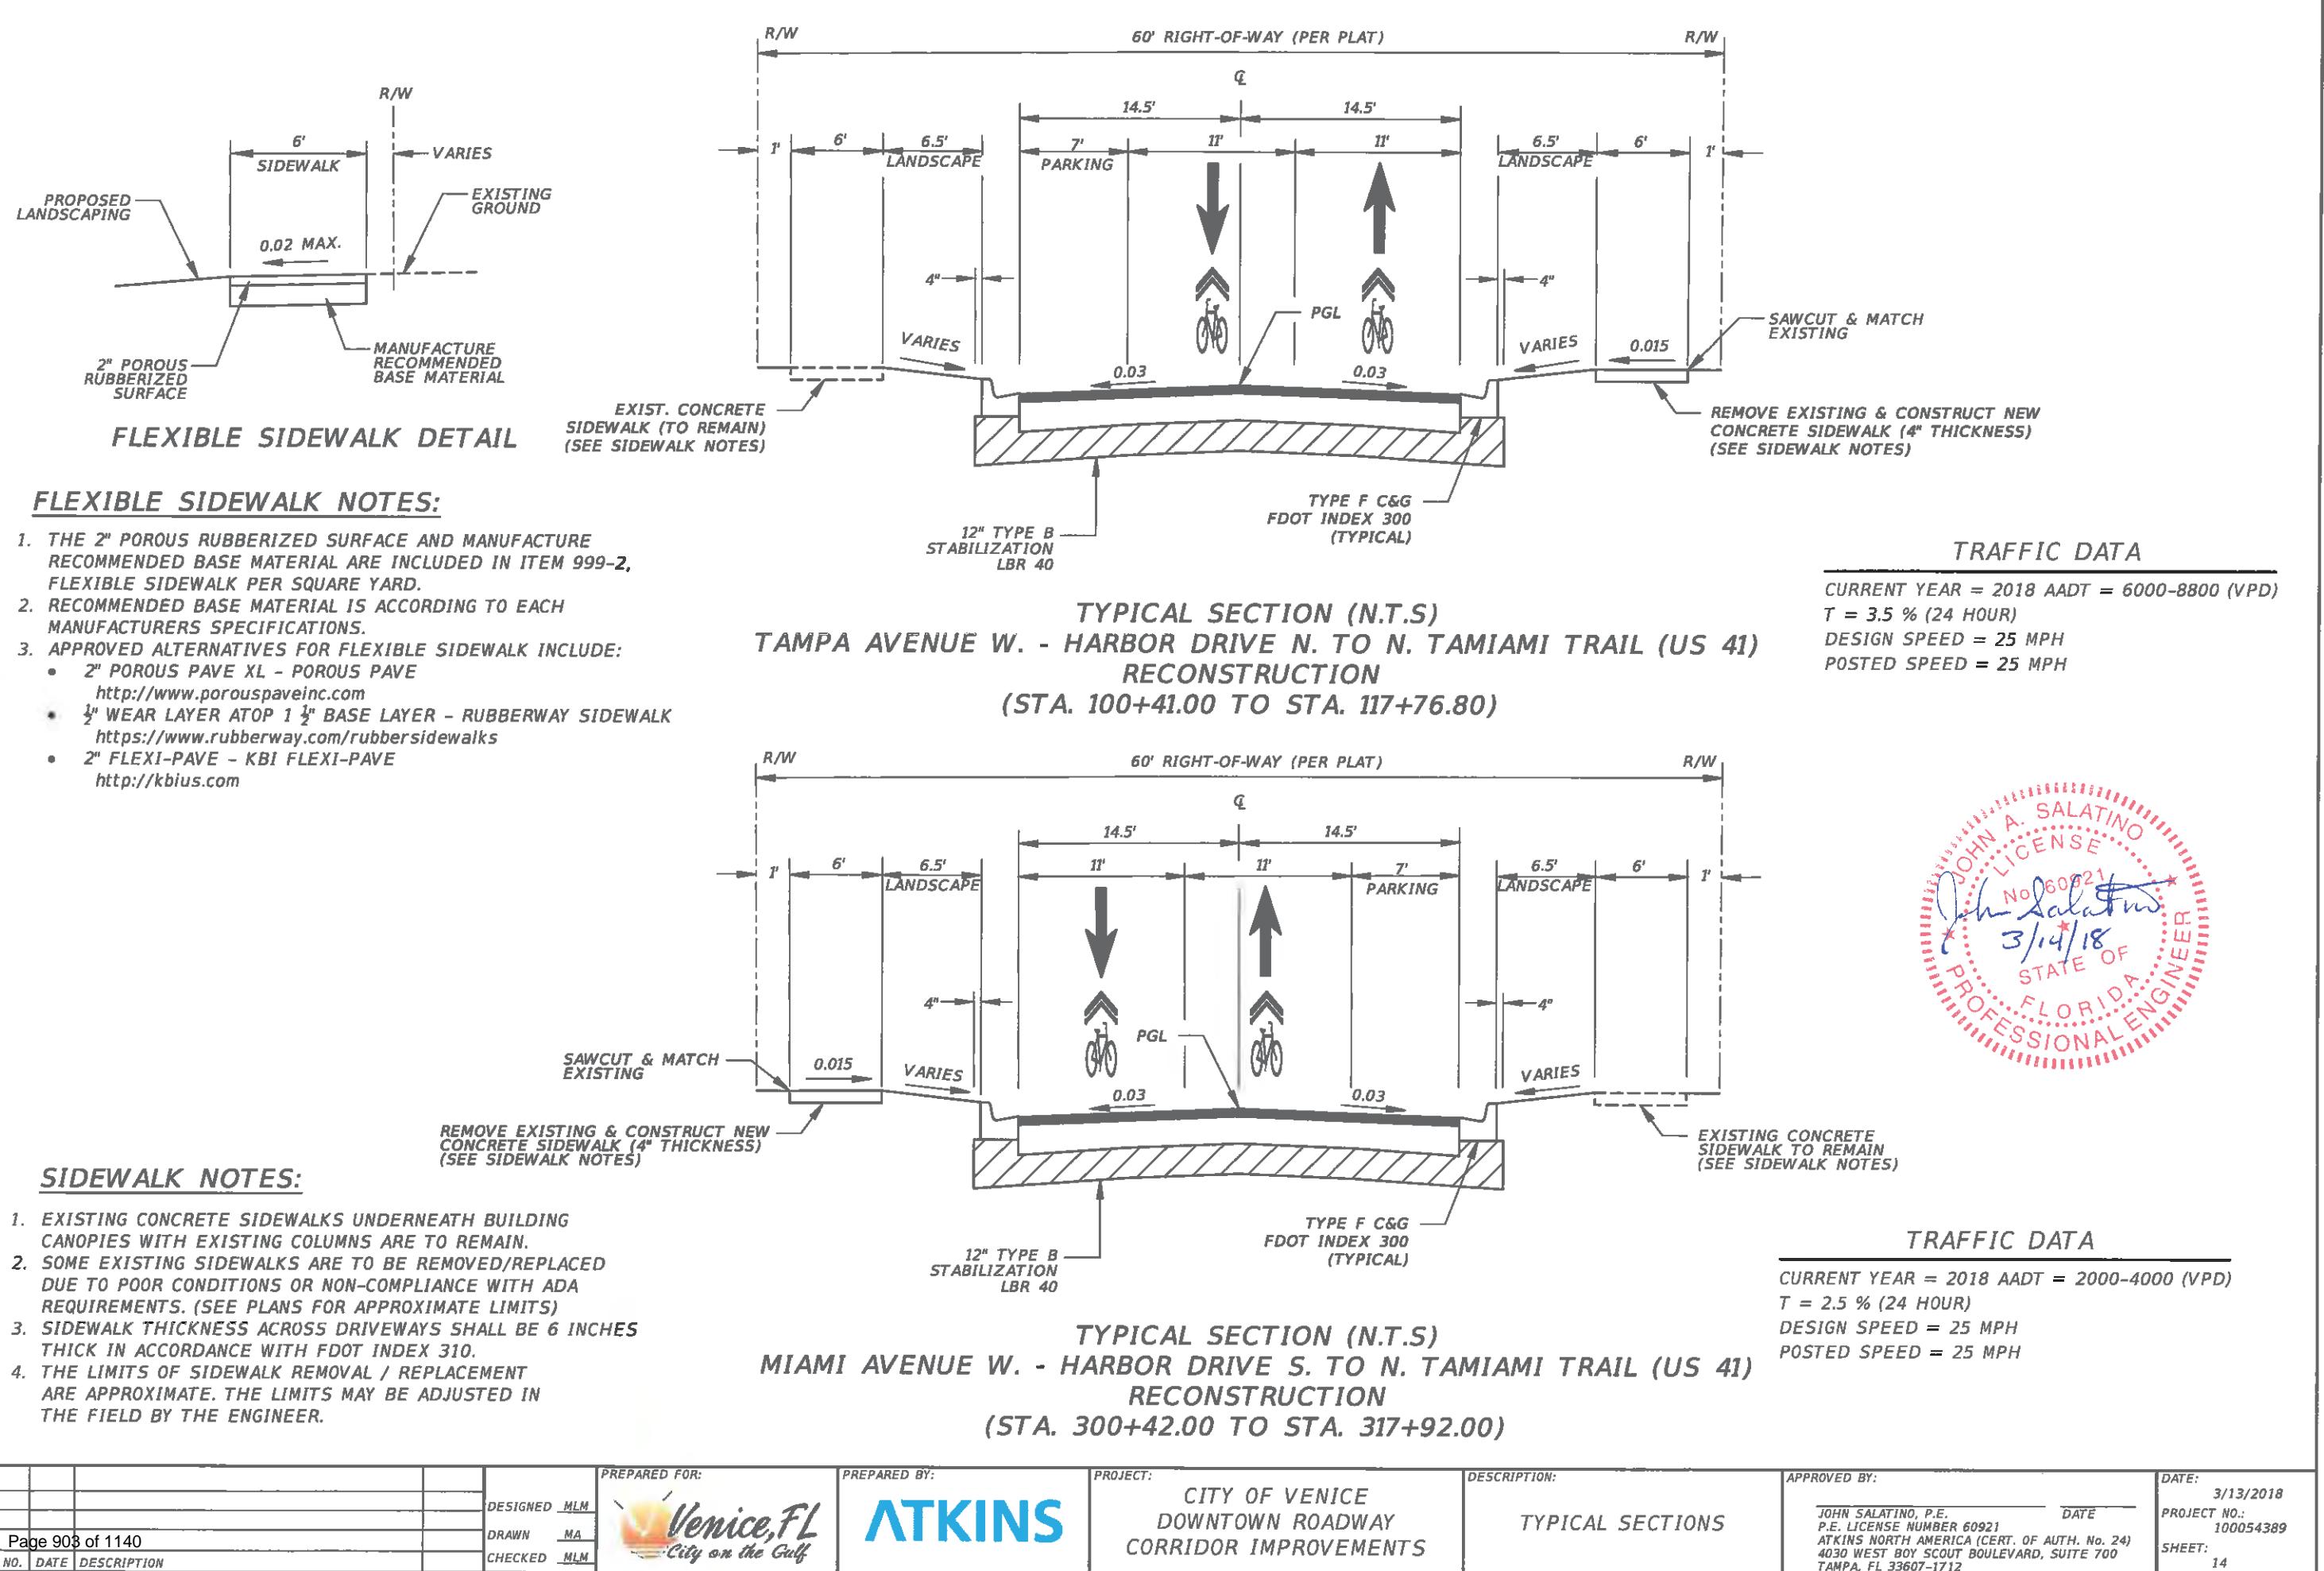

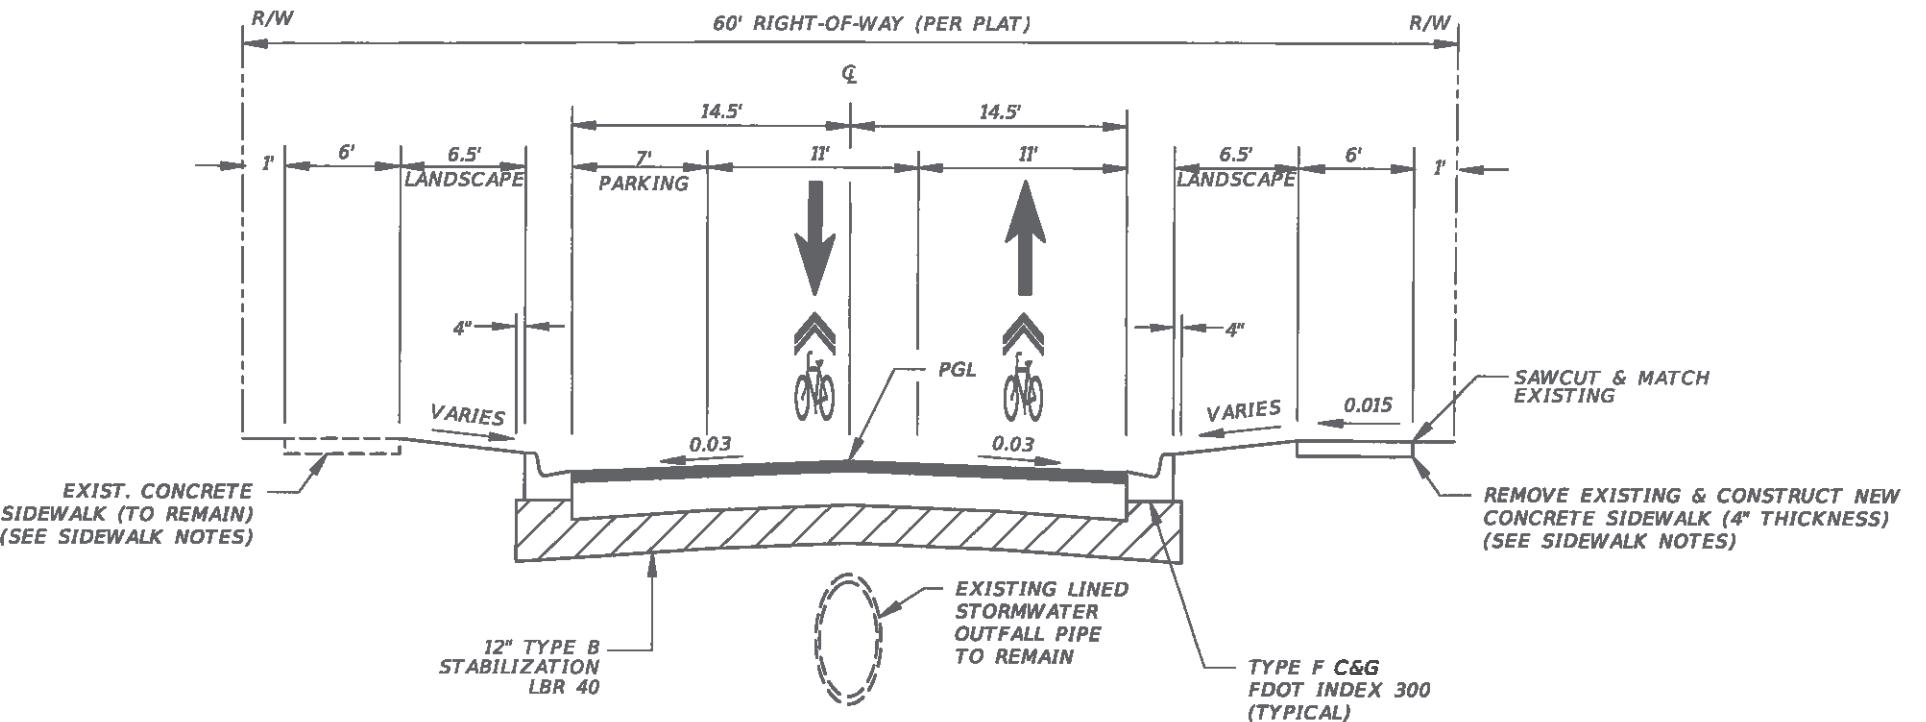

**TYPICAL SECTION (N.T.S)  
NASSAU ST. N. - MIAMI AVE TO TAMPA AVE W.  
RECONSTRUCTION  
(STA. 403+10.00 TO STA. 410+80.00)**

**SIDEWALK NOTES:**

1. EXISTING CONCRETE SIDEWALKS UNDERNEATH BUILDING CANOPIES WITH EXISTING COLUMNS ARE TO REMAIN.
2. SOME EXISTING SIDEWALKS ARE TO BE REMOVED/REPLACED DUE TO POOR CONDITIONS OR NON-COMPLIANCE WITH ADA REQUIREMENTS. (SEE PLANS FOR APPROXIMATE LIMITS)
3. SIDEWALK THICKNESS ACROSS DRIVEWAYS SHALL BE 6 INCHES THICK IN ACCORDANCE WITH FDOT INDEX 310.
4. THE LIMITS OF SIDEWALK REMOVAL / REPLACEMENT ARE APPROXIMATE. THE LIMITS MAY BE ADJUSTED IN THE FIELD BY THE ENGINEER.



			PREPARED FOR: 	PREPARED BY: <b>ATKINS</b>	PROJECT: CITY OF VENICE DOWNTOWN ROADWAY CORRIDOR IMPROVEMENTS	DESCRIPTION: TYPICAL SECTIONS	APPROVED BY: JOHN SALATINO, P.E. P.E. LICENSE NUMBER 60921 ATKINS NORTH AMERICA (CERT. OF AUTH. NO. 24) 4030 WEST BOY SCOUT BOULEVARD, SUITE 700 TAMPA, FL 33607-1712	DATE: 3/13/2018
Page 904 of 1140	DESIGNED MLM	DRAWN MA	CHECKED MLM					PROJECT NO.: 100054389 SHEET: 15

City of Venice Sidewalks				
	Begin Station	End Station	Side	Sidewalk Width
Tampa Ave.	100+49.00	100+82.00	LT.	6.00'
	100+65.00	100+71.00	RT.	6.00'
	101+20.00	101+35.00	LT.	6.00'
	101+52.00	101+87.00	LT.	6.00'
	102+04.00	102+08.00	LT.	6.00'
	102+64.00	102+90.00	RT.	6.00'
	103+29.00	103+50.00	LT.	6.00'
	103+39.00	103+70.00	RT.	6.00'
	104+83.00	105+17.00	RT.	6.00'
	106+80.00	107+16.00	LT.	6.00'
	107+11.00	107+16.00	RT.	6.00'
	107+74.00	108+10.00	LT.	6.00'
	108+50.00	112+55.00	RT.	6.00'
	108+60.00	109+66.00	LT.	6.00'
	109+92.00	110+05.00	LT.	6.00'
	110+67.00	110+89.00	LT.	6.00'
	112+45.00	113+61.00	LT.	6.00'
	113+25.00	113+98.00	RT.	6.00'
	114+23.00	114+51.00	LT.	6.00'
	114+23.00	114+51.00	RT.	6.00'
	115+25.00	117+60.00	LT.	6.00'
	116+85.00	116+94.00	RT.	5.00'
	117+13.00	117+23.00	RT.	5.00'


City of Venice Sidewalks				
	Begin Station	End Station	Side	Sidewalk Width
Miami Ave.	300+55.00	300+60.00	RT.	6.00'
	300+64.00	301+63.00	LT.	6.00'
	302+17.00	303+02.00	LT.	6.00'
	302+79.00	303+34.00	RT.	6.00'
	303+40.00	304+09.00	LT.	6.00'
	304+22.00	304+38.00	LT.	6.00'
	305+11.00	305+31.00	RT.	6.00'
	305+94.00	307+16.00	LT.	6.00'
	306+12.00	306+41.00	RT.	6.00'
	306+55.00	307+16.00	RT.	6.00'
	307+74.00	307+92.00	RT.	6.00'
	307+74.00	309+10.00	LT.	6.00'
	308+12.00	308+63.00	RT.	6.00'
	309+83.00	310+18.00	LT.	6.00'
	310+28.00	310+50.00	RT.	6.00'
	310+69.00	311+21.00	RT.	6.00'
	311+19.00	311+45.00	LT.	6.00'
	312+30.00	312+45.00	LT.	6.00'
	312+38.00	313+53.00	RT.	6.00'
	312+65.00	312+99.00	LT.	6.00'
	313+23.00	313+54.00	LT.	6.00'
	314+41.00	314+46.00	LT.	6.00'
	315+43.00	315+53.00	RT.	5.00'
	315+67.00	317+30.00	RT.	5.00'

City of Venice Sidewalks				
	Begin Station	End Station	Side	Sidewalk Width
Nokomis Ave.	505+09.00	505+17.00	RT.	5.00'
	505+89.00	505+99.00	RT.	5.00'
	505+94.00	506+14.00	LT.	8.00'
	508+30.00	508+41.00	LT.	8.00'
	508+38.00	508+41.00	RT.	7.00'
	509+59.00	509+68.00	LT.	7.50'
	509+59.00	509+90.00	RT.	5.00'
	511+88.00	512+12.00	LT.	8.00'
	512+79.00	512+96.00	LT.	6.00'



10' TRANSITION  
OR TIE INTO  
CLOSEST JOINT

10' TRANSITION  
OR TIE INTO  
CLOSEST JOINT

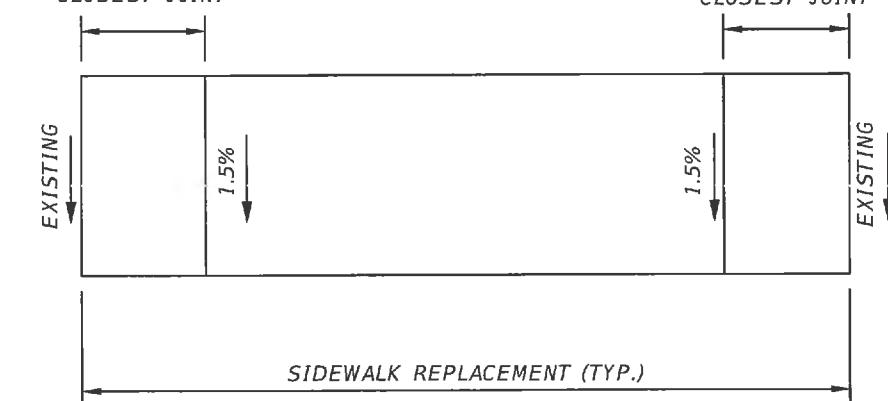


### SIDEWALK REPLACEMENT DETAIL (N.T.S.)

				PREPARED FOR:	PREPARED BY:	PROJECT:	DESCRIPTION:	APPROVED BY:	DATE:
				DESIGNED MLM		CITY OF VENICE DOWNTOWN ROADWAY CORRIDOR IMPROVEMENTS	Sidewalk Summary	JOHN SALATINO, P.E. P.E. LICENSE NUMBER 60921 ATKINS NORTH AMERICA (CERT. OF AUTH. NO. 24) 4030 WEST BOY SCOUT BOULEVARD, SUITE 700 TAMPA, FL 33607-1712	2/28/2018
				DRAWN MA	ATKINS				PROJECT NO.: 100054389
				CHECKED MLM					SHEET: 16
Page 905 of 1140	REV. NO.	DATE	DESCRIPTION						

STRUCTURE TABLE										
Q T Y	STR. #	STATION	OFFSET	SIDE	BASELINE	DESCRIPTION	CONNECTED PIPE			EOP/RIM ELEV.
P	S-100A	102+28.07	15.25'	Rt.	AL_TAMPA	Index No. 214 - Curb Inlet Type 9 with Rectangular Bottom	Out:18" Round Concrete Pipe @ ELEV 7.40', N			13.36'
P	S-101A	102+28.07	-15.25'	Lt.	AL_TAMPA	Index No. 214 - Curb Inlet Type 9 with Rectangular Bottom	Out:24" Round Concrete Pipe @ ELEV 7.30', E In :18" Round Concrete Pipe @ ELEV 7.30', S			13.36'
P	S-100	104+53.07	15.25'	Rt.	AL_TAMPA	Index No. 214 - Curb Inlet Type 9 with Rectangular Bottom	Out:18" Round Concrete Pipe @ ELEV 7.00', N			11.95'
P	S-101	104+62.00	-15.25'	Lt.	AL_TAMPA	Index No. 214 - Curb Inlet Type 9 with 5'x5' Rectangular J-Bottom	Out:24"x38" Horizontal Elliptical Concrete Pipe @ ELEV 6.90', E In :18" Round Concrete Pipe @ ELEV 6.90', S In :24" Round Concrete Pipe @ ELEV 6.90', W			11.90'
P	S-102	106+72.00	15.25'	Rt.	AL_TAMPA	Index No. 214 - Curb Inlet Type 9 with Rectangular Bottom	Out:18" Round Concrete Pipe @ ELEV 6.60', N			10.67'
P	S-103	106+72.00	-15.25'	Lt.	AL_TAMPA	Index No. 214 - Curb Inlet Type 9 with 5'x5' Rectangular J-Bottom	Out:24"x38" Horizontal Elliptical Concrete Pipe @ ELEV 6.50', E In :24"x38" Horizontal Elliptical Concrete Pipe @ ELEV 6.50', W In :18" Round Concrete Pipe @ ELEV 6.50', S			10.68'
P	S-104	108+40.00	15.25'	Rt.	AL_TAMPA	Index No. 214 - Curb Inlet Type 9 with Rectangular Bottom	Out:18" Round Concrete Pipe @ ELEV 5.90', N			10.37'
P	S-105	108+40.00	-15.25'	Lt.	AL_TAMPA	Index No. 214 - Curb Inlet Type 9 with Rectangular Bottom	Out:18" Round Concrete Pipe @ ELEV 5.80', W In :18" Round Concrete Pipe @ ELEV 5.80', S			10.37'
P	MH-200A	200+71.80	0.44'	Rt.	AL_VENICE	Index No. 201 - Type 7 Manhole (1 or 2-Piece Cover (Center))	Out:18" Round Concrete Pipe @ ELEV 9.70', E In :15" Round Concrete Pipe @ ELEV 10.90', W			14.14'
P	S-200	202+90.00	44.25'	Rt.	AL_VENICE	Index No. 214 - Curb Inlet Type 9 with Rectangular Bottom	Out:18" Round Concrete Pipe @ ELEV 9.60', N			13.27'
P	S-201	202+90.00	13.75'	Rt.	AL_VENICE	Index No. 214 - Curb Inlet Type 9 with Rectangular Bottom	Out:18" Round Concrete Pipe @ ELEV 9.50', N In :18" Round Concrete Pipe @ ELEV 9.50', S			13.41'
P	MH-201	202+90.00	0.00'	Rt.	AL_VENICE	Index No. 201 - Type 7 Manhole (1 or 2-Piece Cover (Center), 4.0' Dia. Round Bottom)	Out:18" Round Concrete Pipe @ ELEV 9.40', E In :18" Round Concrete Pipe @ ELEV 9.40', W In :18" Round Concrete Pipe @ ELEV 9.40', S			14.11'
P	S-202	203+20.00	-44.25'	Lt.	AL_VENICE	Index No. 214 - Curb Inlet Type 9 with Rectangular Bottom	Out:18" Round Concrete Pipe @ ELEV 9.50', S			13.20'
P	S-203	203+20.00	-13.75'	Lt.	AL_VENICE	Index No. 214 - Curb Inlet Type 9 with Rectangular Bottom	Out:18" Round Concrete Pipe @ ELEV 9.40', S In :18" Round Concrete Pipe @ ELEV 9.40', N			13.34'
P	MH-203	203+20.00	0.00'	Rt.	AL_VENICE	Index No. 201 - Type 7 Manhole (1 or 2-Piece Cover (Center), 4.0' Dia. Round Bottom)	Out:24" Round Concrete Pipe @ ELEV 9.30', E In :18" Round Concrete Pipe @ ELEV 9.30', W In :18" Round Concrete Pipe @ ELEV 9.30', N			13.89'
P	S-206	204+68.67	-44.25'	Lt.	AL_VENICE	Index No. 214 - Curb Inlet Type 9 with Round Bottom	Out:18" Round Concrete Pipe @ ELEV 9.10', SE			12.76'


NOTE: "EOP/RIM ELEV." REFERS TO THE PROPOSED EDGE OF PAVEMENT ELEVATION AT THE REFERENCED STATION FOR ALL CURB INLETS AND GUTTER INLETS (TYPE V), AND REFERS TO THE ELEVATION OF THE TOP OF THE RIM OR GRATE FOR ALL MANHOLES AND DITCH BOTTOM INLETS.

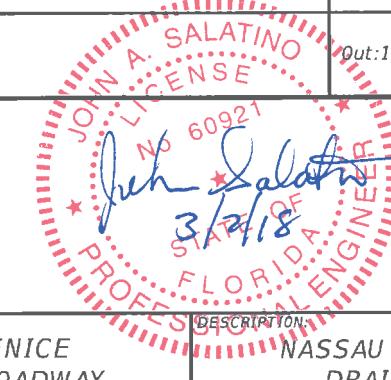

DESIGNED MLM	DRAWN MA	CHECKED MLM	PREPARED FOR: 	PREPARED BY: 	PROJECT: CITY OF VENICE DOWNTOWN ROADWAY CORRIDOR IMPROVEMENTS	DESCRIPTION: NASSAU SYSTEM DRAINAGE STRUCTURE TABLES	APPROVED BY: JOHN SALATINO, P.E. P.E. LICENSE NUMBER 60921 ATKINS NORTH AMERICA (CERT. OF AUTH. NO. 24) 4030 WEST BOY SCOUT BOULEVARD, SUITE 700 TAMPA, FL 33607-1712	DATE: 2/28/2018
Page 906 of 1140								PROJECT NO.: 100054389 SHEET: 17

City Of Venice\ Downtown Roadway\ CAD\10\_Post\_Design\08\_Drainage\_Structure Tables.dwg, Feb 28, 2018 - 3:36pm

## STRUCTURE TABLE

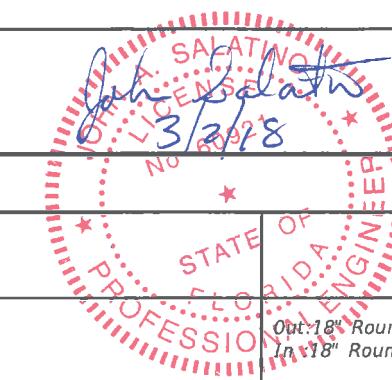

STRUCTURE TABLE									
QTY	STR. #	STATION	OFFSET	SIDE	BASELINE	DESCRIPTION	PROFESSIONAL ENGINEER STATE OF FLORIDA	CONNECTED PIPE	EOP/RIM ELEV.
P	S-207	204+80.00	-13.75'	Lt.	AL_VENICE	Index No. 214 - Curb Inlet Type 9 with Round Bottom	Out:18" Round Concrete Pipe @ ELEV 9.00', S In:18" Round Concrete Pipe @ ELEV 9.00', NW		12.93'
P	MH-207	204+80.00	0.00'	Rt.	AL_VENICE	Index No. 201 - Type 7 Manhole (1 or 2-Piece Cover (Center), 4.0' Dia. Round Bottom)	Out:24" Round Concrete Pipe @ ELEV 8.90', E In:24" Round Concrete Pipe @ ELEV 8.90', W In:18" Round Concrete Pipe @ ELEV 8.90', N		13.93'
P	S-204	205+00.00	44.25'	Rt.	AL_VENICE	Index No. 214 - Curb Inlet Type 9 with Rectangular Bottom	Out:18" Round Concrete Pipe @ ELEV 9.00', N		12.92'
P	S-205	205+00.00	13.75'	Rt.	AL_VENICE	Index No. 214 - Curb Inlet Type 9 with Rectangular Bottom	Out:18" Round Concrete Pipe @ ELEV 8.90', N In:18" Round Concrete Pipe @ ELEV 8.90', S		13.05'
P	MH-205	205+00.00	0.00'	Rt.	AL_VENICE	Index No. 201 - Type 7 Manhole (1 or 2-Piece Cover (Center), 4.0' Dia. Round Bottom)	Out:30" Round Concrete Pipe @ ELEV 8.80', E In:24" Round Concrete Pipe @ ELEV 8.80', W In:18" Round Concrete Pipe @ ELEV 8.80', S		13.77'
P	S-210	206+50.00	-44.25'	Lt.	AL_VENICE	Index No. 214 - Curb Inlet Type 9 with Rectangular Bottom	Out:18" Round Concrete Pipe @ ELEV 8.70', S		12.63'
P	S-211	206+50.00	-13.75'	Lt.	AL_VENICE	Index No. 214 - Curb Inlet Type 9 with Rectangular Bottom	Out:18" Round Concrete Pipe @ ELEV 8.60', S In:18" Round Concrete Pipe @ ELEV 8.60', N		12.77'
P	MH-211	206+50.00	0.00'	Rt.	AL_VENICE	Index No. 201 - Type 7 Manhole (1 or 2-Piece Cover (Center), 6.0' Dia. Round Bottom)	Out:30" Round Concrete Pipe @ ELEV 8.50', S In:30" Round Concrete Pipe @ ELEV 8.50', W In:18" Round Concrete Pipe @ ELEV 8.50', N		13.43'
P	MH-209	206+57.83	31.00'	Rt.	AL_VENICE	Index No. 201 - Type 7 Manhole (1 or 2-Piece Cover (Center), 6.0' Dia. Round Bottom)	Out:30" Round Concrete Pipe @ ELEV 8.40', E In:30" Round Concrete Pipe @ ELEV 8.40', N		12.94'
P	S-208	206+72.00	44.25'	Rt.	AL_VENICE	Index No. 214 - Curb Inlet Type 9 with Rectangular Bottom	Out:18" Round Concrete Pipe @ ELEV 8.60', N		12.64'
P	S-209	206+72.00	13.75'	Rt.	AL_VENICE	Index No. 214 - Curb Inlet Type 9 with Rectangular Bottom	Out:18" Round Concrete Pipe @ ELEV 8.60', S		12.78'
P	MH-208	206+72.00	31.00'	Rt.	AL_VENICE	Index No. 201 - Type 7 Manhole (1 or 2-Piece Cover (Center), 6.0' Dia. Round Bottom)	In:18" Round Concrete Pipe @ ELEV 8.50', N Out:30" Round Concrete Pipe @ ELEV 8.30', E In:18" Round Concrete Pipe @ ELEV 8.50', S In:30" Round Concrete Pipe @ ELEV 8.30', W		12.89'
P	STMH-20	300+35.95	0.26'	Rt.	AL_MIAMI	Existing Manhole to be modified: Existing outgoing 15" pipe is to be removed and replaced with new at specified invert. Structure invert is to be raised to meet this elevation as well.	Out:18" Round Concrete Pipe @ ELEV 10.80', E In: Existing to Remain		14.00'
P	S-300	301+40.00	15.25'	Rt.	AL_MIAMI	Index No. 214 - Curb Inlet Type 9 with Rectangular Bottom	Out:14"x23" Horizontal Elliptical Concrete Pipe @ ELEV 10.60', N		13.29'
P	S-301	301+40.00	-15.25'	Lt.	AL_MIAMI	Index No. 214 - Curb Inlet Type 9 with Rectangular Bottom	Out:14"x23" Horizontal Elliptical Concrete Pipe @ ELEV 10.60', S		13.29'
P	MH-300	301+40.00	4.00'	Rt.	AL_MIAMI	CIP Index No. 201 - Type 7 Manhole (1 or 2-Piece Cover (Center), 5.0' Dia. Round Bottom)	Out:19"x30" Horizontal Elliptical Concrete Pipe @ ELEV 10.50', E In:14"x23" Horizontal Elliptical Concrete Pipe @ ELEV 10.50', S In:14"x23" Horizontal Elliptical Concrete Pipe @ ELEV 10.50', N In:18" Round Concrete Pipe @ ELEV 10.50', W		13.60'
P	MH-301A	301+71.87	4.00'	Rt.	AL_MIAMI	CIP Index No. 201 - Type 7 Manhole (1 or 2-Piece Cover (Center), 5.0' Dia. Round Bottom)	Out:19"x30" Horizontal Elliptical Concrete Pipe @ ELEV 10.40', E In:19"x30" Horizontal Elliptical Concrete Pipe @ ELEV 10.40', W In:18" Round Concrete Pipe @ ELEV 10.40', N		13.69'

NOTE: "EOP/RIM ELEV." REFERS TO THE PROPOSED EDGE OF PAVEMENT ELEVATION AT THE REFERENCED STATION FOR ALL CURB INLETS AND GUTTER INLETS (TYPE V), AND REFERS TO THE ELEVATION OF THE TOP OF THE RIM OR GRATE FOR ALL MANHOLES AND DITCH BOTTOM INLETS.

				PREPARED FOR:	PREPARED BY:	PROJECT:	DESCRIPTION:	APPROVED BY:	DATE:
				DESIGNED MLM		CITY OF VENICE DOWNTOWN ROADWAY CORRIDOR IMPROVEMENTS	NASSAU SYSTEM DRAINAGE STRUCTURE TABLES	JOHN SALATINO, P.E. P.E. LICENSE NUMBER 60921 ATKINS NORTH AMERICA (CERT. OF AUTH. NO. 24) 4030 WEST BOY SCOUT BOULEVARD, SUITE 700 TAMPA, FL 33607-1712	2/28/2018
				DRAWN MA	ATKINS				PROJECT NO.: 100054389
				CHECKED MLM					SHEET: 18
Page 907 of 1140									
REV. NO.	DATE	DESCRIPTION							

STRUCTURE TABLE										
Q T Y	STR. #	STATION	OFFSET	SIDE	BASELINE	DESCRIPTION	CONNECTED PIPE	EOP/RIM ELEV.		
P	S-301A	301+72.23	-34.57'	Lt.	AL_MIAMI	Index No. 233 - Ditch Bottom Inlet - Type F, Alt. G		Out:18" Round Concrete Pipe @ ELEV 10.60', S		13.65'
P	MH-300A	303+68.62	4.00'	Rt.	AL_MIAMI	CIP Index No. 201 - Type 7 Manhole (1 or 2-Piece Cover (Center), 5.0' Dia. Round Bottom)		Out:19"X30" Horizontal Elliptical Concrete Pipe @ ELEV 10.10', E In :19"X30" Horizontal Elliptical Concrete Pipe @ ELEV 10.10', W In :18" Round Concrete Pipe @ ELEV 10.20', S		13.57'
P	S-302	304+70.00	15.25'	Rt.	AL_MIAMI	Index No. 214 - Curb Inlet Type 9 with Rectangular Bottom		Out:18" Round Concrete Pipe @ ELEV 9.90', N		12.96'
P	S-303	304+70.00	-15.25'	Lt.	AL_MIAMI	Index No. 214 - Curb Inlet Type 9 with Rectangular Bottom		Out:18" Round Concrete Pipe @ ELEV 9.90', S		12.96'
P	MH-302	304+70.00	4.00'	Rt.	AL_MIAMI	CIP Index No. 201 - Type 7 Manhole (1 or 2-Piece Cover (Center), 6.0' Dia. Round Bottom)		Out:24"x38" Horizontal Elliptical Concrete Pipe @ ELEV 9.80', E In :18" Round Concrete Pipe @ ELEV 9.80', S In :18" Round Concrete Pipe @ ELEV 9.80', N In :19"X30" Horizontal Elliptical Concrete Pipe @ ELEV 9.80', W		13.27'
P	S-305	306+67.00	-15.25'	Lt.	AL_MIAMI	Index No. 214 - Curb Inlet Type 9 with Rectangular Bottom		Out:18" Round Concrete Pipe @ ELEV 9.40', S		12.72'
P	MH-304	306+70.21	4.00'	Rt.	AL_MIAMI	CIP Index No. 201 - Type 7 Manhole (1 or 2-Piece Cover (Center), 7.0' Dia. Round Bottom)		Out:24"x38" Horizontal Elliptical Concrete Pipe @ ELEV 9.30', E In :24"x38" Horizontal Elliptical Concrete Pipe @ ELEV 9.30', W In :18" Round Concrete Pipe @ ELEV 9.30', N In :18" Round Concrete Pipe @ ELEV 9.30', S		13.02'
P	S-304	306+72.50	15.25'	Rt.	AL_MIAMI	Index No. 214 - Curb Inlet Type 9 with Rectangular Bottom		Out:18" Round Concrete Pipe @ ELEV 9.40', N		12.71'
P	S-400	403+18.00	15.25'	Rt.	AL_NASSAU	Index No. 214 - Curb Inlet Type 9 with Rectangular Bottom		Out:18" Round Concrete Pipe @ ELEV 9.80', W		13.23'
P	S-401	403+18.00	-15.25'	Lt.	AL_NASSAU	Index No. 214 - Curb Inlet Type 9 with Rectangular Bottom		Out:18" Round Concrete Pipe @ ELEV 9.80', E		13.08'
P	MH-400	403+18.13	0.55'	Rt.	AL_NASSAU	Index No. 201 - Type 7 Manhole (1 or 2-Piece Cover (Center), 4.0' Dia. Round Bottom)		Out:24" Round Concrete Pipe @ ELEV 9.70', N In :18" Round Concrete Pipe @ ELEV 9.70', E In :18" Round Concrete Pipe @ ELEV 9.70', W In :24" Round Concrete Pipe @ ELEV 9.70', S		13.67'
P	MH-400B	403+60.00	0.56'	Rt.	AL_NASSAU	Index No. 201 - Type 7 Manhole (1 or 2-Piece Cover (Center), 7.0' Dia. Round Bottom)		Out:24" Round Concrete Pipe @ ELEV 9.03', N In :24" Round Concrete Pipe @ ELEV 9.05', S In :24"x38" Horizontal Elliptical Concrete Pipe @ ELEV 9.03', W		13.82'
P	S-400A	405+15.44	-33.33'	Lt.	AL_NASSAU	Index No. 233 - Ditch Bottom Inlet - Type F, Alt. G		Out:18" Round Concrete Pipe @ ELEV 8.80', E		13.04'
P	MH-400A	405+15.51	0.21'	Rt.	AL_NASSAU	Index No. 201 - Type 8 Manhole (Concentric Cone with 1 or 2-Piece Cover (Center), Round Bottom)		Out:24" Round Concrete Pipe @ ELEV 8.41', N In :24" Round Concrete Pipe @ ELEV 8.41', S In :18" Round Concrete Pipe @ ELEV 8.40', W		13.22'
P	S-403	406+05.75	-15.25'	Lt.	AL_NASSAU	Index No. 214 - Curb Inlet Type 9 with Rectangular Bottom		Out:18" Round Concrete Pipe @ ELEV 8.20', E		12.45'
P	S-402	406+05.75	15.25'	Rt.	AL_NASSAU	Index No. 214 - Curb Inlet Type 9 with Rectangular Bottom		Out:18" Round Concrete Pipe @ ELEV 8.20', W		12.45'

NOTE: "EOP/RIM ELEV." REFERS TO THE PROPOSED EDGE OF PAVEMENT ELEVATION AT THE REFERENCED STATION FOR ALL CURB INLETS AND GUTTER INLETS (TYPE V), AND REFERS TO THE ELEVATION OF THE TOP OF THE RIM OR GRATE FOR ALL MANHOLES AND DITCH BOTTOM INLETS.

PREPARED FOR:	PREPARED BY:	PROJECT:	DESCRIPTION:	APPROVED BY:	DATE:
DESIGNED MLM	DRAWN MA	CITY OF VENICE DOWNTOWN ROADWAY CORRIDOR IMPROVEMENTS	NASSAU SYSTEM DRAINAGE STRUCTURE TABLES	JOHN SALATINO, P.E. P.E. LICENSE NUMBER 60921 ATKINS NORTH AMERICA (CERT. OF AUTH. NO. 24) 4030 WEST BOY SCOUT BOULEVARD, SUITE 700 TAMPA, FL 33607-1712	2/28/2018 DATE PROJECT NO.: 100054389
DRAWN MA	ATKINS				
Page 908 of 1140	CHECKED MLM				SHEET: 19

STRUCTURE TABLE									
Q T Y	STR. #	STATION	OFFSET	SIDE	BASELINE	DESCRIPTION	CONNECTED PIPE	EOP/RIM ELEV.	
P	MH-402	406+05.75	0.00'	Rt.	AL_NASSAU	Index No. 201 - Type 8 Manhole (Concentric Cone with 1 or 2-Piece Cover (Edge), Round Bottom)	Out:24" Round Concrete Pipe @ ELEV 8.05', N In :18" Round Concrete Pipe @ ELEV 8.10', E In :18" Round Concrete Pipe @ ELEV 8.10', W In :24" Round Concrete Pipe @ ELEV 8.05', S	12.88'	
P	MH-208A	406+69.25	0.12'	Rt.	AL_NASSAU	Index No. 201 - Type 7 Manhole (1 or 2-Piece Cover (Center), 6.0' Dia. Round Bottom)	Out:24" Round Concrete Pipe @ ELEV 7.98', N In :24" Round Concrete Pipe @ ELEV 7.96', S In :30" Round Concrete Pipe @ ELEV 8.00', W	13.15'	
P	S-405	409+67.45	-16.13'	Lt.	AL_NASSAU	Index No. 221 - Gutter Inlet - Type V	Out:14"x23" Horizontal Elliptical Concrete Pipe @ ELEV 8.00', E	10.75'	
P	S-404	409+67.45	15.25'	Rt.	AL_NASSAU	Index No. 214 - Curb Inlet Type 9 with Rectangular Bottom	Out:18" Round Concrete Pipe @ ELEV 6.10', W	10.75'	
P	MH-404	409+67.45	-0.27'	Lt.	AL_NASSAU	Index No. 201 - Type 7 Manhole (1 or 2-Piece Cover (Center), 4.0' Dia. Round Bottom)	Out:24" Round Concrete Pipe @ ELEV 6.00', N In :18" Round Concrete Pipe @ ELEV 6.00', E In :14"x23" Horizontal Elliptical Concrete Pipe @ ELEV 7.80', W In :24" Round Concrete Pipe @ ELEV 6.10', S	11.17'	
P	MH-404A	410+54.00	-0.43'	Lt.	AL_NASSAU	Index No. 201 - Type 7 Manhole (1 or 2-Piece Cover (Center), 7.0' Dia. Round Bottom)	Out:36" Round Concrete Pipe @ ELEV 5.30', N In :36" Round Concrete Pipe @ ELEV 5.30', S In :24"x38" Horizontal Elliptical Concrete Pipe @ ELEV 6.20', W In :18" Round Concrete Pipe @ ELEV 5.60', E	10.89'	
P	STMH-04	210+80.02	-0.38'	Lt.	AL_VENICE	Exist. MH to be modified	Out:12" Pipe to remain @ ELEV 9.83', W In :12" Round Concrete Pipe @ ELEV 9.80', NE	13.09'	

NOTE: "EOP/RIM ELEV." REFERS TO THE PROPOSED EDGE OF PAVEMENT ELEVATION AT THE REFERENCED STATION FOR ALL CURB INLETS AND GUTTER INLETS (TYPE V), AND REFERS TO THE ELEVATION OF THE TOP OF THE RIM OR GRATE FOR ALL MANHOLES AND DITCH BOTTOM INLETS.



PREPARED FOR:	PREPARED BY:	PROJECT:	DESCRIPTION:	APPROVED BY:	DATE:
DESIGNED MLM	DRAWN MA	ATKINS	CITY OF VENICE DOWNTOWN ROADWAY CORRIDOR IMPROVEMENTS	NASSAU SYSTEM DRAINAGE STRUCTURE TABLES	JOHN SALATINO, P.E. P.E. LICENSE NUMBER 60921 ATKINS NORTH AMERICA (CERT. OF AUTH. NO. 24) 4030 WEST BOY SCOUT BOULEVARD, SUITE 700 TAMPA, FL 33607-1712
DRAWN MLM	CHECKED MLM	Venice, FL City on the Gulf			2/28/2018
Page 909 of 1140	REV. NO.	DATE	DESCRIPTION	PROJECT NO.: 100054389	SHEET: 20

PIPE TABLE				
QTY	FROM STR.	TO STR.	PIPE SIZE (in)	LENGTH (ft)
F	S-100A	S-101A	18	28
F	S-100	S-101	18	28
F	S-102	S-103	18	25
F	S-101A	S-101	24	232
F	S-103	MH-404A	24 x 38	65
F	S-101	S-103	24 x 38	205
F	MH-200A	MH-201	18	217
F	MH-201	MH-203	18	27
F	MH-203	MH-207	24	158
F	MH-207	MH-205	24	18
F	MH-211	MH-209	30	28
F	S-200	S-201	18	28
F	S-201	MH-201	18	12
F	S-203	MH-203	18	12
F	S-202	S-203	18	28
F	S-206	S-207	18	30

PIPE TABLE				
QTY	FROM STR.	TO STR.	PIPE SIZE (in)	LENGTH (ft)
F	S-207	MH-207	18	11
F	S-204	S-205	18	28
F	S-205	MH-205	18	12
F	S-210	S-211	18	28
F	S-211	MH-211	18	11
F	S-209	MH-208	18	14
F	S-300	MH-300	14 x 23	8
F	S-303	MH-302	18	15
F	S-302	MH-302	18	7
F	MH-302	MH-304	24 x 38	195
F	S-304	MH-304	18	7
F	MH-304	MH-400B	24 x 38	70
F	S-104	S-105	18	28
F	S-105	MH-404A	18	93
F	STMH-20	MH-300	18	101
F	S-402	MH-402	18	12
F	S-403	MH-402	18	13
F	S-404	MH-404	18	13
F	S-405	MH-404	14 x 23	13

PIPE TABLE				
QTY	FROM STR.	TO STR.	PIPE SIZE (in)	LENGTH (ft)
F	S-301	MH-300	14 x 23	16
F	S-400	MH-400	18	12
F	S-401	MH-400	18	13
F	MH-300A	MH-302	19 x 30	98
F	S-305	MH-304	18	15
F	S-400A	MH-400A	18	32
F	MH-300	MH-301A	19 x 30	32
F	S-301A	MH-301A	18	37
F	MH-301A	MH-300A	19 x 30	190
F	CONC. COLLAR	MH-300A	18	10
F	MH-205	MH-211	30	147
F	S-208	MH-208	18	10
F	MH-209	MH-208	30	10
F	MH-208	MH-208A	30	68
F	S-215	STMH-04	12	22



PREPARED FOR:	PREPARED BY:	PROJECT:	DESCRIPTION:	APPROVED BY:	DATE:
DESIGNED MLM	DRAWN MA	ATKINS	CITY OF VENICE DOWNTOWN ROADWAY CORRIDOR IMPROVEMENTS	NASSAU SYSTEM DRAINAGE PIPE TABLES	2/28/2018
Page 910 of 1140	CHECKED MLM			JOHN SALATINO, P.E.	DATE
REV. NO.	DATE	DESCRIPTION		P.E. LICENSE NUMBER 60921	PROJECT NO.: 100054389
				ATKINS NORTH AMERICA (CERT. OF AUTH. NO. 24) 4030 WEST BOY SCOUT BOULEVARD, SUITE 700 TAMPA, FL 33607-1712	SHEET: 21

## STRUCTURE TABLE

Q T Y	STR. #	STATION	OFFSET	SIDE	BASELINE	DESCRIPTION	CONNECTED PIPE	EOP/RIM ELEV.
P	S-106	110+20.00	15.25'	Rt.	AL_TAMPA	Index No. 214 - Curb Inlet Type 9 with Round Bottom	Out:18" Round Concrete Pipe @ ELEV 4.60', NE	10.21'
P	S-107	110+20.00	-15.25'	Lt.	AL_TAMPA	Index No. 214 - Curb Inlet Type 9 with Round Bottom	Out:18" Round Concrete Pipe @ ELEV 4.60', SE	10.21'
P	MH-106	110+33.00	8.84'	Rt.	AL_TAMPA	Index No. 201 - Type 8 Manhole (Concentric Cone with 1 or 2-Piece Cover (Edge), 4.0' Dia. Round Bottom)	Out:18" Round Concrete Pipe @ ELEV 4.50', E In:18" Round Concrete Pipe @ ELEV 4.50', NW In:18" Round Concrete Pipe @ ELEV 4.50', SW	10.42'
P	S-109	113+18.30	-15.25'	Lt.	AL_TAMPA	Index No. 214 - Curb Inlet Type 9 with Rectangular Bottom	Out:18" Round Concrete Pipe @ ELEV 4.20', S	9.87'
P	MH-108	113+18.30	9.00'	Rt.	AL_TAMPA	Index No. 201 - Type 7 Manhole (1 or 2-Piece Cover (Center), 4.0' Dia. Round Bottom)	Out:24" Round Concrete Pipe @ ELEV 4.10', SE In:18" Round Concrete Pipe @ ELEV 4.10', W In:18" Round Concrete Pipe @ ELEV 4.10', N	10.03'
P	S-108	113+40.30	15.25'	Rt.	AL_TAMPA	Index No. 214 - Curb Inlet Type 9 with Round Bottom	Out:24" Round Concrete Pipe @ ELEV 4.00', E In:24" Round Concrete Pipe @ ELEV 4.00', W	9.82'
P	MH-108A	114+10.50	9.00'	Rt.	AL_TAMPA	Index No. 201 - Type 7 Manhole (1 or 2-Piece Cover (Center), 5.0' Dia. Round Bottom)	Out:24" Round Concrete Pipe @ ELEV 3.70', E In:24" Round Concrete Pipe @ ELEV 3.70', S In:24" Round Concrete Pipe @ ELEV 3.70', W	10.16'
P	S-108A	114+10.56	33.00'	Rt.	AL_TAMPA	Index No. 233 - Ditch Bottom Inlet - Type F, Alt. G	Out:24" Round Concrete Pipe @ ELEV 3.90', N	10.24'
P	S-111	115+67.51	-17.75'	Lt.	AL_TAMPA	Index No. 214 - Curb Inlet Type 9 with Rectangular Bottom	Out:24" Round Concrete Pipe @ ELEV 5.00', W In:18" Round Concrete Pipe @ ELEV 5.00', S	9.65'
P	S-110	115+67.51	17.75'	Rt.	AL_TAMPA	Index No. 214 - Curb Inlet Type 9 with Rectangular Bottom	Out:18" Round Concrete Pipe @ ELEV 5.10', N	9.65'
P	S-212	210+89.50	44.25'	Rt.	AL_VENICE	Index No. 214 - Curb Inlet Type 9 with Rectangular Bottom	Out:18" Round Concrete Pipe @ ELEV 8.00', N	11.77'
P	S-214	210+89.50	-44.25'	Lt.	AL_VENICE	Index No. 214 - Curb Inlet Type 9 with Rectangular Bottom	Out:18" Round Concrete Pipe @ ELEV 7.90', S	11.81'
P	S-213	211+00.00	13.75'	Rt.	AL_VENICE	Index No. 214 - Curb Inlet Type 9 with Rectangular Bottom	Out:18" Round Concrete Pipe @ ELEV 7.90', N In:18" Round Concrete Pipe @ ELEV 7.90', S	11.88'
P	S-215	211+00.00	-13.75'	Lt.	AL_VENICE	Index No. 214 - Curb Inlet Type 9 with 5' Dia. Round J-Bottom	Out:24" Round Concrete Pipe @ ELEV 7.50', E (Plugged) In:18" Round Concrete Pipe @ ELEV 7.80', S In:18" Round Concrete Pipe @ ELEV 7.80', N Out:18" Round Concrete Pipe @ ELEV 8.50, SW	11.93'
P	S-216	213+80.00	44.25'	Rt.	AL_VENICE	Index No. 214 - Curb Inlet Type 9 with Rectangular Bottom	Out:18" Round Concrete Pipe @ ELEV 7.20', N	11.04'
P	S-218	213+80.00	-44.25'	Lt.	AL_VENICE	Index No. 214 - Curb Inlet Type 9 with Rectangular Bottom	Out:18" Round Concrete Pipe @ ELEV 7.10', S	11.06'
P	S-217	213+80.00	13.75'	Rt.	AL_VENICE	Index No. 214 - Curb Inlet Type 9 with Rectangular Bottom	Out:18" Round Concrete Pipe @ ELEV 7.10', N In:18" Round Concrete Pipe @ ELEV 7.10', S	11.18'
P	S-219	213+80.00	-13.75'	Lt.	AL_VENICE	Index No. 214 - Curb Inlet Type 9 with Rectangular Bottom	Out:24" Round Concrete Pipe @ ELEV 3.90', E In:18" Round Concrete Pipe @ ELEV 7.00', S In:24" Round Concrete Pipe @ ELEV 7.00', W In:18" Round Concrete Pipe @ ELEV 7.00', N	11.20'

NOTE: "EOP/RIM ELEV." REFERS TO THE PROPOSED EDGE OF PAVEMENT ELEVATION AT THE REFERENCED STATION FOR ALL CURB INLETS AND GUTTER INLETS (TYPE V), AND REFERS TO THE ELEVATION OF THE TOP OF THE RIM OR GRATE FOR ALL MANHOLES AND DITCH BOTTOM INLETS.

PREPARED FOR:	PREPARED BY:	PROJECT:	DESCRIPTION:	APPROVED BY:	DATE:
DESIGNED MLM	DRAWN MA	ATKINS	CITY OF VENICE DOWNTOWN ROADWAY CORRIDOR IMPROVEMENTS	NOKOMIS SYSTEM DRAINAGE STRUCTURE TABLES	JOHN SALATINO, P.E. P.E. LICENSE NUMBER 60921 ATKINS NORTH AMERICA (CERT. OF AUTH. NO. 24) 4030 WEST BOY SCOUT BOULEVARD, SUITE 700 TAMPA, FL 33607-1712
DRAWN MA	CHECKED MLM	Venice, FL City on the Gulf			DATE PROJECT NO.: SHEET:
Page 911 of 1140	REV. NO. DATE DESCRIPTION				2/28/2018 100054389 22

## STRUCTURE TABLE

Q T Y	STR. #	STATION	OFFSET	SIDE	BASELINE	DESCRIPTION	CONNECTED PIPE	EOP/RIM ELEV.
P	S-220	216+00.00	44.25'	Rt.	AL_VENICE	Index No. 214 - Curb Inlet Type 9 with Rectangular Bottom	Out:18" Round Concrete Pipe @ ELEV 7.10', N	10.89'
P	S-221	216+00.00	13.75'	Rt.	AL_VENICE	Index No. 214 - Curb Inlet Type 9 with Rectangular Bottom	Out:18" Round Concrete Pipe @ ELEV 7.00', N In :18" Round Concrete Pipe @ ELEV 7.00', S	11.03'
P	S-222	216+00.00	-44.25'	Lt.	AL_VENICE	Index No. 214 - Curb Inlet Type 9 with Rectangular Bottom	Out:18" Round Concrete Pipe @ ELEV 7.00', S	11.08'
P	S-223	216+00.00	-13.75'	Lt.	AL_VENICE	Index No. 214 - Curb Inlet Type 9 with Rectangular Bottom	Out:24" Round Concrete Pipe @ ELEV 6.90', W In :18" Round Concrete Pipe @ ELEV 6.90', S In :18" Round Concrete Pipe @ ELEV 6.90', N	11.22'
P	S-308	313+15.74	15.25'	Rt.	AL_MIAMI	Index No. 214 - Curb Inlet Type 9 with Round Bottom	Out:18" Round Concrete Pipe @ ELEV 5.40', NE	11.60'
P	S-311	314+13.60	-15.25'	Lt.	AL_MIAMI	Index No. 214 - Curb Inlet Type 9 with Round Bottom	Out:18" Round Concrete Pipe @ ELEV 5.20', SE In :18" Round Concrete Pipe @ ELEV 5.20', SW	11.35'
P	MH-311	314+53.36	13.70'	Rt.	AL_MIAMI	Index No. 201 - Type 7 Manhole (1 or 2-Piece Cover (Center), 7.0' Dia. Round Bottom)	Out:18" Round Concrete Pipe @ ELEV 4.20', E In :12" Round Concrete Pipe @ ELEV 7.71', W In :18" Round Concrete Pipe @ ELEV 4.80', NW	11.51'
P	S-312A	315+67.19	19.50'	Rt.	AL_MIAMI	Index No. 233 - Ditch Bottom Inlet - Type F, Alt. G	Out:24" Round Concrete Pipe @ ELEV 5.10', W In :24" Round Concrete Pipe @ ELEV 5.10', N	10.80'
P	S-312	316+00.00	19.25'	Rt.	AL_MIAMI	Index No. 214 - Curb Inlet Type 9 with Rectangular Bottom	Out:24" Round Concrete Pipe @ ELEV 5.20', W In :18" Round Concrete Pipe @ ELEV 5.20', N	10.59'
P	MH-312	316+00.00	0.00'	Rt.	AL_MIAMI	Index No. 201 - Type 8 Manhole (Concentric Cone with 1 or 2-Piece Cover (Edge), Round Bottom)	Out:18" Round Concrete Pipe @ ELEV 5.30', S In :18" Round Concrete Pipe @ ELEV 5.30', N In :18" Round Concrete Pipe @ ELEV 6.96', E	11.14'
P	S-313	316+00.00	-19.25'	Lt.	AL_MIAMI	Index No. 214 - Curb Inlet Type 9 with Rectangular Bottom	Out:18" Round Concrete Pipe @ ELEV 5.40', S	10.59'
P	S-4	505+32.25	0.00'	Rt.	AL_NOKOMIS	Index No. 201 - Type 7 Manhole (1 or 2-Piece Cover (Center), 8.0' Dia. Round Bottom)	Out:Exist. 48" Pipe to remain @ ELEV 6.56', N In :Exist. 48" Pipe to remain @ ELEV 6.56', S In :24" Round Concrete Pipe @ ELEV 4.90', E In :18" Round Concrete Pipe @ ELEV 3.80', W Sump Elev: 3.30'	11.87'
P	S-6	509+20.00	0.00'	Rt.	AL_NOKOMIS	Index No. 201 - Type 7 Manhole (1 or 2-Piece Cover (Center), 7.0' Dia. Round Bottom)	Out:Exist. 36" Pipe to remain @ ELEV 5.00', N In :Exist. 36" Pipe to remain @ ELEV 5.00', S In :24" Round Concrete Pipe @ ELEV 3.40', W In :24" Round Concrete Pipe @ ELEV 6.70', E Sump Elev.: 2.60'	11.74'
P	S-507	511+67.45	-19.25'	Lt.	AL_NOKOMIS	Index No. 214 - Curb Inlet Type 9 with Rectangular Bottom	Out:18" Round Concrete Pipe @ ELEV 3.50', E	9.79'
P	S-506	511+67.45	19.25'	Rt.	AL_NOKOMIS	Index No. 214 - Curb Inlet Type 9 with Rectangular Bottom	Out:18" Round Concrete Pipe @ ELEV 3.50', W	9.83'
P	S-7	511+67.45	2.56'	Rt.	AL_NOKOMIS	Index No. 201 - Type 7 Manhole (1 or 2-Piece Cover (Center), 7.0' Dia. Round Bottom)	Out:Exist. 36" Pipe to remain @ ELEV 3.01', N In :18" Round Concrete Pipe @ ELEV 3.40', E In :Exist. 36" Pipe to remain @ ELEV 3.01', S In :18" Round Concrete Pipe @ ELEV 3.40', W Sump Elev.: -0.70'	10.19'
P	S-8	512+53.14	3.22'	Rt.	AL_NOKOMIS	Index No. 201 - Type 7 Manhole (1 or 2-Piece Cover (Center), 10.0' Dia. Round Bottom)	Out:Exist. 48" Pipe to remain @ ELEV 0.61', N In :24" Round Concrete Pipe @ ELEV 3.10', W In :Exist. 48" Pipe to remain @ ELEV 0.64', S In :24" Round Concrete Pipe @ ELEV 4.80', E In :12"x18" Horizontal Elliptical Concrete Pipe @ ELEV 4.92', NW Sump Elev.: -0.90'	10.49'

NOTE: "EOP/RIM ELEV." REFERS TO THE PROPOSED EDGE OF PAVEMENT ELEVATION AT THE REFERENCED STATION FOR ALL CURB INLETS AND GUTTER INLETS (TYPE V), AND REFERS TO THE ELEVATION OF THE TOP OF THE RIM OR GRATE FOR ALL MANHOLES AND DITCH BOTTOM INLETS.


PREPARED FOR:	PREPARED BY:	PROJECT:	DESCRIPTION:	APPROVED BY:	DATE:
DESIGNED MLM	DRAWN MA	ATKINS	CITY OF VENICE DOWNTOWN ROADWAY CORRIDOR IMPROVEMENTS	JOHN SALATINO, P.E. P.E. LICENSE NUMBER 60921 ATKINS NORTH AMERICA (CERT. OF AUTH. NO. 24) 4030 WEST BOY SCOUT BOULEVARD, SUITE 700 TAMPA, FL 33607-1712	2/28/2018
DRAWN MA	CHECKED MLM	Venice, FL City on the Gulf	NOKOMIS SYSTEM DRAINAGE STRUCTURE TABLES		PROJECT NO.: 100054389
Page 912 of 1140	REV. NO. DATE DESCRIPTION				SHEET: 23

PIPE TABLE				
QTY	FROM STR.	TO STR.	PIPE SIZE (in)	LENGTH (ft)
F	MH-106	MH-108	18	283
F	S-110	S-111	18	32
F	S-111	S-8	24	66
F	S-506	S-7	18	14
F	S-507	S-7	18	14
F	S-313	MH-312	18	17
F	S-312	S-312A	24	31
F	S-107	MH-106	18	25
F	S-106	MH-106	18	12
F	S-109	MH-108	18	22
F	S-108	MH-108A	24	67
F	S-108A	MH-108A	24	21
F	MH-108A	S-8	24	80
F	MH-108	S-108	24	20
F	S-308	S-311	18	100
F	S-216	S-217	18	28
F	S-218	S-219	18	28
F	S-220	S-221	18	28

PIPE TABLE				
QTY	FROM STR.	TO STR.	PIPE SIZE (in)	LENGTH (ft)
F	S-222	S-223	18	28
F	S-219	S-6	24	106
F	S-217	S-219	18	26
F	S-223	S-6	24	105
F	S-221	S-223	18	27
F	S-311	MH-311	18	45
F	MH-311	S-4	18	33
F	S-212	S-213	18	30
F	S-213	S-215	18	27
F	S-215	S-219	24	278
F	S-214	S-215	18	29
F	MH-312	S-312	18	17
F	S-312A	S-4	24	63


DESIGNED MLM	DRAWN MA	CHECKED MLM	PREPARED FOR: 	PREPARED BY: <b>ATKINS</b>	PROJECT: CITY OF VENICE DOWNTOWN ROADWAY CORRIDOR IMPROVEMENTS	DESCRIPTION: NOKOMIS SYSTEM DRAINAGE PIPE TABLES	APPROVED BY: JOHN SALATINO, P.E. P.E. LICENSE NUMBER 60921 ATKINS NORTH AMERICA (CERT. OF AUTH. NO. 24) 4030 WEST BOY SCOUT BOULEVARD, SUITE 700 TAMPA, FL 33607-1712	DATE: 2/28/2018 PROJECT NO.: 100054389 SHEET: 24
Page 913 of 1140	REV. NO.	DATE	DESCRIPTION					



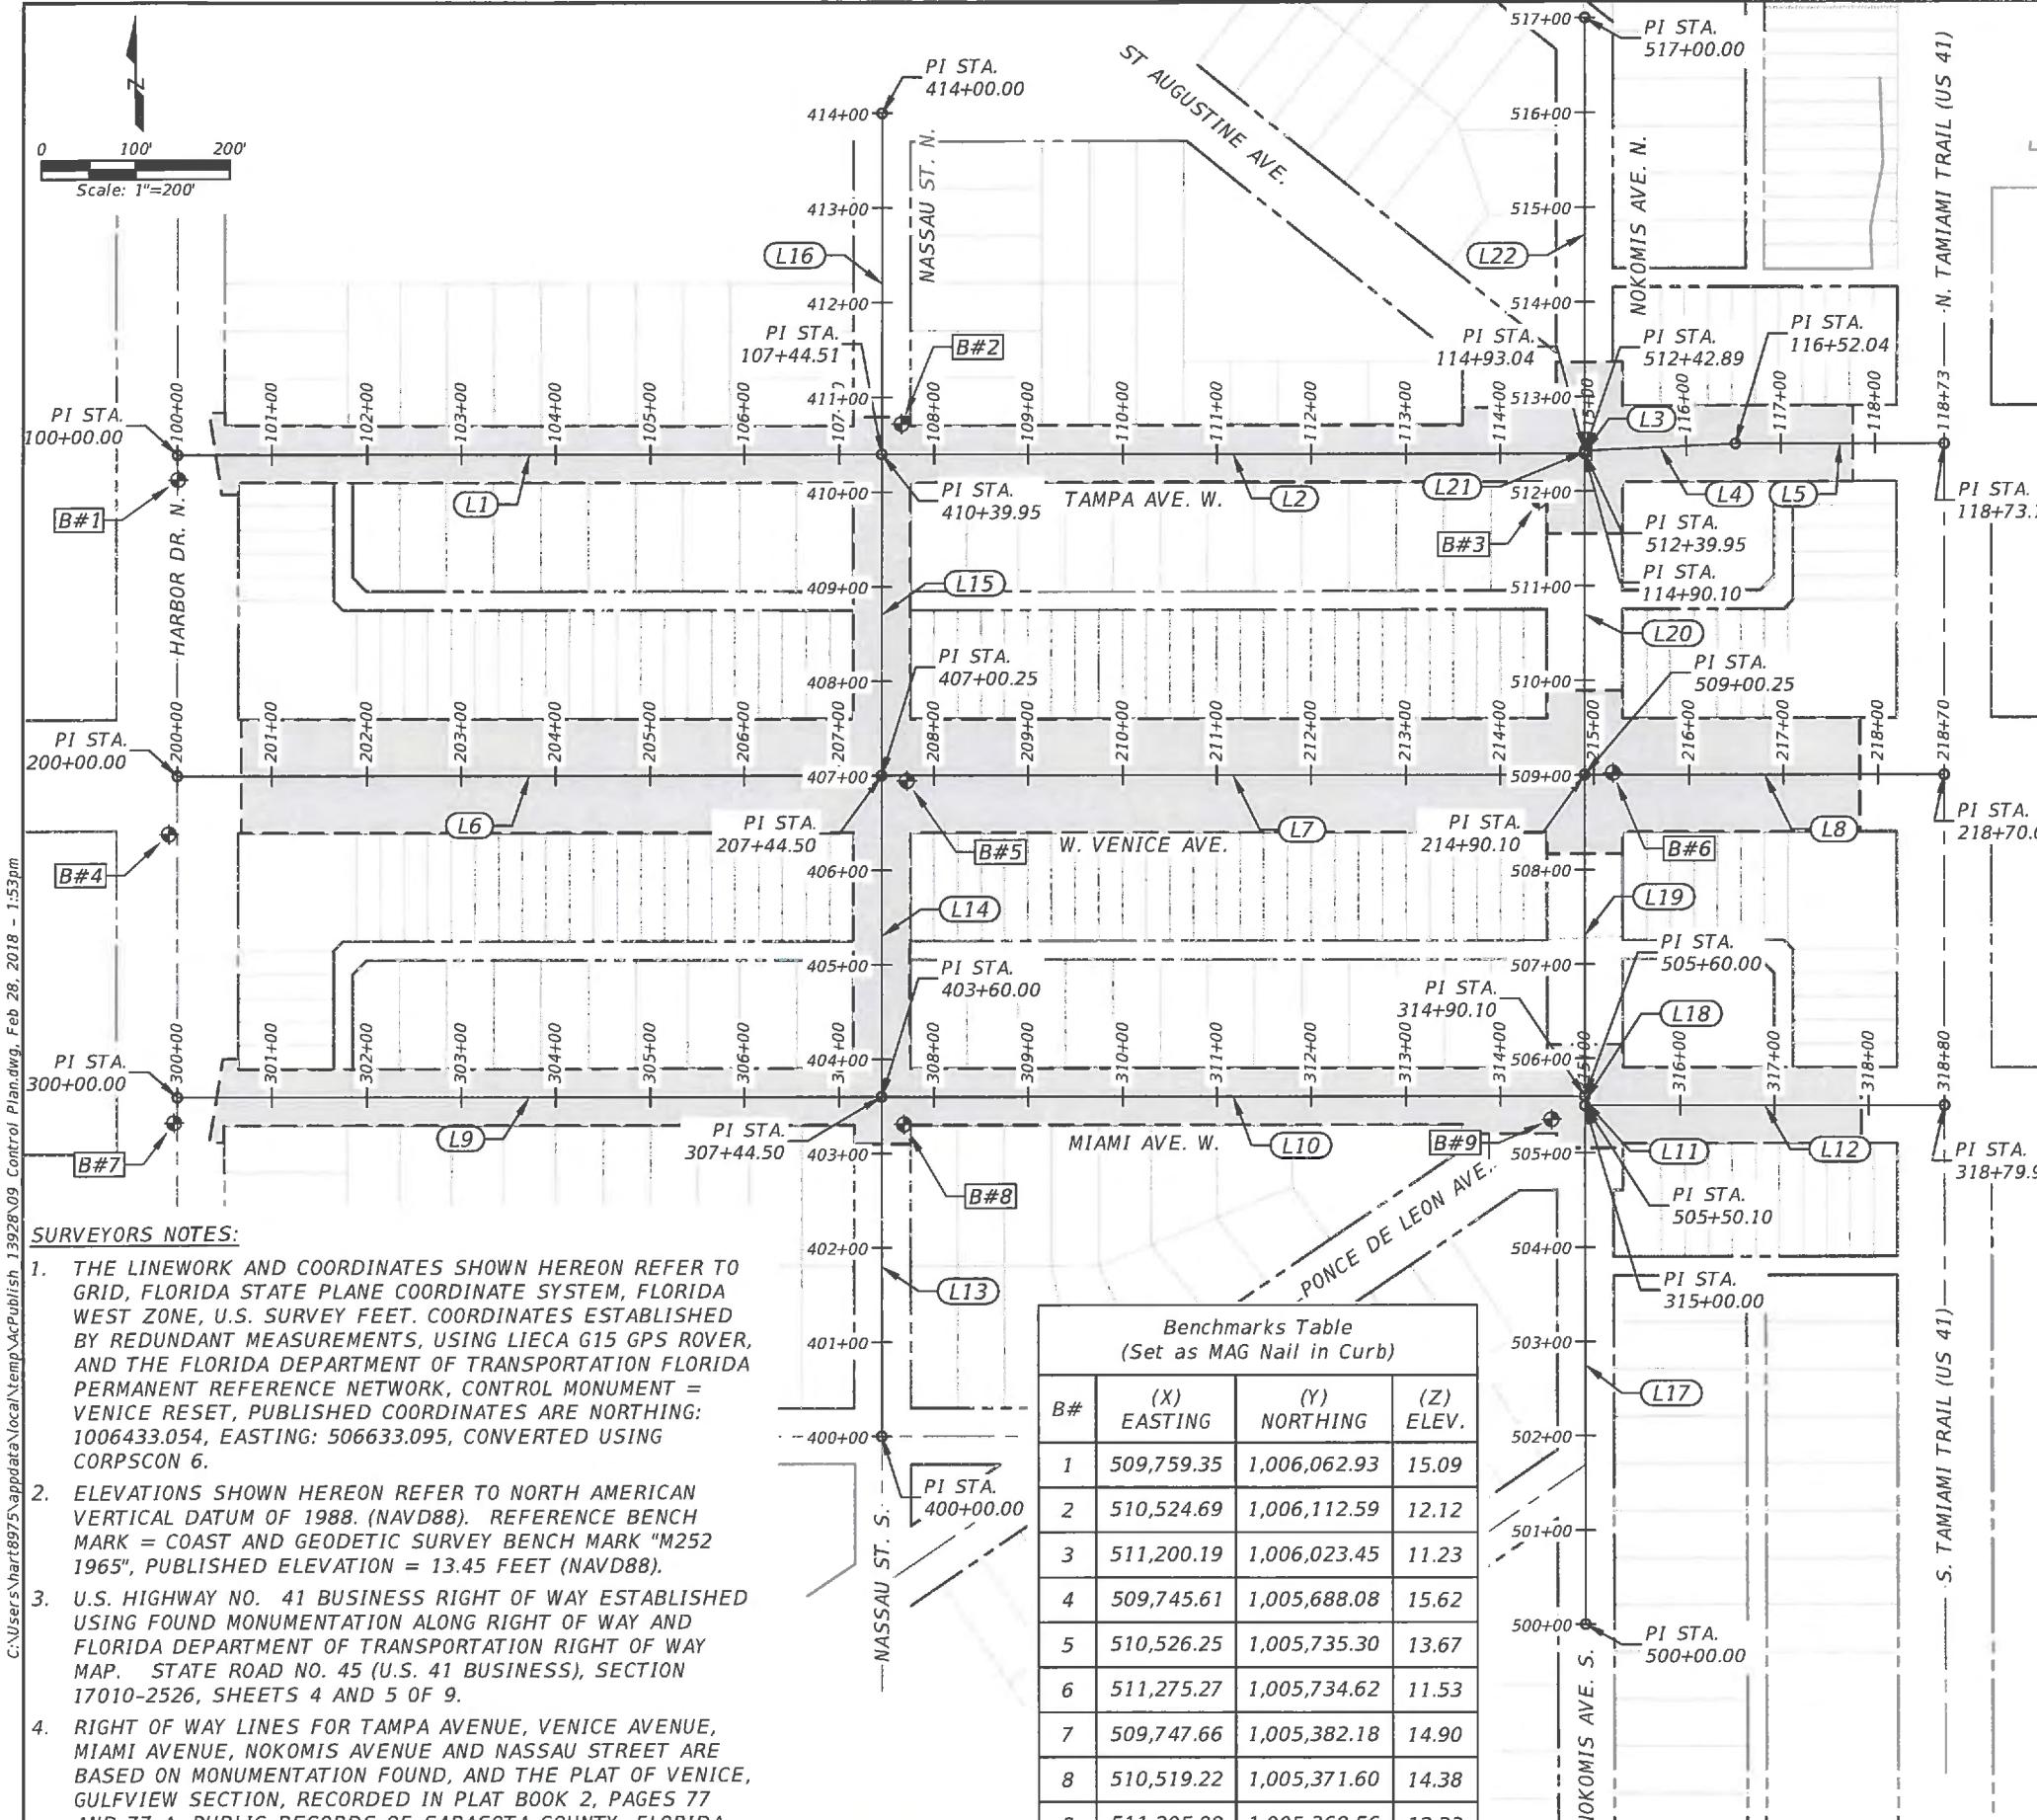

Line Table: Alignments					
Line #	Baseline	Length	Direction	Start Point	End Point
L1	Tampa	744.51	S 89° 21' 49" E	X=509,759.06 Y=1,006,089.18	X=510,503.52 Y=1,006,080.91
L2	Tampa	745.59	S 89° 21' 49" E	X=510,503.52 Y=1,006,080.91	X=511,249.07 Y=1,006,072.63
L3	Tampa	2.94	N 00° 38' 11" E	X=511,249.07 Y=1,006,072.63	X=511,249.10 Y=1,006,075.56
L4	Tampa	159.01	N 87° 58' 56" E	X=511,249.10 Y=1,006,075.56	X=511,408.01 Y=1,006,081.16
L5	Tampa	221.06	S 89° 21' 49" E	X=511,408.01 Y=1,006,081.16	X=511,629.06 Y=1,006,078.71
L6	Venice	744.50	S 89° 21' 49" E	X=509,755.28 Y=1,005,749.50	X=510,499.74 Y=1,005,741.23
L7	Venice	745.60	S 89° 21' 49" E	X=510,499.74 Y=1,005,741.23	X=511,245.29 Y=1,005,732.95
L8	Venice	379.90	S 89° 21' 49" E	X=511,245.29 Y=1,005,732.95	X=511,625.17 Y=1,005,728.73
L9	Miami	744.50	S 89° 21' 49" E	X=509,751.50 Y=1,005,409.27	X=510,495.96 Y=1,005,401.00
L10	Miami	745.60	S 89° 21' 49" E	X=510,495.96 Y=1,005,401.00	X=511,241.51 Y=1,005,392.72
L11	Miami	9.90	S 00° 38' 11" W	X=511,241.51 Y=1,005,392.72	X=511,241.40 Y=1,005,382.82
L12	Miami	379.90	S 89° 21' 49" E	X=511,241.40 Y=1,005,382.82	X=511,621.28 Y=1,005,378.60
L13	Nassau	360.00	N 00° 38' 11" E	X=510,491.96 Y=1,005,041.02	X=510,495.96 Y=1,005,401.00
L14	Nassau	340.25	N 00° 38' 11" E	X=510,495.96 Y=1,005,401.00	X=510,499.74 Y=1,005,741.23
L15	Nassau	339.70	N 00° 38' 11" E	X=510,499.74 Y=1,005,741.23	X=510,503.51 Y=1,006,080.91
L16	Nassau	360.05	N 00° 38' 11" E	X=510,503.51 Y=1,006,080.91	X=510,507.51 Y=1,006,440.94
L17	Nokomis	550.10	N 00° 38' 11" E	X=511,235.29 Y=1,004,832.75	X=511,241.40 Y=1,005,382.82
L18	Nokomis	9.90	N 00° 38' 11" E	X=511,241.40 Y=1,005,382.82	X=511,241.51 Y=1,005,392.72
L19	Nokomis	340.25	N 00° 38' 11" E	X=511,241.51 Y=1,005,392.72	X=511,245.29 Y=1,005,732.95
L20	Nokomis	339.70	N 00° 38' 11" E	X=511,245.29 Y=1,005,732.95	X=511,249.07 Y=1,006,072.63
L21	Nokomis	2.94	N 00° 38' 11" E	X=511,249.07 Y=1,006,072.63	X=511,249.10 Y=1,006,075.56
L22	Nokomis	457.11	N 00° 38' 11" E	X=511,249.10 Y=1,006,075.56	X=511,254.18 Y=1,006,532.65

PROJECT LIMITS

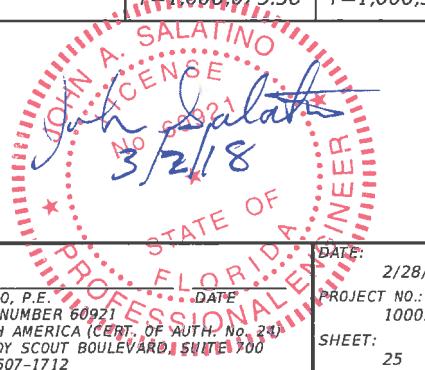

1. ALL STATIONS AND OFFSETS REFER TO BASELINE OF CONSTRUCTION UNLESS OTHERWISE NOTED. ALL ROADWAY DIMENSIONS ARE MEASURED FROM EDGE OF PAVEMENT.

2. THE CONTRACTOR SHALL PROVIDE ALL SHEETING, SHORING AND BRACING REQUIRED TO MEET THE REQUIREMENTS OF THE "TRENCH SAFETY ACT" (FLA. STATUTES, CH. 553, PART IV) AND TO PROTECT ADJACENT STRUCTURES OR TO MINIMIZE TRENCH WIDTH. THE COST FOR ALL SHEETING, SHORING AND BRACING REQUIRED SHALL BE INCLUDED IN THE CONTRACT PRICES FOR APPLICABLE PAY ITEMS IN THE CONTRACT.

3. THE CONSTRUCTION LENGTHS INDICATED IN THESE PLANS ARE APPROXIMATE. ACTUAL LIMITS MAY BE SET IN THE FIELD AS DIRECTED BY THE ENGINEER.

4. ALL DRIVEWAY AND RELATED SLOPE CONSTRUCTION OUTSIDE OF THE RIGHT-OF-WAY LIMITS SHALL BE SUBJECT TO THE PROPERTY OWNER'S APPROVAL. DRIVEWAY CONSTRUCTION IS TO COMPLY WITH FDOT INDEX 515 AND THE DETAILS SHOWN IN THESE PLANS.

5. ALL AREAS OF EXPOSED EARTH RESULTING FROM CONSTRUCTION ACTIVITIES SHALL BE SODDED.

6. NO SURFACING SHALL BE APPLIED TO ANY MANHOLE COVERS, FRAMES, VALVE BOXES, GAS DROPS, ETC. ALL EXISTING AND PROPOSED UTILITY AND STORM SEWER STRUCTURES WITH TOPS THAT WOULD BE EXPOSED WITHIN ANY PAVED AREA SHALL BE ADJUSTED SO THAT THE TOP SURFACE OF COVERS OR FRAMES SHALL BE FLUSH WITH THE PAVEMENT SURFACE.

7. EXISTING DRAINAGE STRUCTURES AND PIPES WITHIN THE LIMITS OF CONSTRUCTION SHALL BE REMOVED UNLESS OTHERWISE NOTED ON THE PLANS TO REMAIN.

8. THE CONTRACTOR SHALL PERFORM THE COMPLETE SURVEY STAKEOUT OF THE PROJECT (I.E. LINE, GRADE, SLOPE STAKE, UTILITY RELOCATIONS OR ANY OTHER STAKEOUT REQUIRED TO COMPLETE THE PROJECT IN ACCORDANCE WITH THE PLANS AND SPECIFICATIONS). ANY AND ALL EXPENSES INCURRED FOR THIS WORK SHALL BE INCLUDED IN THE UNIT PRICE BID FOR OTHER ITEMS. NO SEPARATE STAND-ALONE PAY ITEM IS INCLUDED FOR THIS WORK.

9. A LIMITED GEOTECHNICAL INVESTIGATION WAS PERFORMED. REFER TO REPORT DATED 4/3/17 BY ARDAMAN & ASSOCIATES, INC. FOR PAVEMENT CORES, SUBSURFACE SOIL CONDITIONS ALONG THE ROADWAYS.

10. ANY EXISTING PAVEMENT THAT IS TO BE REMOVED MUST BE SAW-CUT PRIOR TO REMOVAL. WHERE CONNECTIONS TO EXISTING WALKS AND DRIVES ARE NOT INDICATED ON THE PLANS, PROPER CONNECTIONS SHALL BE MADE AT THE DIRECTION OF THE ENGINEER.

11. THE TOPOGRAPHIC SURVEY INFORMATION SHOWN ON THE PLANS WAS PERFORMED BY RANDALL E. BRITT, PSM #3979, IN SURVEY DATED 3/2/2017 FOR THE CITY OF VENICE. BRITT SURVEYING, INC. TELEPHONE (941) 493-1396.

12. THE ELEVATIONS SHOWN ON THESE PLANS ARE REFERENCED TO NORTH AMERICAN VERTICAL DATUM OF 1988 (NAVD88).

13. LOCATIONS, ELEVATIONS AND DIMENSIONS OF EXISTING UTILITIES, STRUCTURES, AND OTHER FEATURES ARE APPROXIMATE AND ARE SHOWN ACCORDING TO THE BEST INFORMATION AVAILABLE AT THE TIME THESE DRAWINGS WERE PREPARED, BUT DO NOT PURPORT TO BE ABSOLUTELY CORRECT. THE UNDERGROUND UTILITIES HAVE NOT BEEN POSITIVELY LOCATED. THE CONTRACTOR SHALL BE RESPONSIBLE FOR DETERMINING THE EXACT SIZE, LOCATION, DEPTH, HEIGHT, ELEVATION, DIMENSION, AND EXTENT OF ALL UNDERGROUND AND OVERHEAD FACILITIES AND OTHER FEATURES AFFECTING HIS WORK PRIOR TO PROCEEDING WITH ANY CONSTRUCTION ACTIVITY THAT MAY AFFECT SUCH FACILITIES. THE CONTRACTOR SHALL BE RESPONSIBLE FOR ANY DAMAGE CAUSED BY FAILURE TO COMPLY WITH THESE INSTRUCTIONS.

14. THE CONTRACTOR SHALL BE RESPONSIBLE FOR THE COMPLETE COORDINATION OF CONSTRUCTION SCHEDULING BETWEEN THE CONTRACTOR AND ALL UTILITY AGENCIES.

a. NOTE: THIS INCLUDES MEETING WITH UTILITY AGENCIES PRIOR TO THE PRE-CONSTRUCTION CONFERENCE TO ADJUST THEIR SCHEDULES TO COINCIDE WITH THE CONTRACTOR'S CONSTRUCTION SCHEDULE.

b. WEEKLY COORDINATION IS REQUIRED BETWEEN CONTRACTOR AND UTILITY AGENCIES.

15. EXCEPT WHERE THE PLANS AND SPECIFICATIONS PROVIDE THAT SUCH WORK SHALL BE PERFORMED UNDER THE CONTRACT FOR THIS PROJECT, ALL UTILITIES INTERFERING WITH CONSTRUCTION SHALL BE REMOVED, RELOCATED OR ADJUSTED BY THEIR OWNERS, AT THEIR EXPENSE. THE CONTRACTOR SHALL ARRANGE HIS SCHEDULE TO ALLOW UTILITY OWNERS TIME FOR THE NECESSARY RELOCATION AND ADJUSTMENT OF UTILITIES AND RELATED STRUCTURES. THE FOLLOWING UTILITIES MAY HAVE LINES AND FACILITIES WITHIN THE PROJECT AREA.

a. CITY OF VENICE - WATER/SEWER	Damien Stillings	941-882-7316 c
b. FRONTIER COMMUNICATIONS	Denise Hutton	941-504-9652 c
c. COMCAST CABLE COMMUNICATIONS	Paul Bahizi	239-253-7505 c
d. FPL DISTRIBUTION	Greg Coker	941-704-9087 c
e. TECO PGS	Danny Shanahan	941-342-4006 o

16. CALL SUNSHINE 811 AT (800) 432-4770 OR 811 48 HOURS IN ADVANCE FOR UTILITY LOCATES. ALL UTILITY OWNERS MAY NOT BE A MEMBER AND MAY REQUIRE DIRECT CONTACT. THE CONTRACTOR IS RESPONSIBLE TO FURTHER COORDINATE WITH THE UTILITY OWNERS TO RESOLVE CONFLICTS THAT MAY ARISE IN THE FIELD DURING CONSTRUCTION. THE CONTRACTOR WILL BE RESPONSIBLE FOR ANY UTILITIES DAMAGED AS A RESULT OF THE CONTRACTOR'S FAILURE TO CALL "SUNSHINE 811" AND THE UTILITY OWNERS AND TO PRESERVE/PROTECT USING STANDARD CARE MEASURES.


17. CONTAMINATION NOTE - COORDINATE ALL DEWATERING ACTIVITIES THROUGH THE CITY OF VENICE. THE FLORIDA DEPARTMENT OF ENVIRONMENTAL PROTECTION (FDEP) MUST REVIEW ANY DEWATERING PLANS AND MAY REQUIRE ADDITIONAL PERMITTING AND THE IMPLEMENTATION OF EFFLUENT TREATMENT ACTIVITIES DUE TO THREE (3) PETROLEUM-CONTAMINATED FACILITIES LOCATED WITHIN FIVE-HUNDRED FEET (500') OF THE EASTERN PROJECT LIMITS. THE COORDINATION AND PREPARATION OF DEWATERING PLANS IS INCLUDED WORK UNDER THIS CONTRACT. PAYMENT WOULD BE INCLUDED UNDER THE VARIOUS ITEMS PAY ITEMS IN THE CONTRACT. THERE IS NO SEPARATE STAND-ALONE PAY ITEM FOR THIS WORK.

18. FOR STORM PIPES, UTILIZE CLASS III FOR ROUND CONCRETE PIPES AND CLASS HE-III FOR ELLIPTICAL CONCRETE PIPES.


## UTILITIES

CATV OVERHEAD  
CATV BURRIED  
ELECTRIC BURRIED  
ELECTRIC OVERHEAD  
BURRIED FIBER OPTIC (CO)  
FRONTIER COMM-BURRIED  
FRONTIER COMM-OVERHEAD  
GAS LINE  
WATERLINE  
SANITARY FORCEMAIN  
*Sanitary Sewer (Gravity)*

The diagram illustrates the complex beamline configuration of the NA3 experiment at CERN. The beam path starts with an OTV, followed by a BTV(B) component. Subsequent sections include BE, OE, BFO(C), BFC, OFC, GAS, W, FM, S, and another FM section. The connections are represented by various line styles, such as dashed and dash-dot lines, indicating different types of components or materials used in the construction of the beamline.

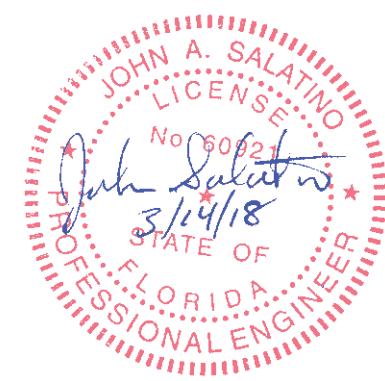


				PREPARED FOR:	PREPARED BY:	PROJECT:	DESCRIPTION:	APPROVED BY:	DATE:	
				DESIGNED MLM		ATKINS	CITY OF VENICE DOWNTOWN ROADWAY CORRIDOR IMPROVEMENTS	JOHN SALATINO, P.E. P.E. LICENSE NUMBER 60921 ATKINS NORTH AMERICA (CERT. OF AUTH. NO. 24) 4030 WEST BOY SCOUT BOULEVARD, SUITE 700 TAMPA, FL 33607-1212	3/13/2018	
				DRAWN MA					DATE	
				CHECKED MLM					PROJECT NO.:	
				Page 915 of 1140					100054389	SHEET:
REV. NO.	DATE	DESCRIPTION							26	


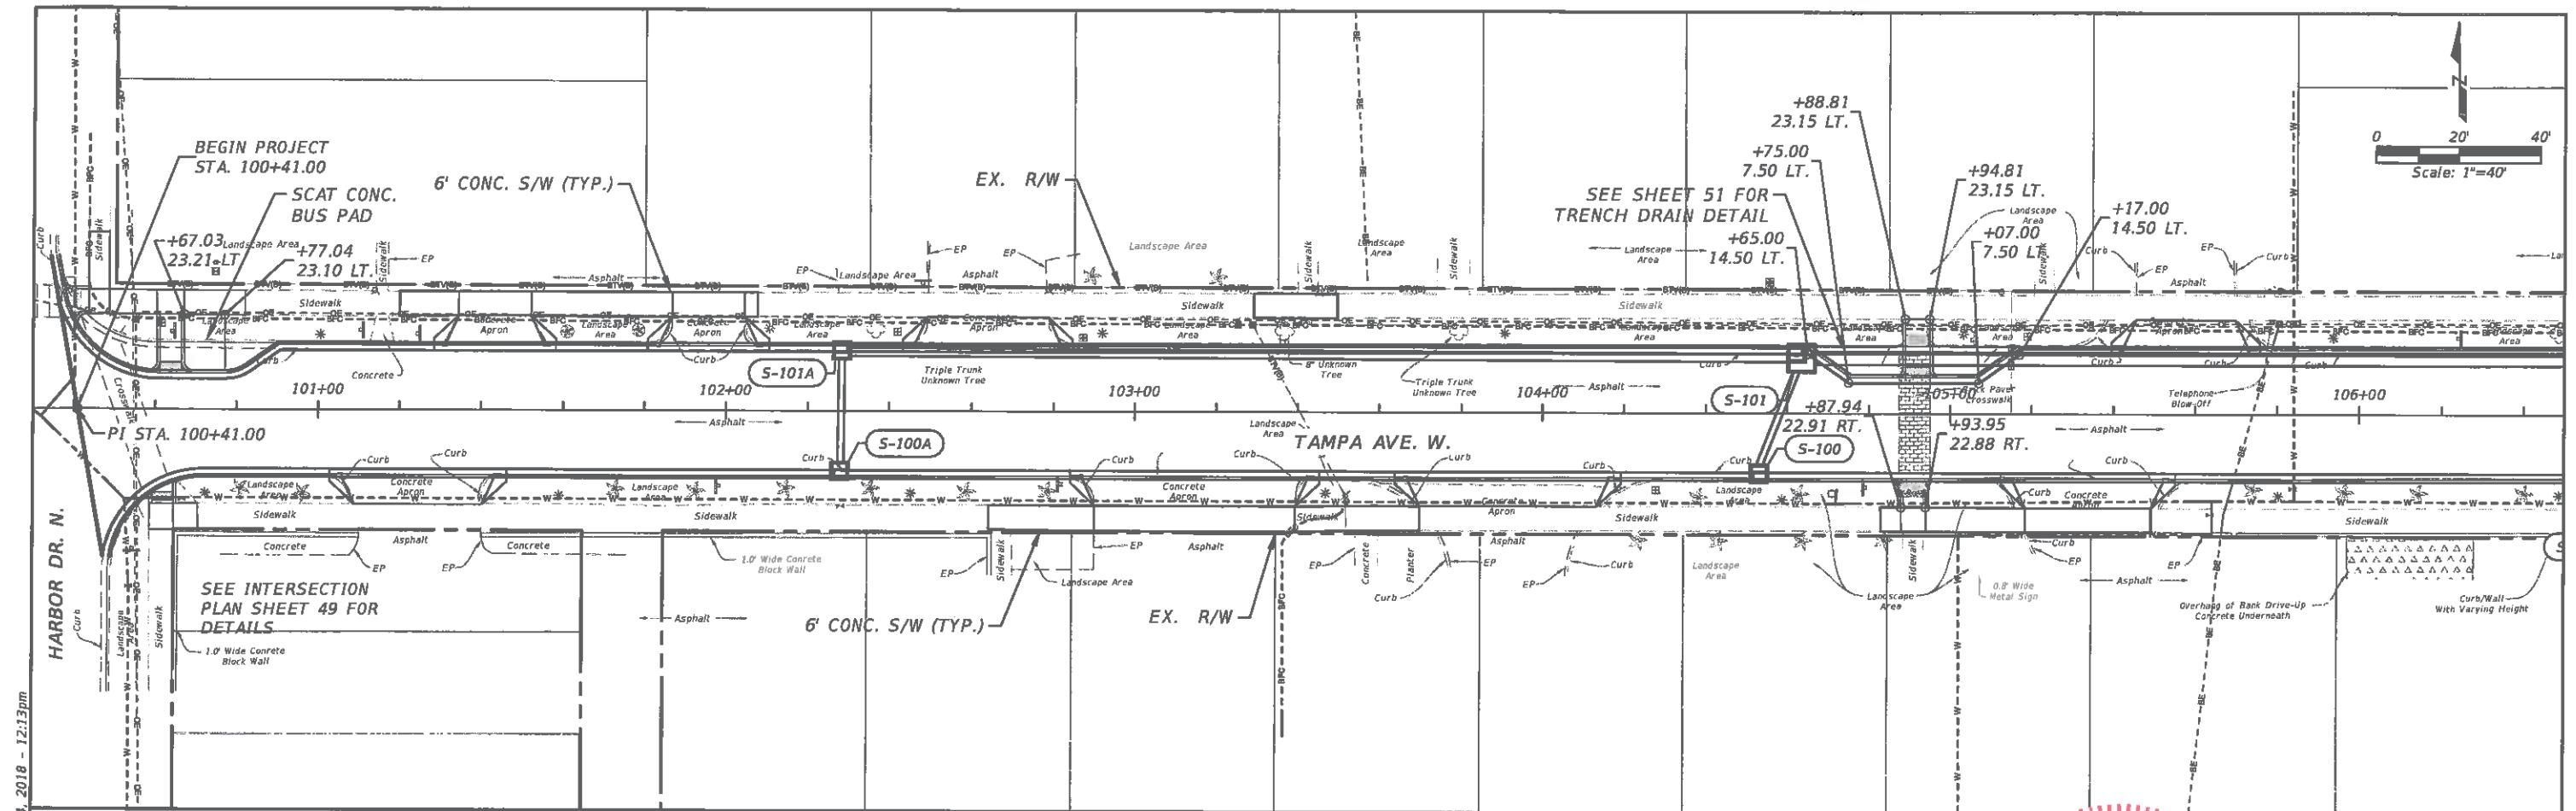


JOHN A. SALATINO  
LICENSE No 60921  
John Salatino  
3/14/18  
STATE OF FLORIDA  
PROFESSIONAL ENGINEER



HOR.: 0 20' 40'  
VER.: 0 2' 4'  
SCALE : FEET

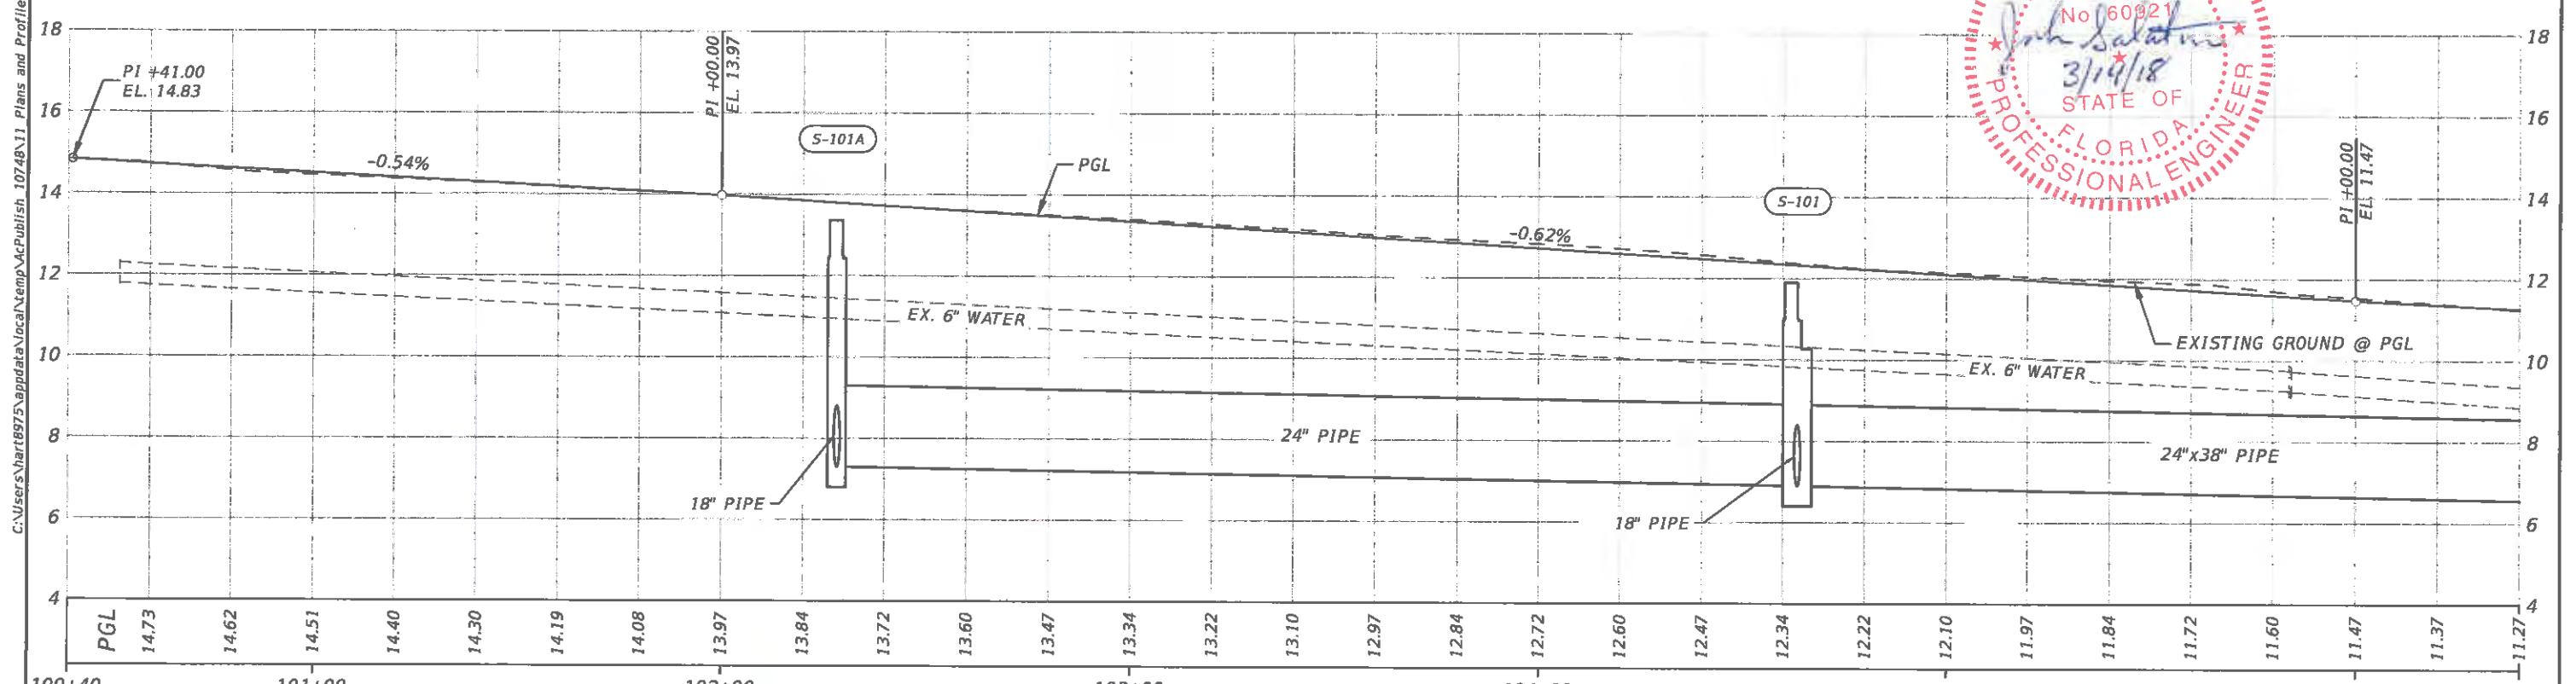

			PREPARED FOR:	PREPARED BY:	PROJECT:	DESCRIPTION:	APPROVED BY:	DATE:
			DESIGNED MLM	DRAWN MA	PROJECT:	CITY OF VENICE	TAMPA AVE.	DATE:
			DRAWN MLM	DRAWN MA	DESCRIPTION:	DOWNTOWN ROADWAY	PLAN-PROFILE	3/14/2018
			CHECKED MLM	CHECKED MLM	STA. 100+40 TO STA. 106+40	CORRIDOR IMPROVEMENTS	APPROVED BY:	PROJECT NO.:
Page 946 of 1140	REV. NO.	DATE	Venice, FL City on the Gulf	ATKINS	John Salatino, P.E. P.E. LICENSE NUMBER 60921 ATKINS NORTH AMERICA (CERT. OF AUTH. NO. 24) 4030 WEST BOY SCOUT BOULEVARD, SUITE 700 TAMPA, FL 33607-1712	DATE: 3/14/2018 PROJECT NO.: 100054389 SHEET: 27		

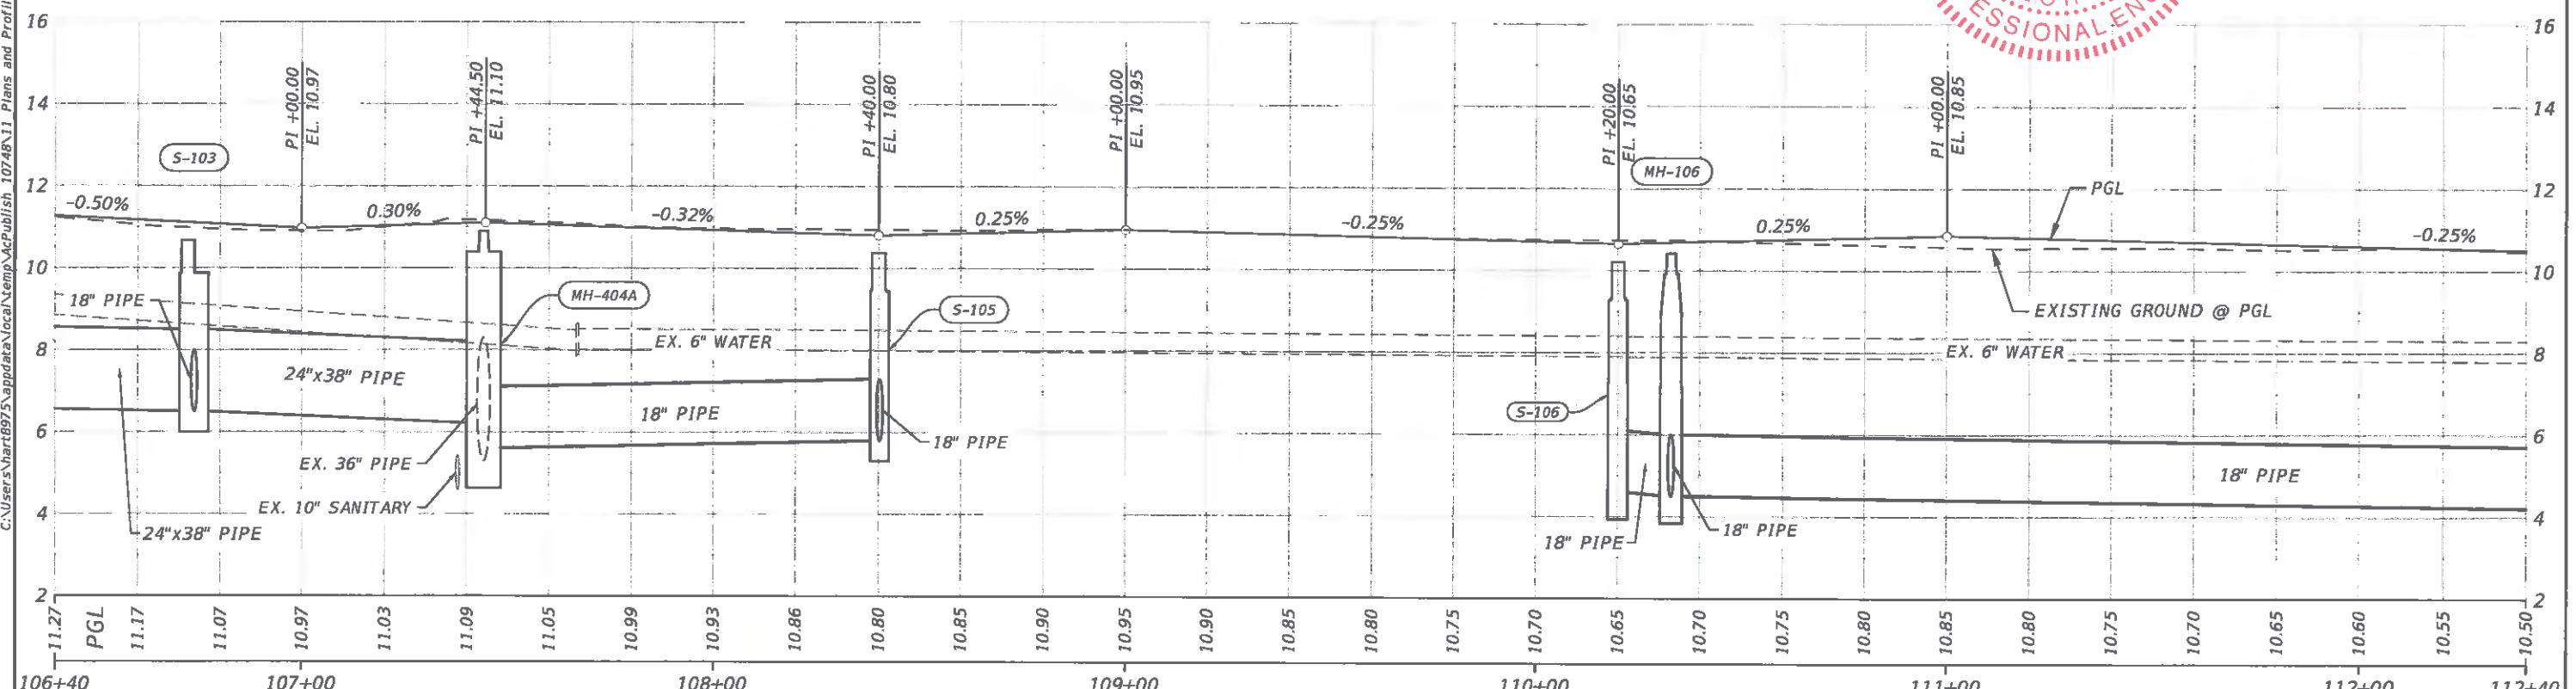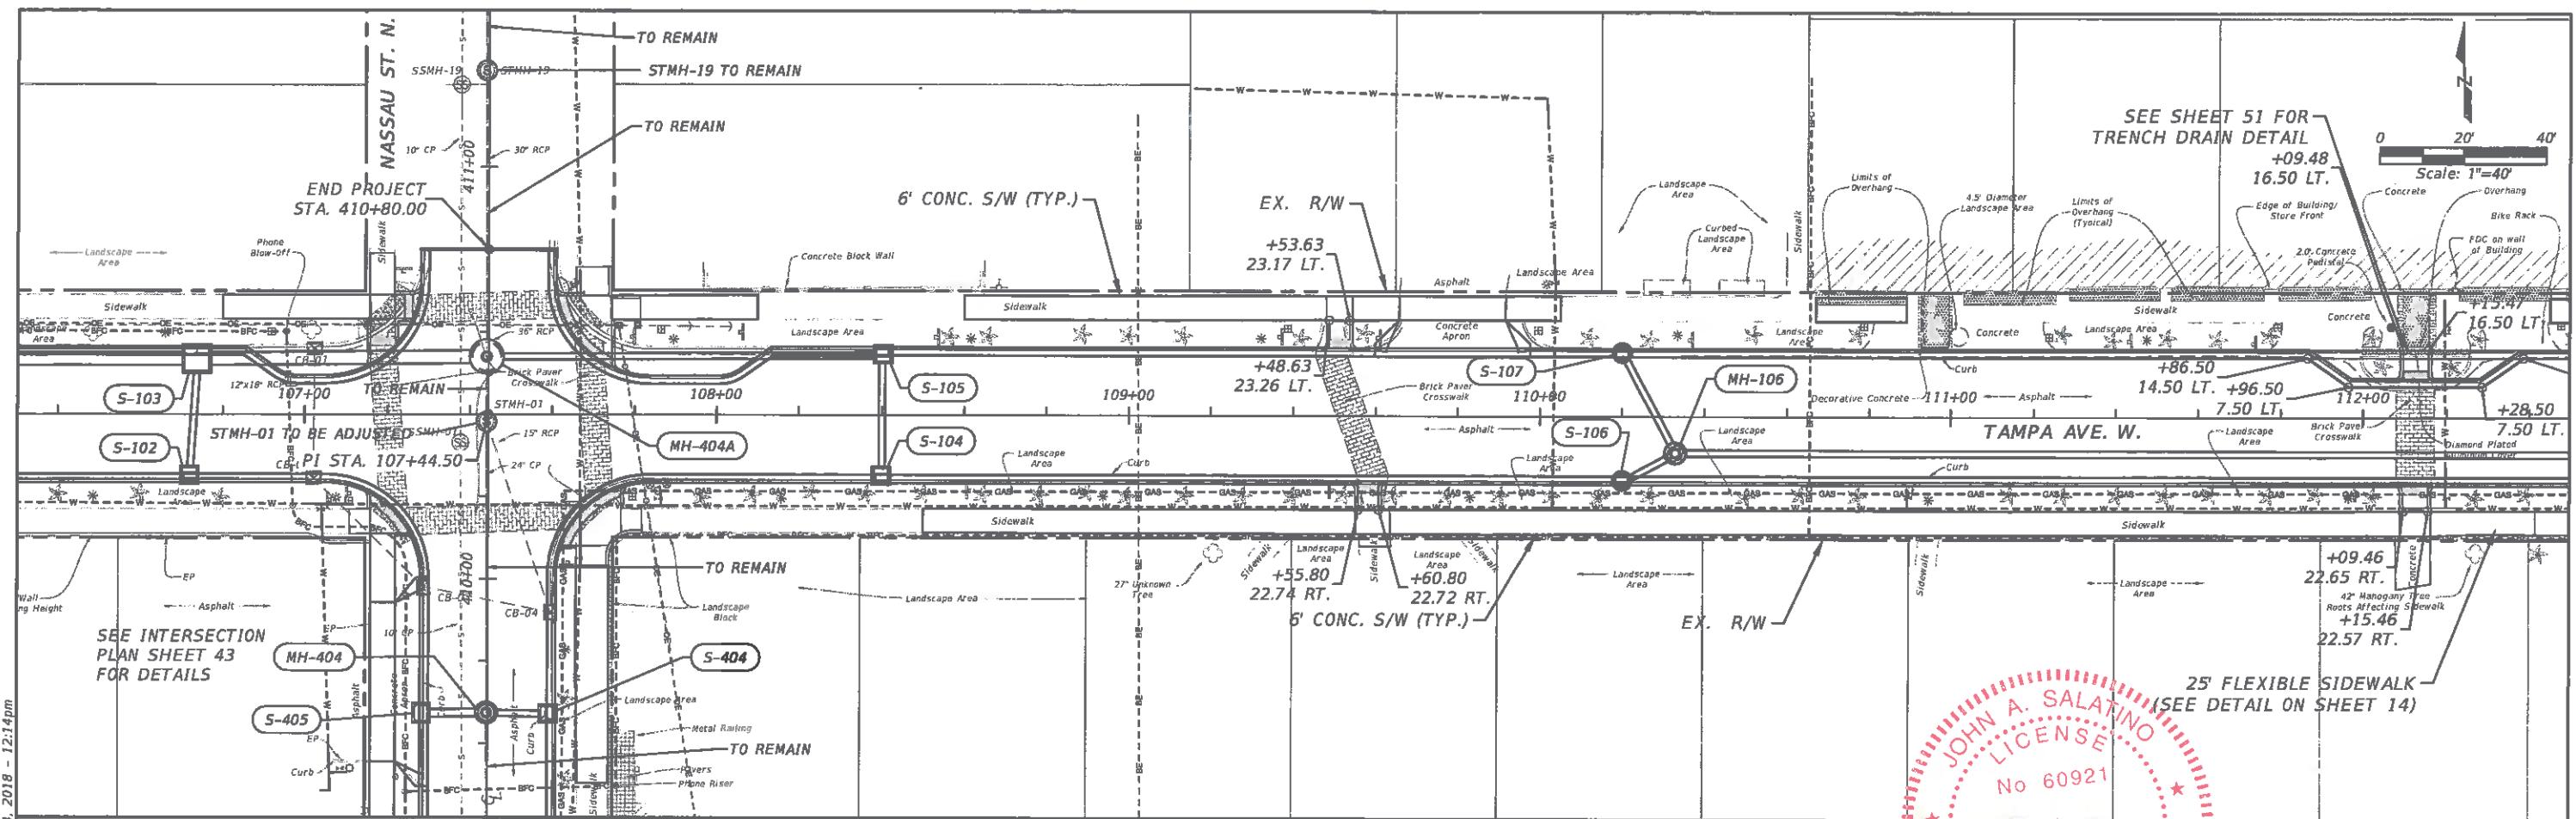

		PREPARED FOR:	PREPARED BY:	PROJECT:	DESCRIPTION:	APPROVED BY:	DATE:
		DESIGNED MLM	DRAWN MA	ATKINS	CITY OF VENICE DOWNTOWN ROADWAY CORRIDOR IMPROVEMENTS	JOHN SALATINO, P.E. P.E. LICENSE NUMBER 60921 ATKINS NORTH AMERICA (CERT. OF AUTH. NO. 24) 4030 WEST BOY SCOUT BOULEVARD, SUITE 700 TAMPA, FL 33607-1712	3/14/2018
REV. NO.	DATE	DESCRIPTION				PROJECT NO.: 100054389	
Page 917 of 1140						SHEET: 28	

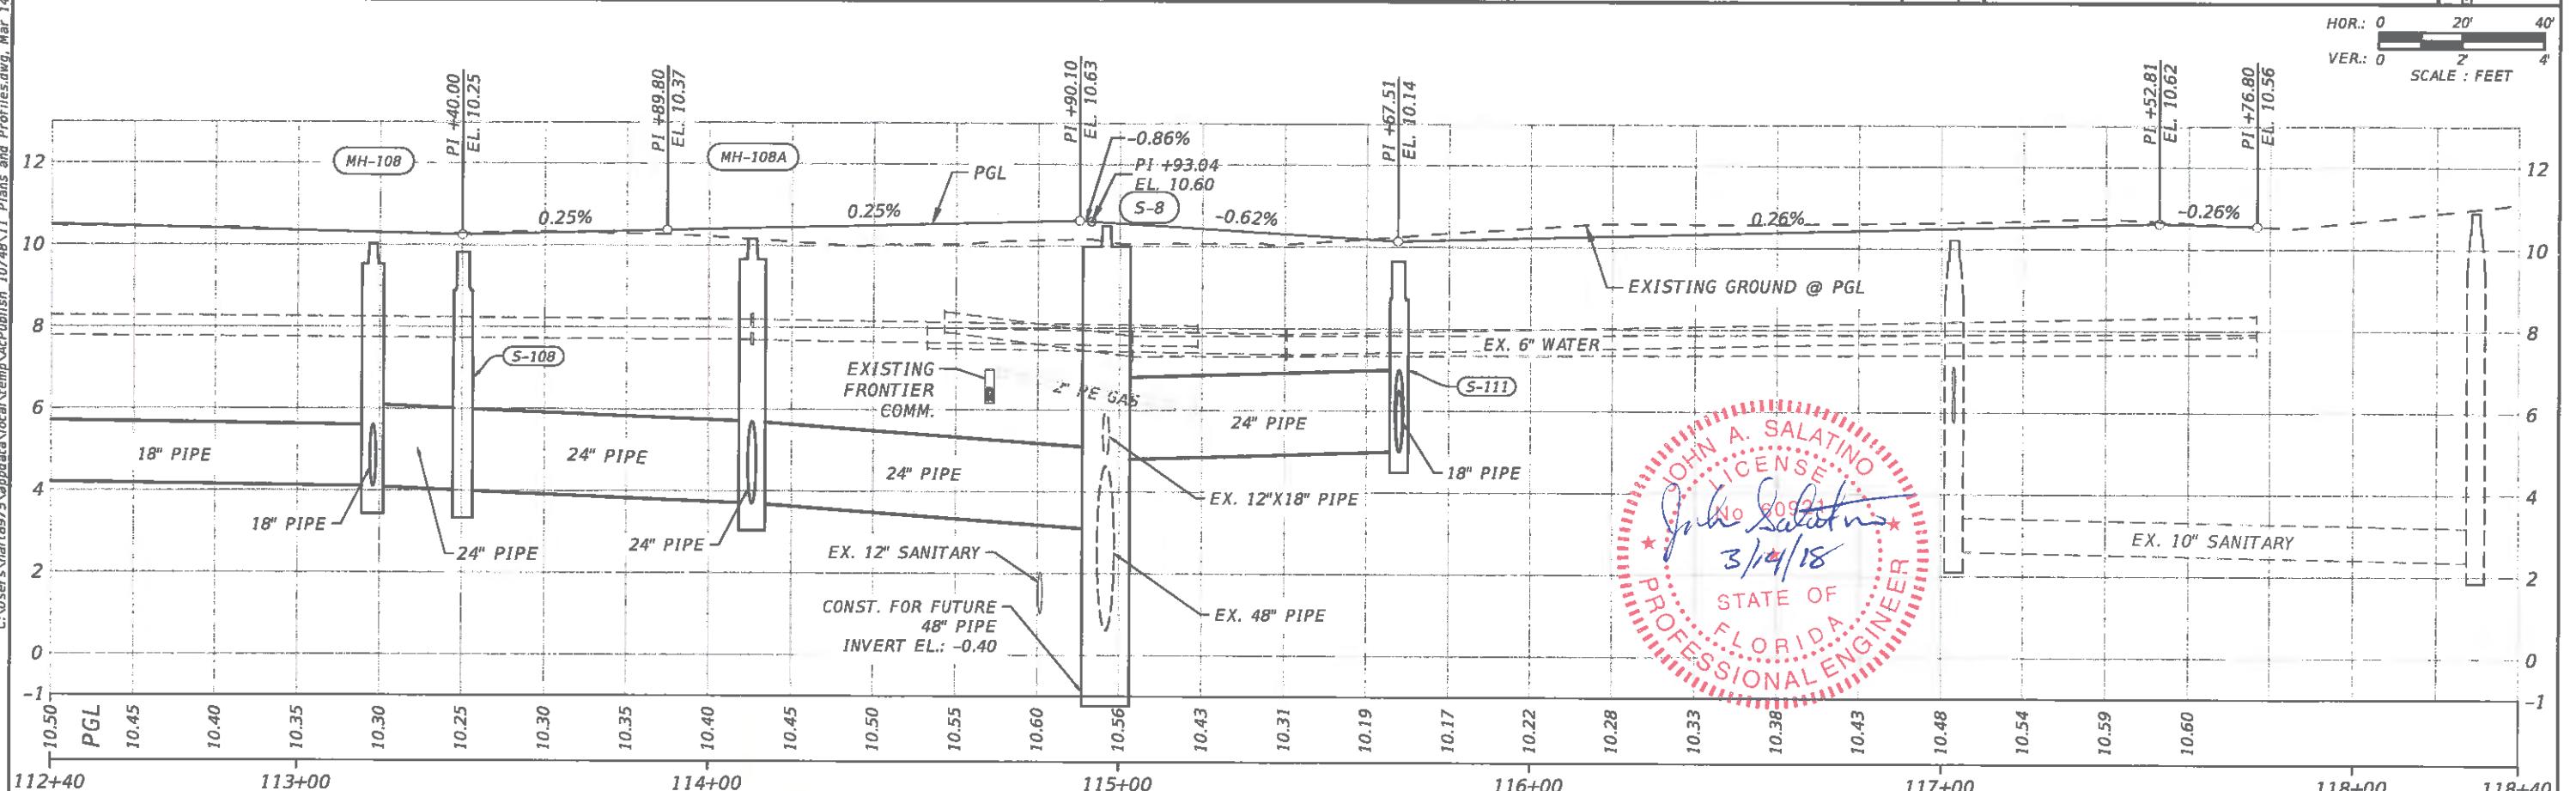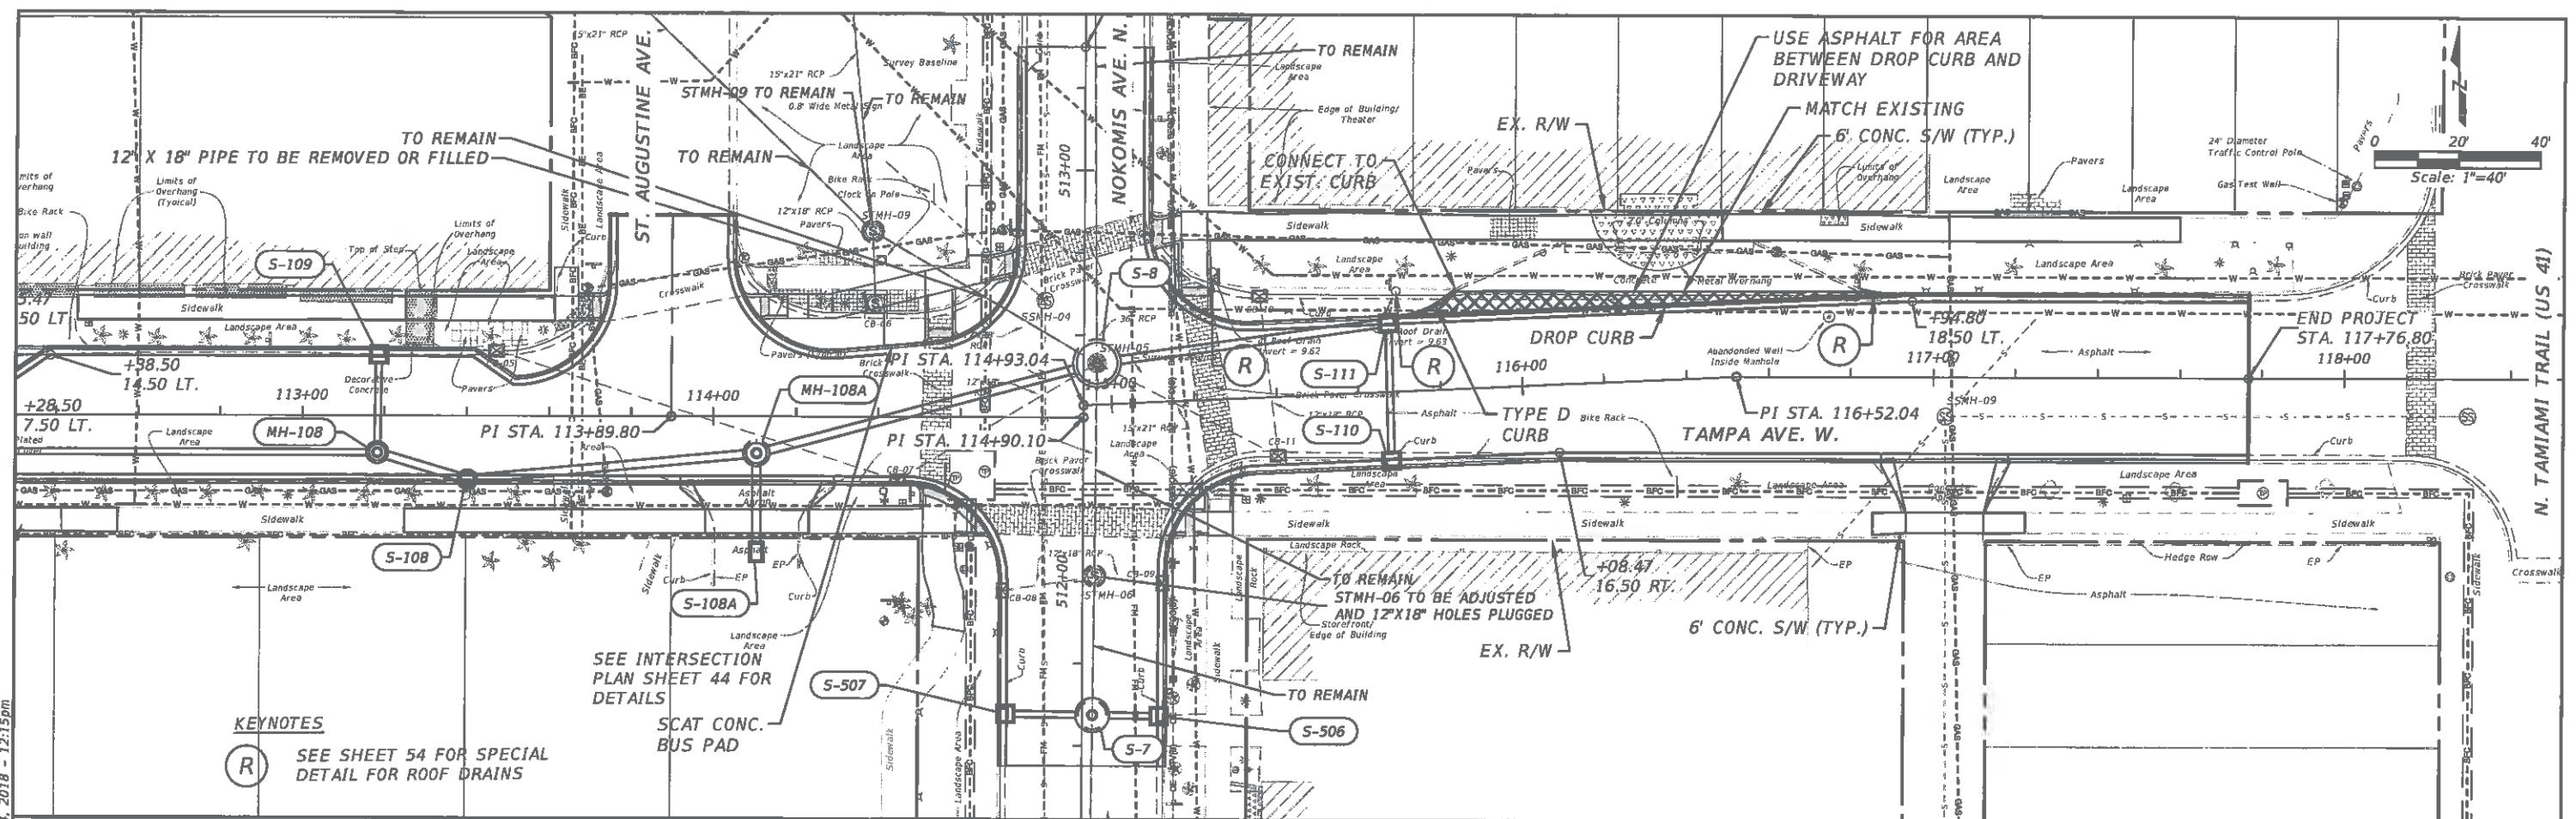


PREPARED FOR:	PREPARED BY:	PROJECT:	DESCRIPTION:	APPROVED BY:	DATE:
DESIGNED MLM			CITY OF VENICE DOWNTOWN ROADWAY CORRIDOR IMPROVEMENTS	JOHN SALATINO, P.E. P.E. LICENSE NUMBER 60921 ATKINS NORTH AMERICA (CERT. OF AUTH. NO. 24) 4030 WEST BOY SCOUT BOULEVARD, SUITE 700 TAMPA, FL 33607-1712	3/14/2018
DRAWN MA			TAMPA AVE. PLAN-PROFILE		PROJECT NO.: 100054389
CHECKED MLM			STA. 112+40 TO STA. 118+40		SHEET: 29


Page 918 of 1140

REV. NO. DATE DESCRIPTION

Venice, FL City on the Gulf



ATKINS

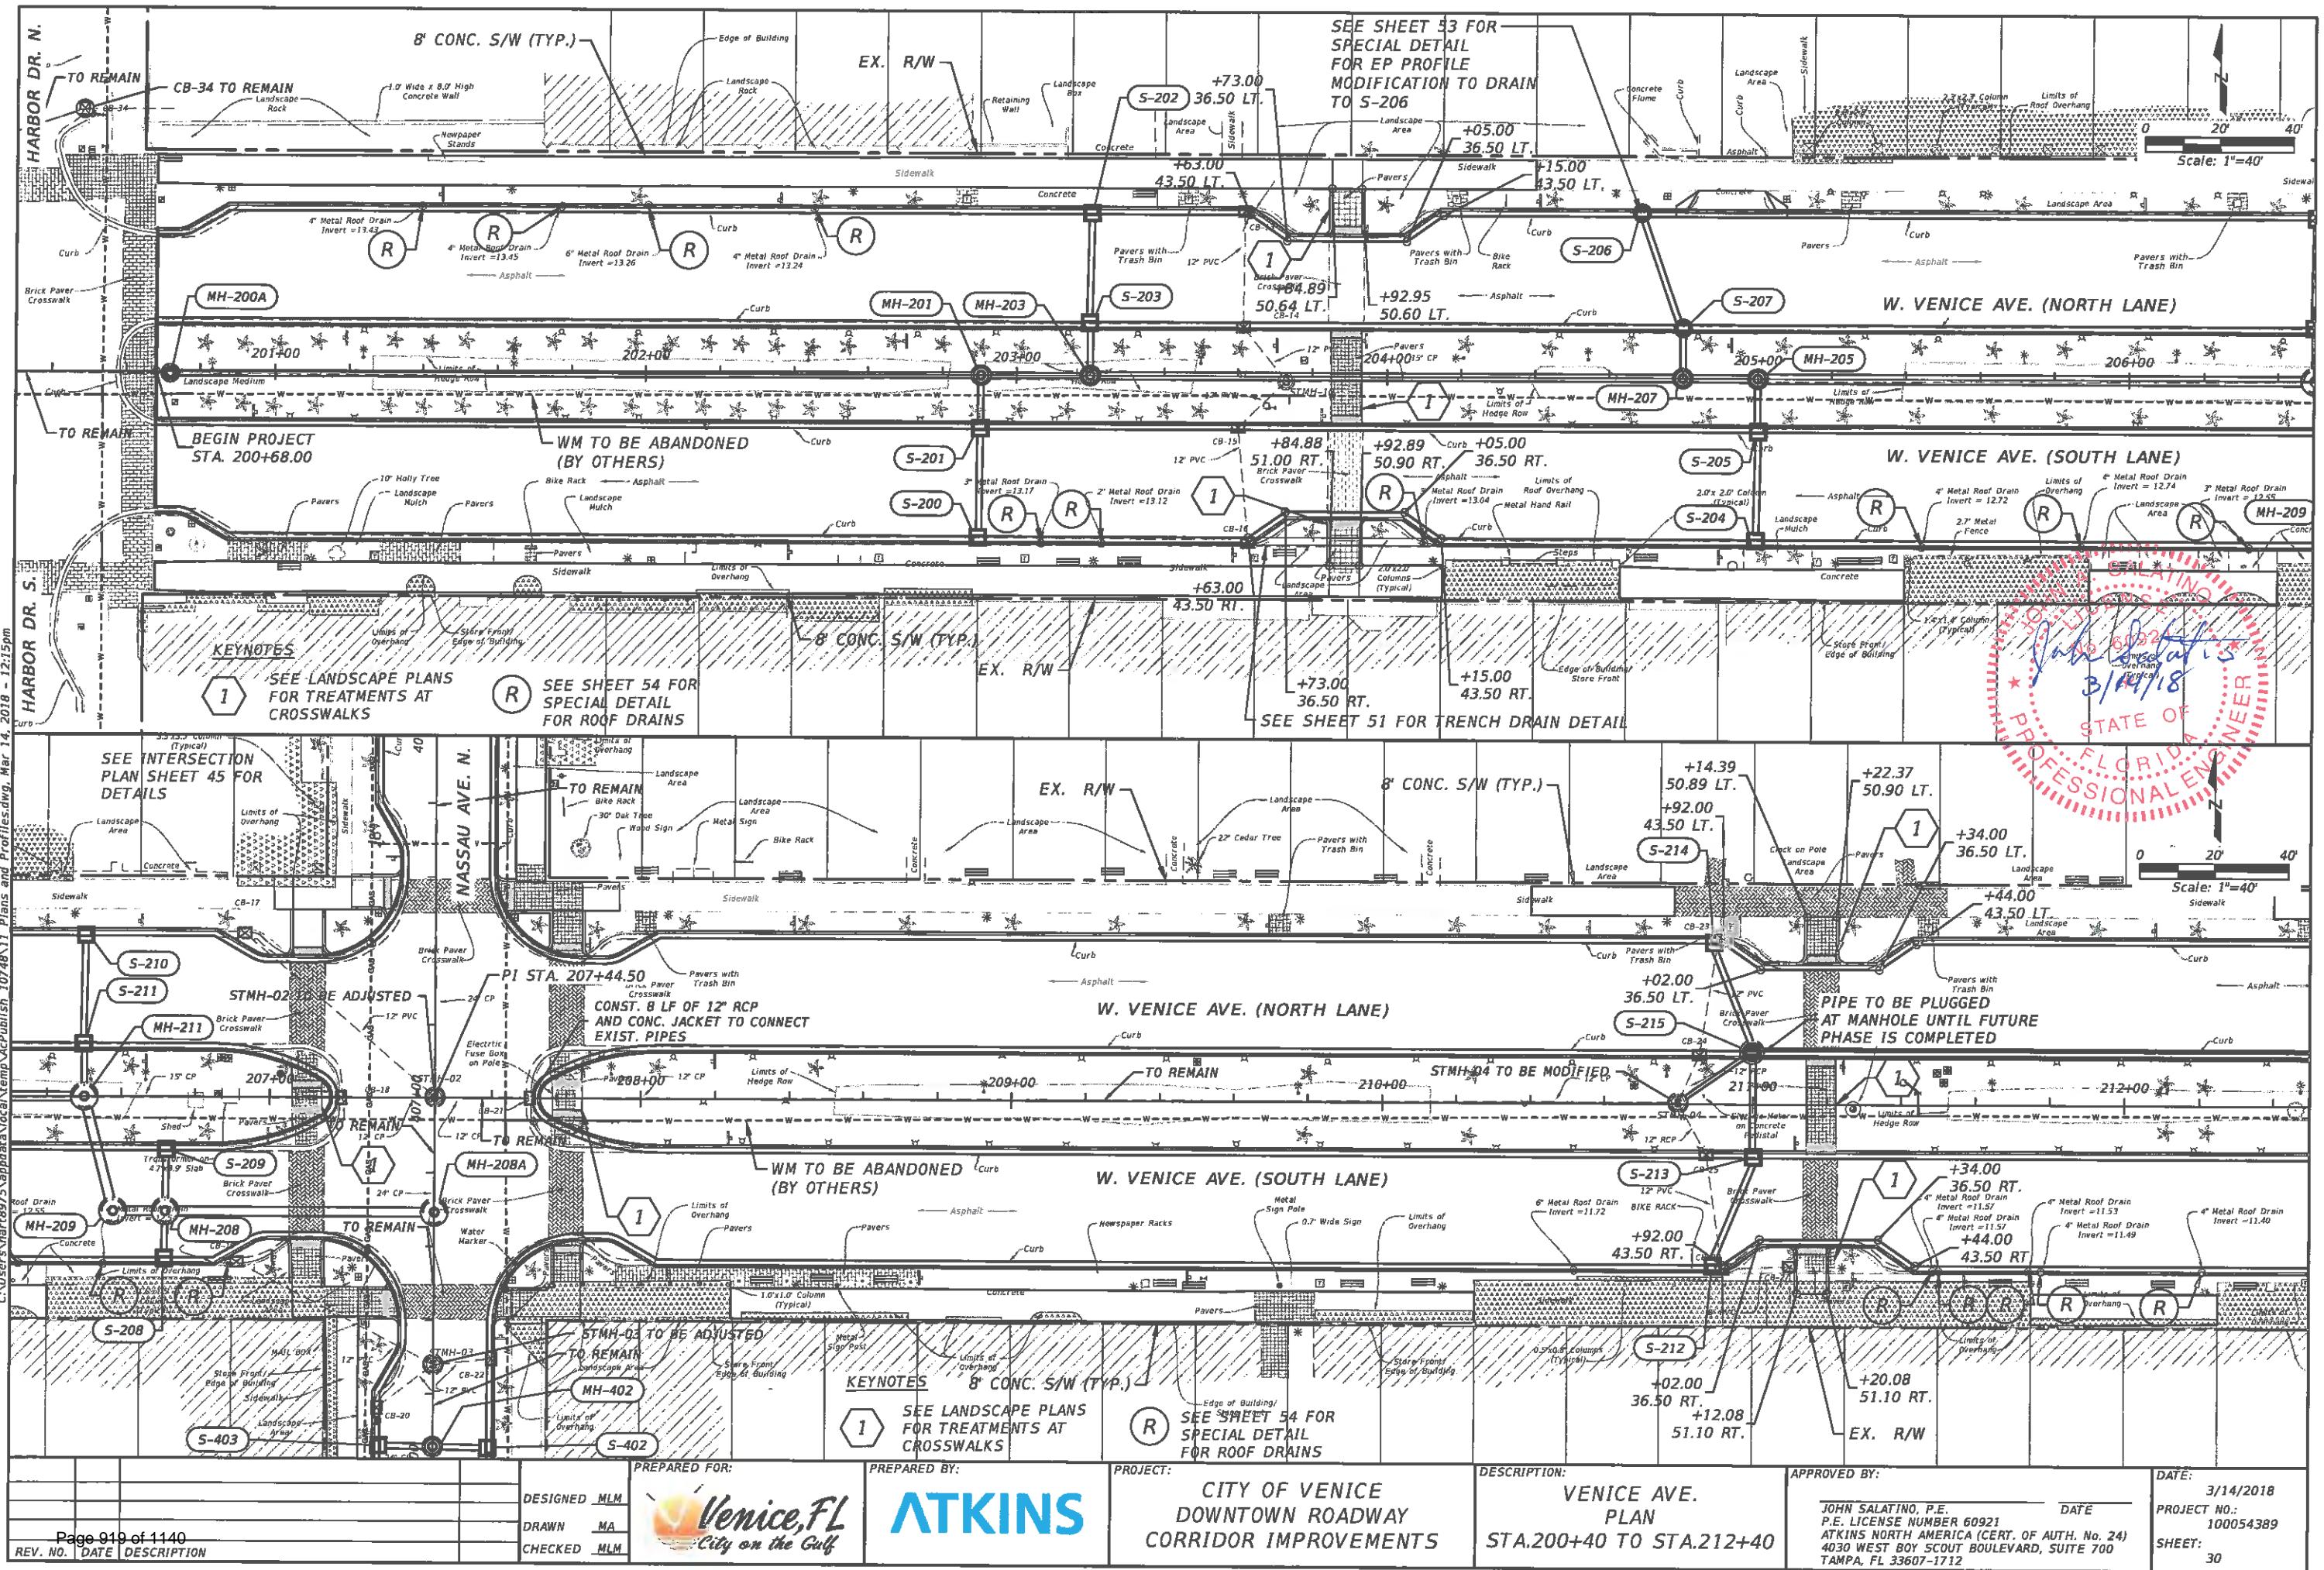

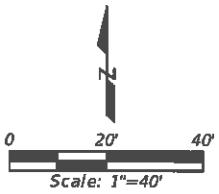

N. TAMiami TRAIL (US 41)  
S. TAMiami TRAIL (US 41)


C:\Users\hart8975\AppData\Local\Temp\AcPublish\_10788\11\_Plans and Profiles.dwg Mar 14, 2018 - 12:16pm

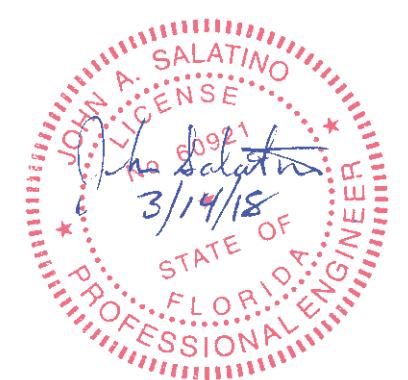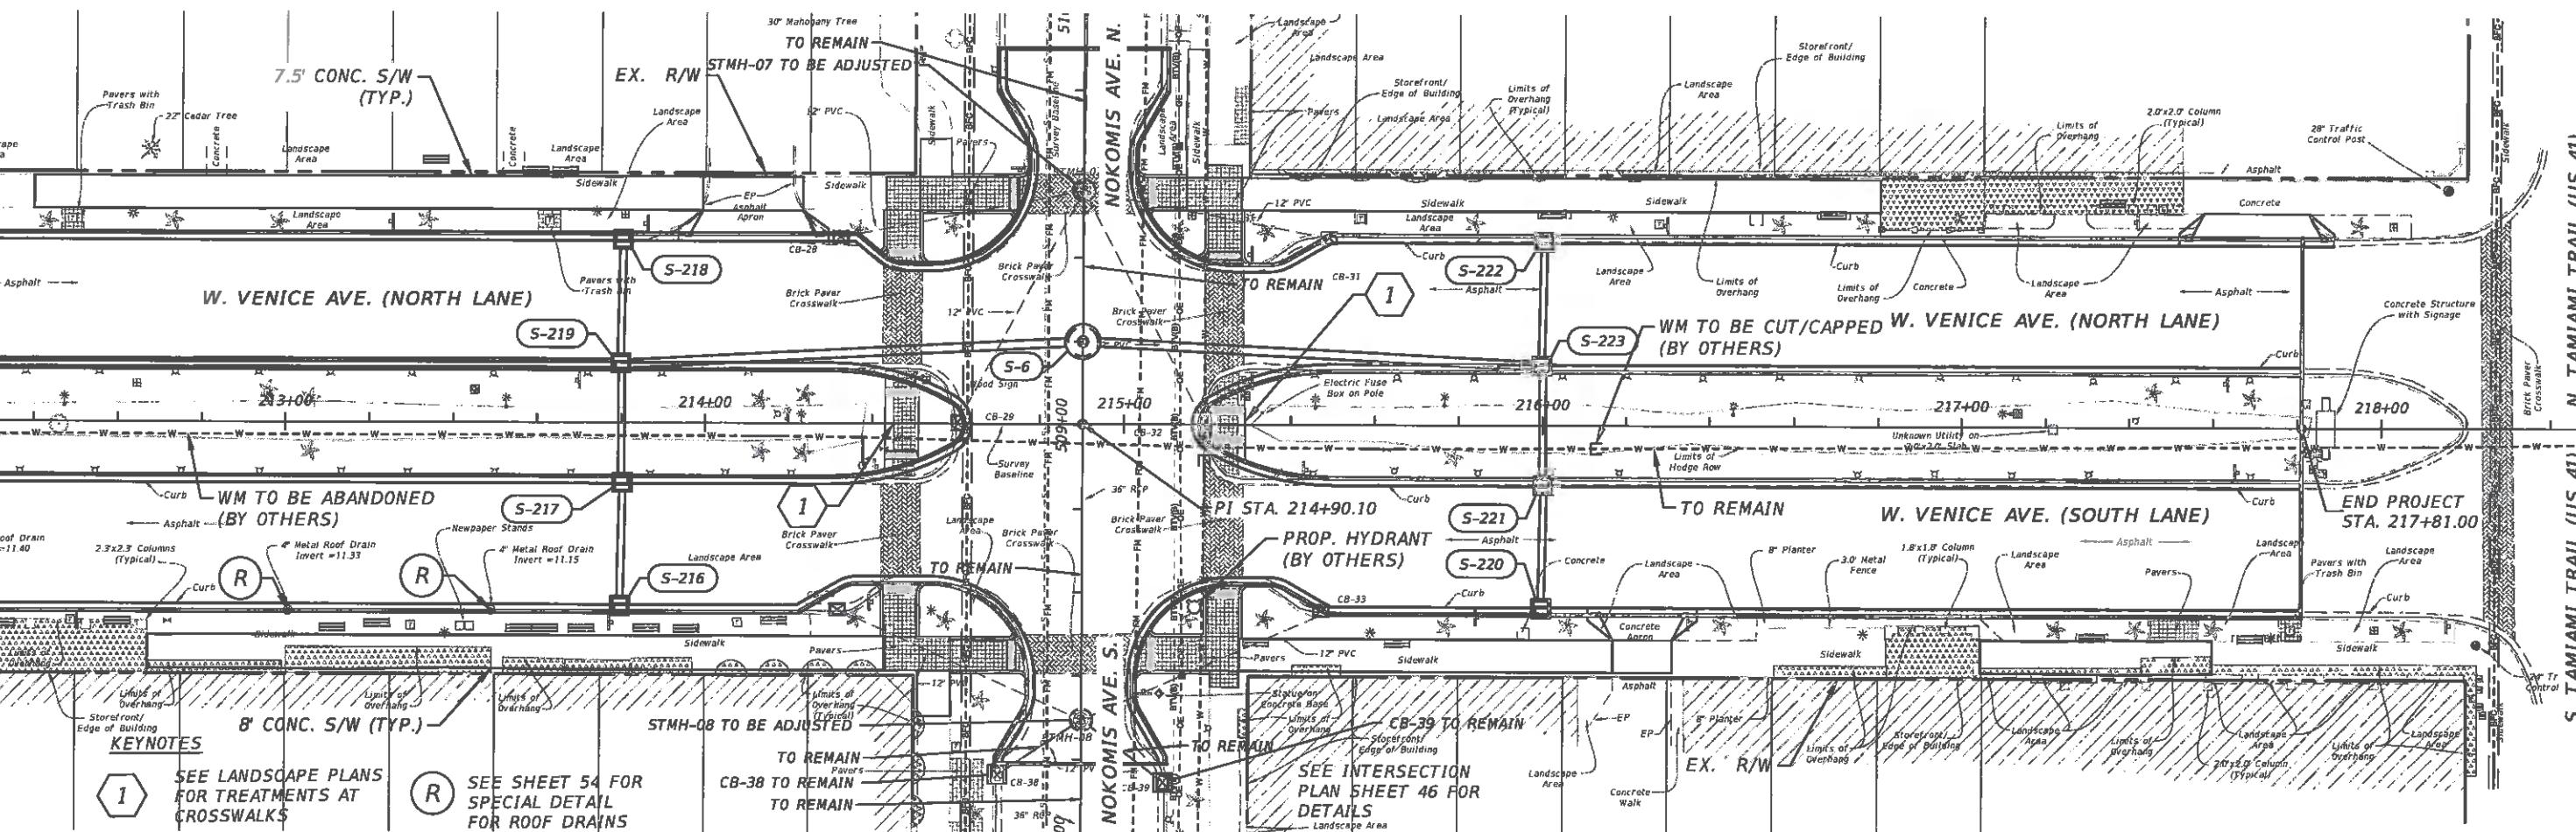

PREPARED FOR:	PREPARED BY:	PROJECT:	DESCRIPTION:	APPROVED BY:	DATE:
DESIGNED MLM		ATKINS	CITY OF VENICE DOWNTOWN ROADWAY CORRIDOR IMPROVEMENTS	VENICE AVE. PLAN STA.212+40 TO STA.218+40	3/14/2018
DRAWN MA				JOHN SALATINO, P.E.	DATE
CHECKED MLM				P.E. LICENSE NUMBER 60921	PROJECT NO.: 100054389


## VENICE AVE. (NORTH SIDE)

HOR.: 0 20' 40'  
VER.: 0 2' 4'  
SCALE : FEET


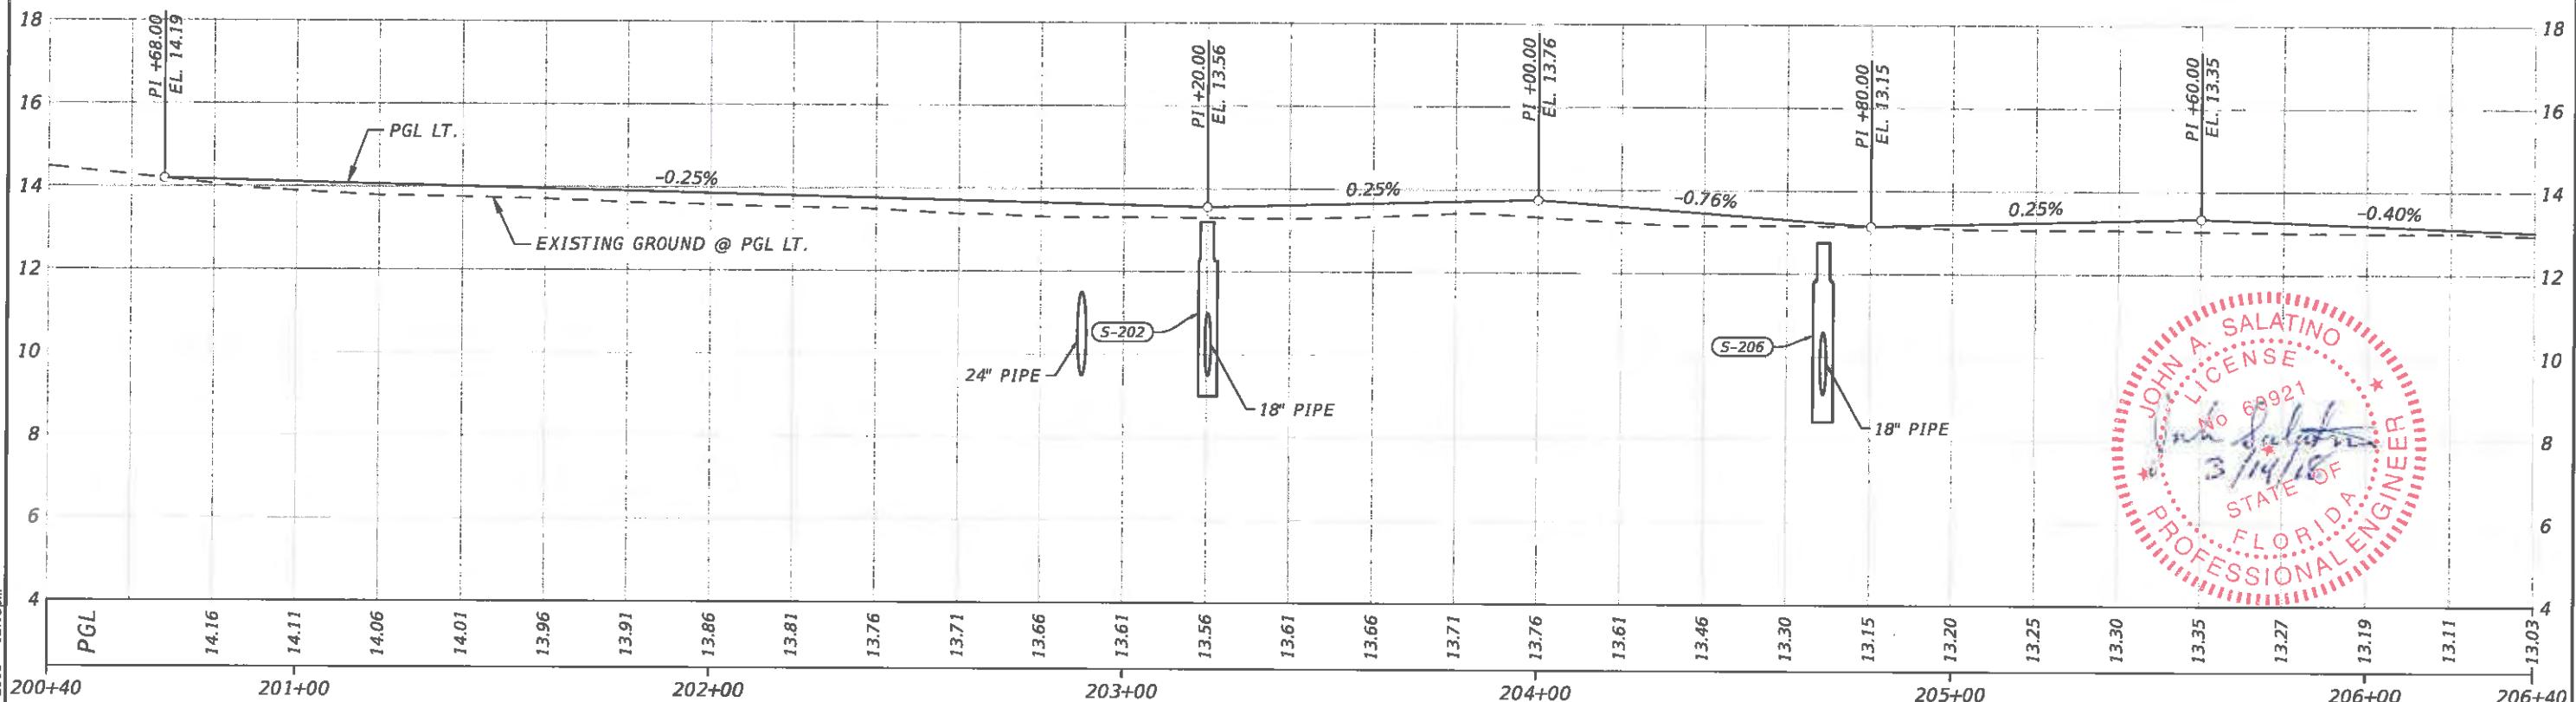


## VENICE AVE. (SOUTH SIDE)

HOR.: 0 20' 40'  
VER.: 0 2' 4'  
SCALE : FEET


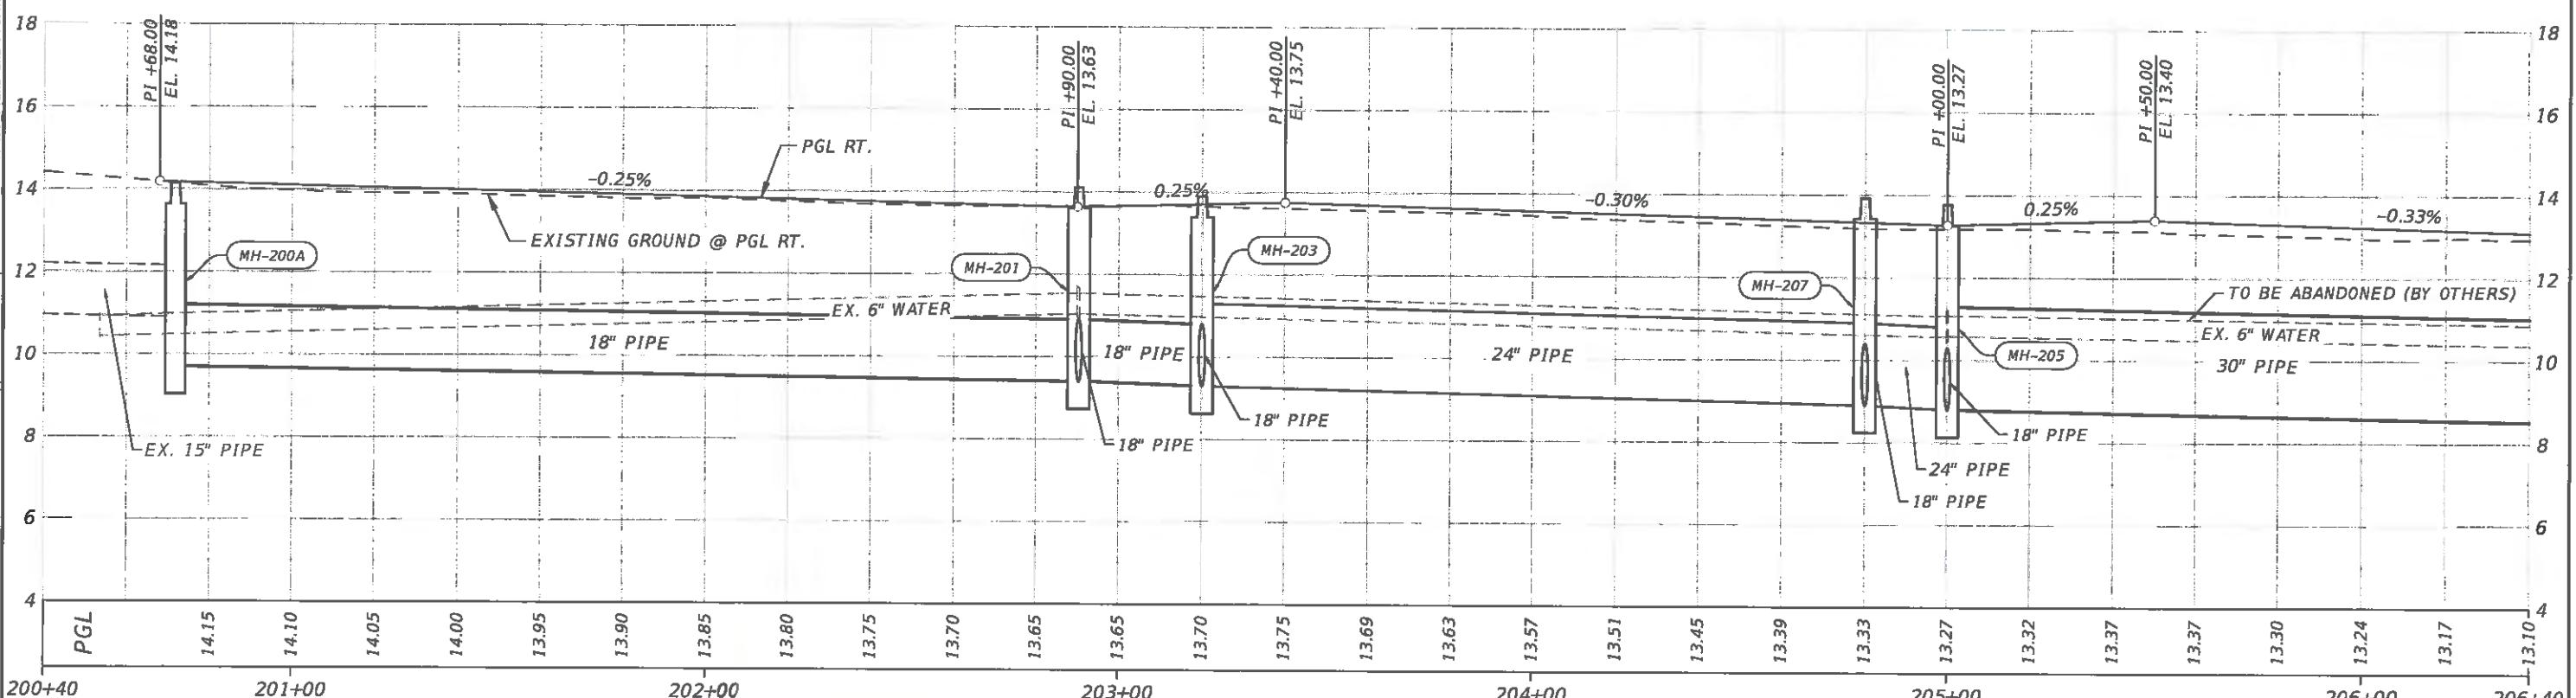


		PREPARED FOR:	PREPARED BY:	PROJECT:	DESCRIPTION:	APPROVED BY:	DATE:
		DESIGNED MLM					
		DRAWN MA					
		CHECKED MLM					
		Venice, FL City on the Gulf	ATKINS	CITY OF VENICE DOWNTOWN ROADWAY CORRIDOR IMPROVEMENTS	VENICE AVE. PROFILE STA.200+40 TO STA.206+40	JOHN SALATINO, P.E. P.E. LICENSE NUMBER 60921 ATKINS NORTH AMERICA (CERT. OF AUTH. NO. 24) 4030 WEST BOY SCOUT BOULEVARD, SUITE 700 TAMPA, FL 33607-1712	3/14/2018
Page 92	of 1140					PROJECT NO.:	100054389
REV. NO.	DATE	DESCRIPTION				SHEET:	32

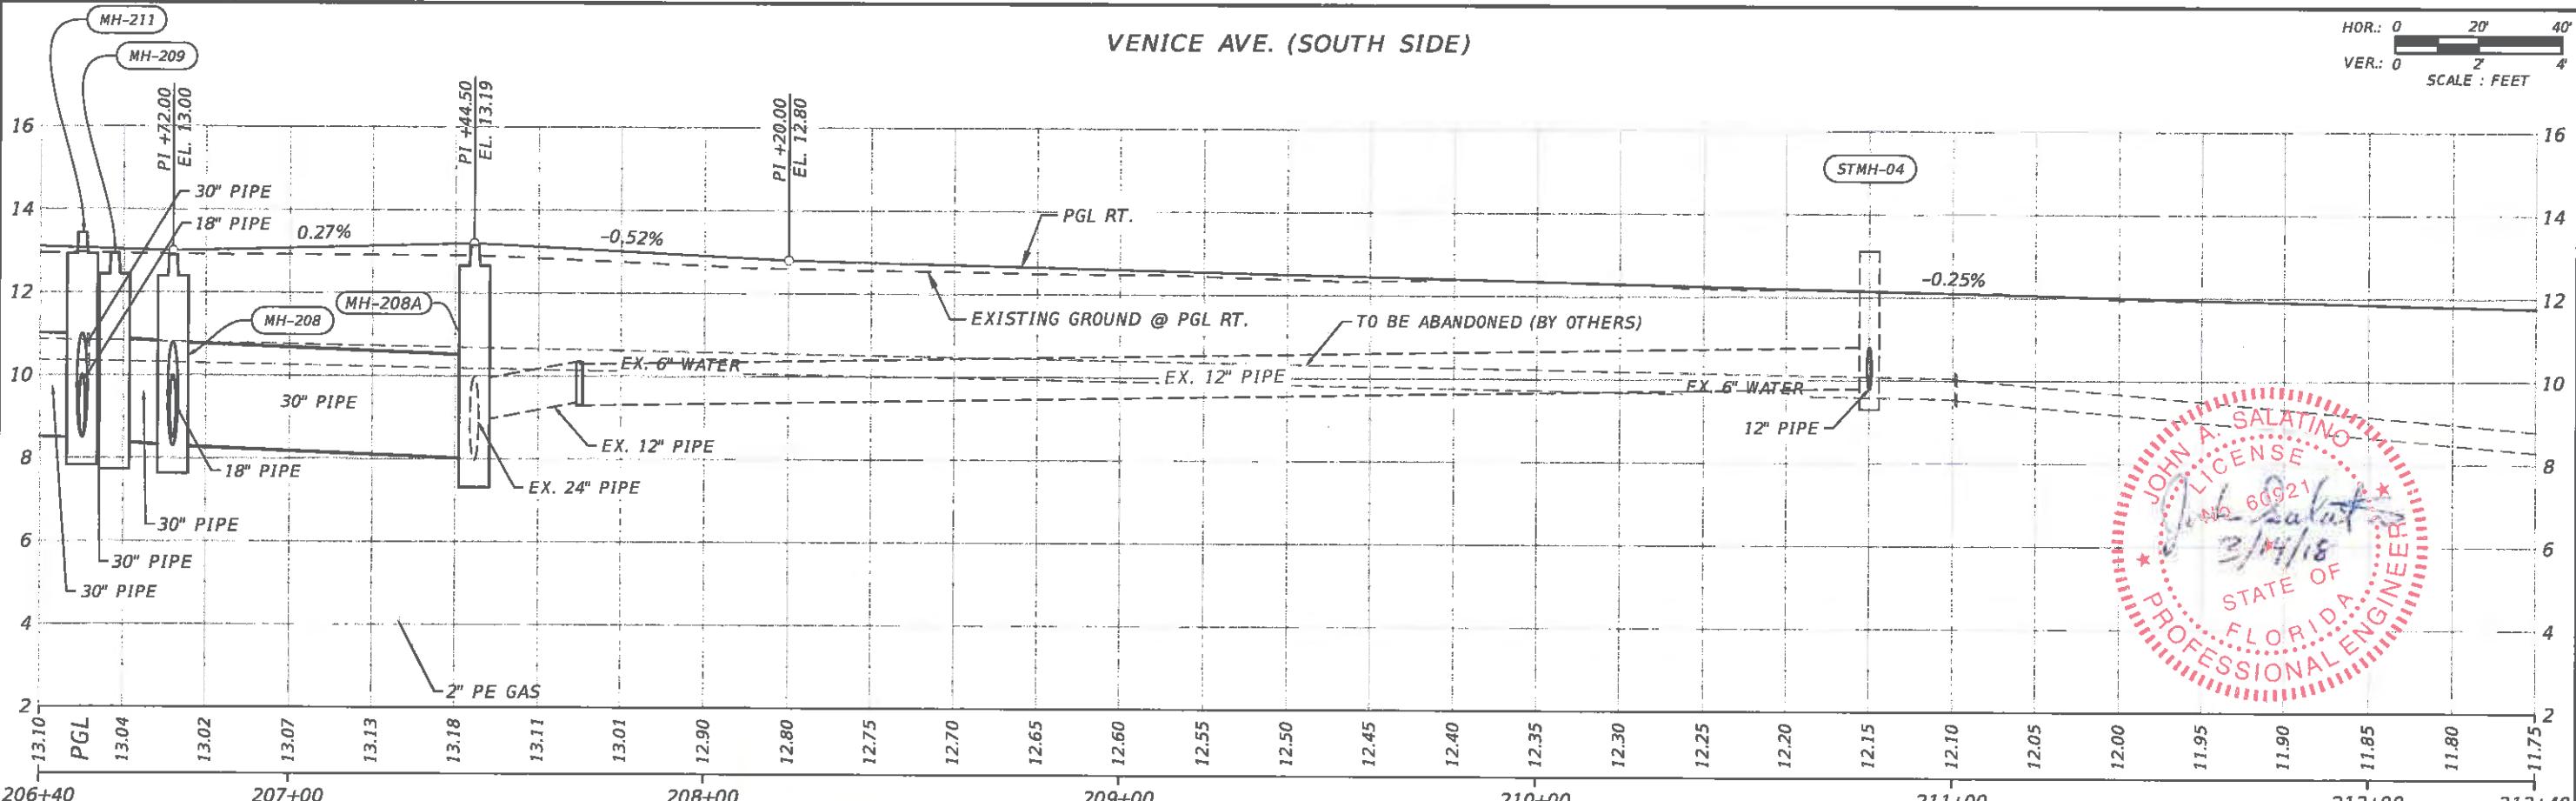
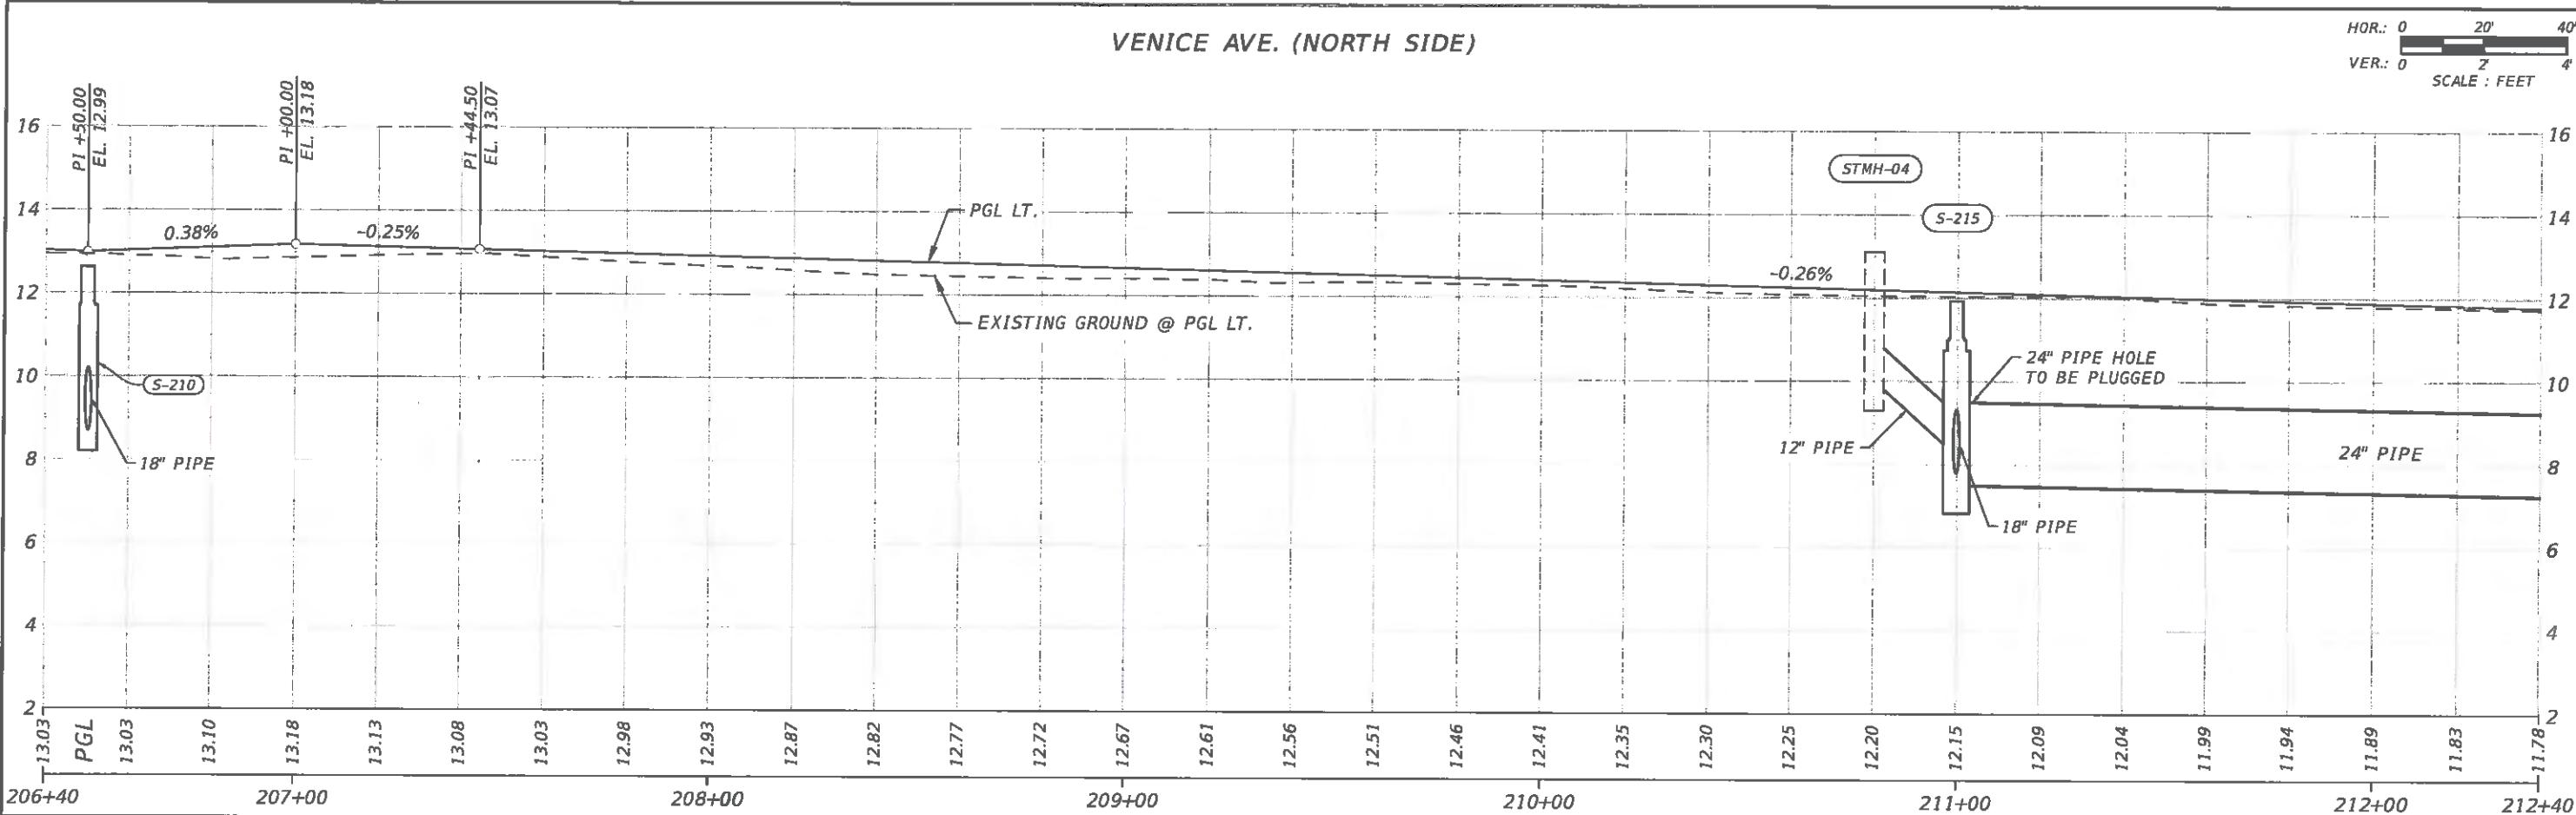


			PREPARED FOR:	PREPARED BY:	PROJECT:	DESCRIPTION:	APPROVED BY:	DATE:
			DESIGNED MLM		CITY OF VENICE DOWNTOWN ROADWAY CORRIDOR IMPROVEMENTS	VENICE AVE. PROFILE STA.206+40 TO STA.212+40	JOHN SALATINO, P.E. P.E. LICENSE NUMBER 60921 ATKINS NORTH AMERICA (CERT. OF AUTH. NO. 24) 4030 WEST BOY SCOUT BOULEVARD, SUITE 700 TAMPA, FL 33607-1712	3/14/2018
			DRAWN MA					PROJECT NO.: 100054389
			CHECKED MLM					SHEET: 33

Page 922 of 1140  
REV. NO. DATE DESCRIPTION

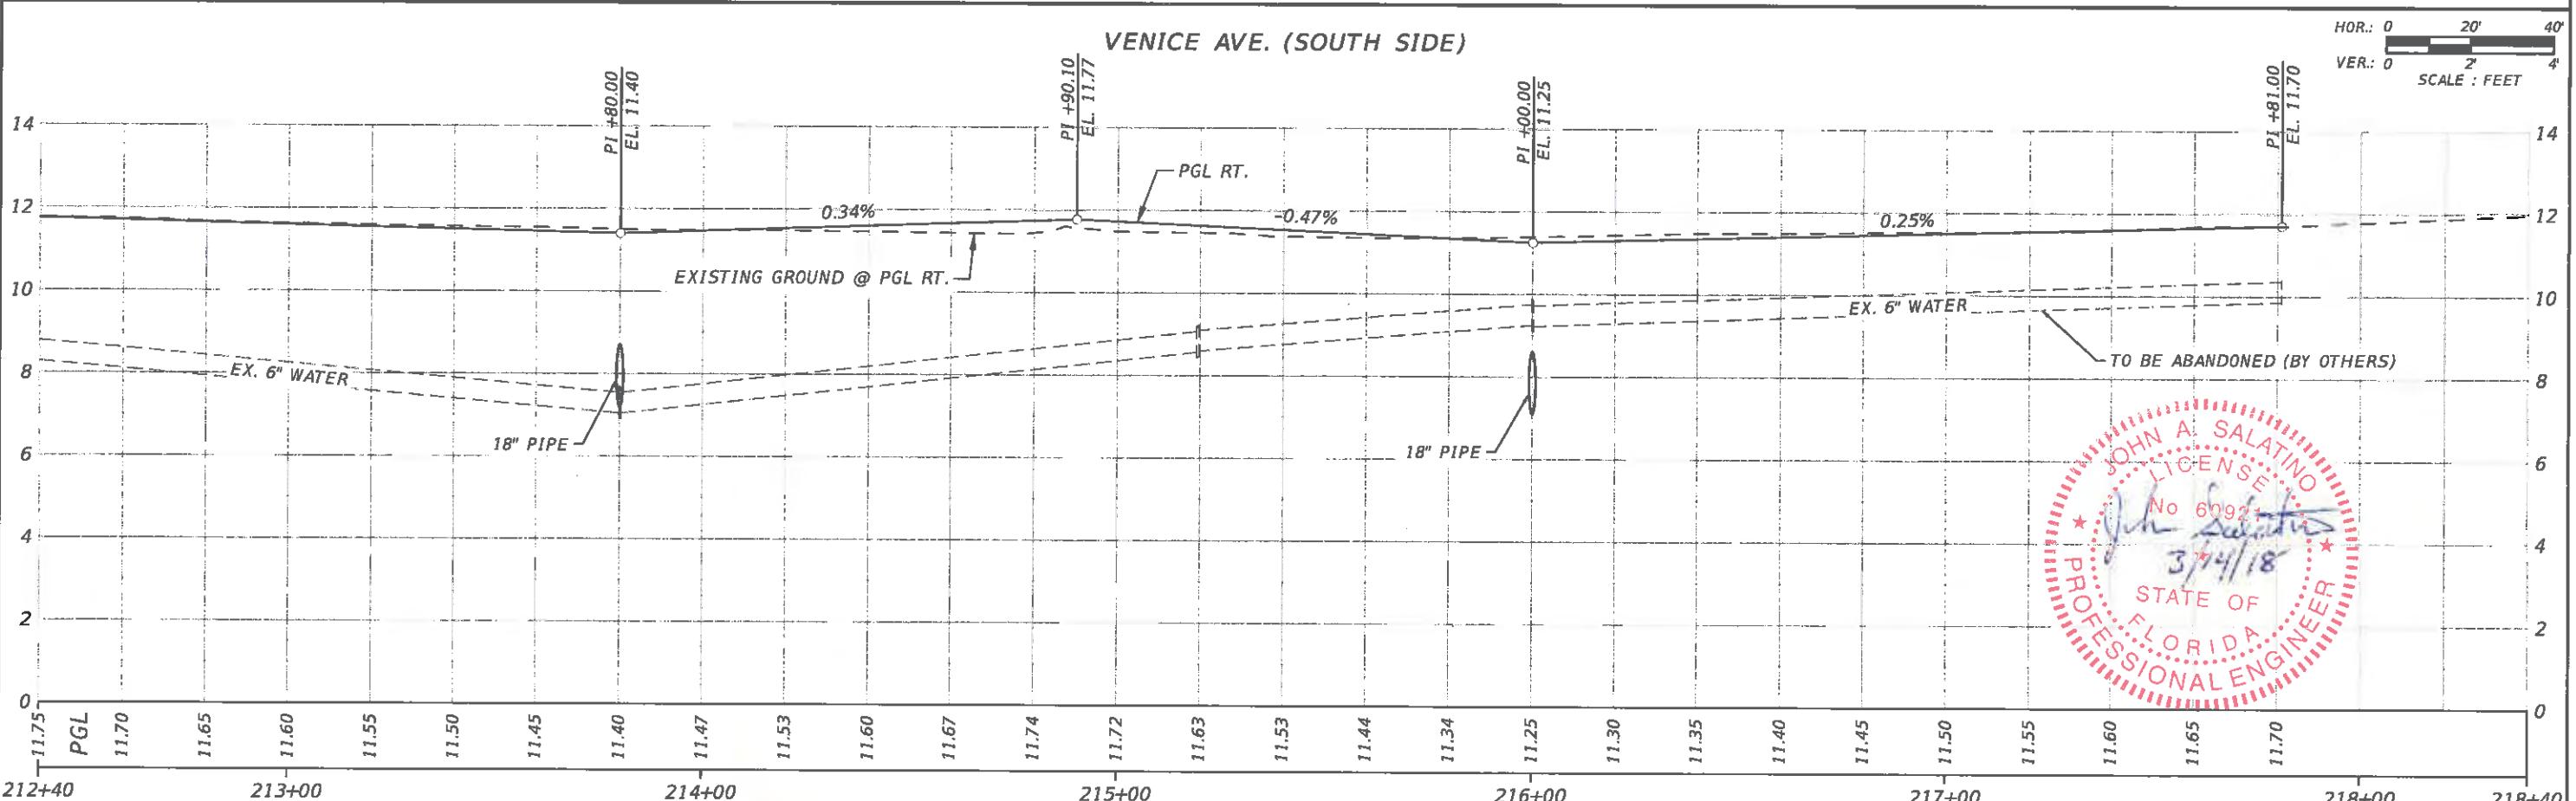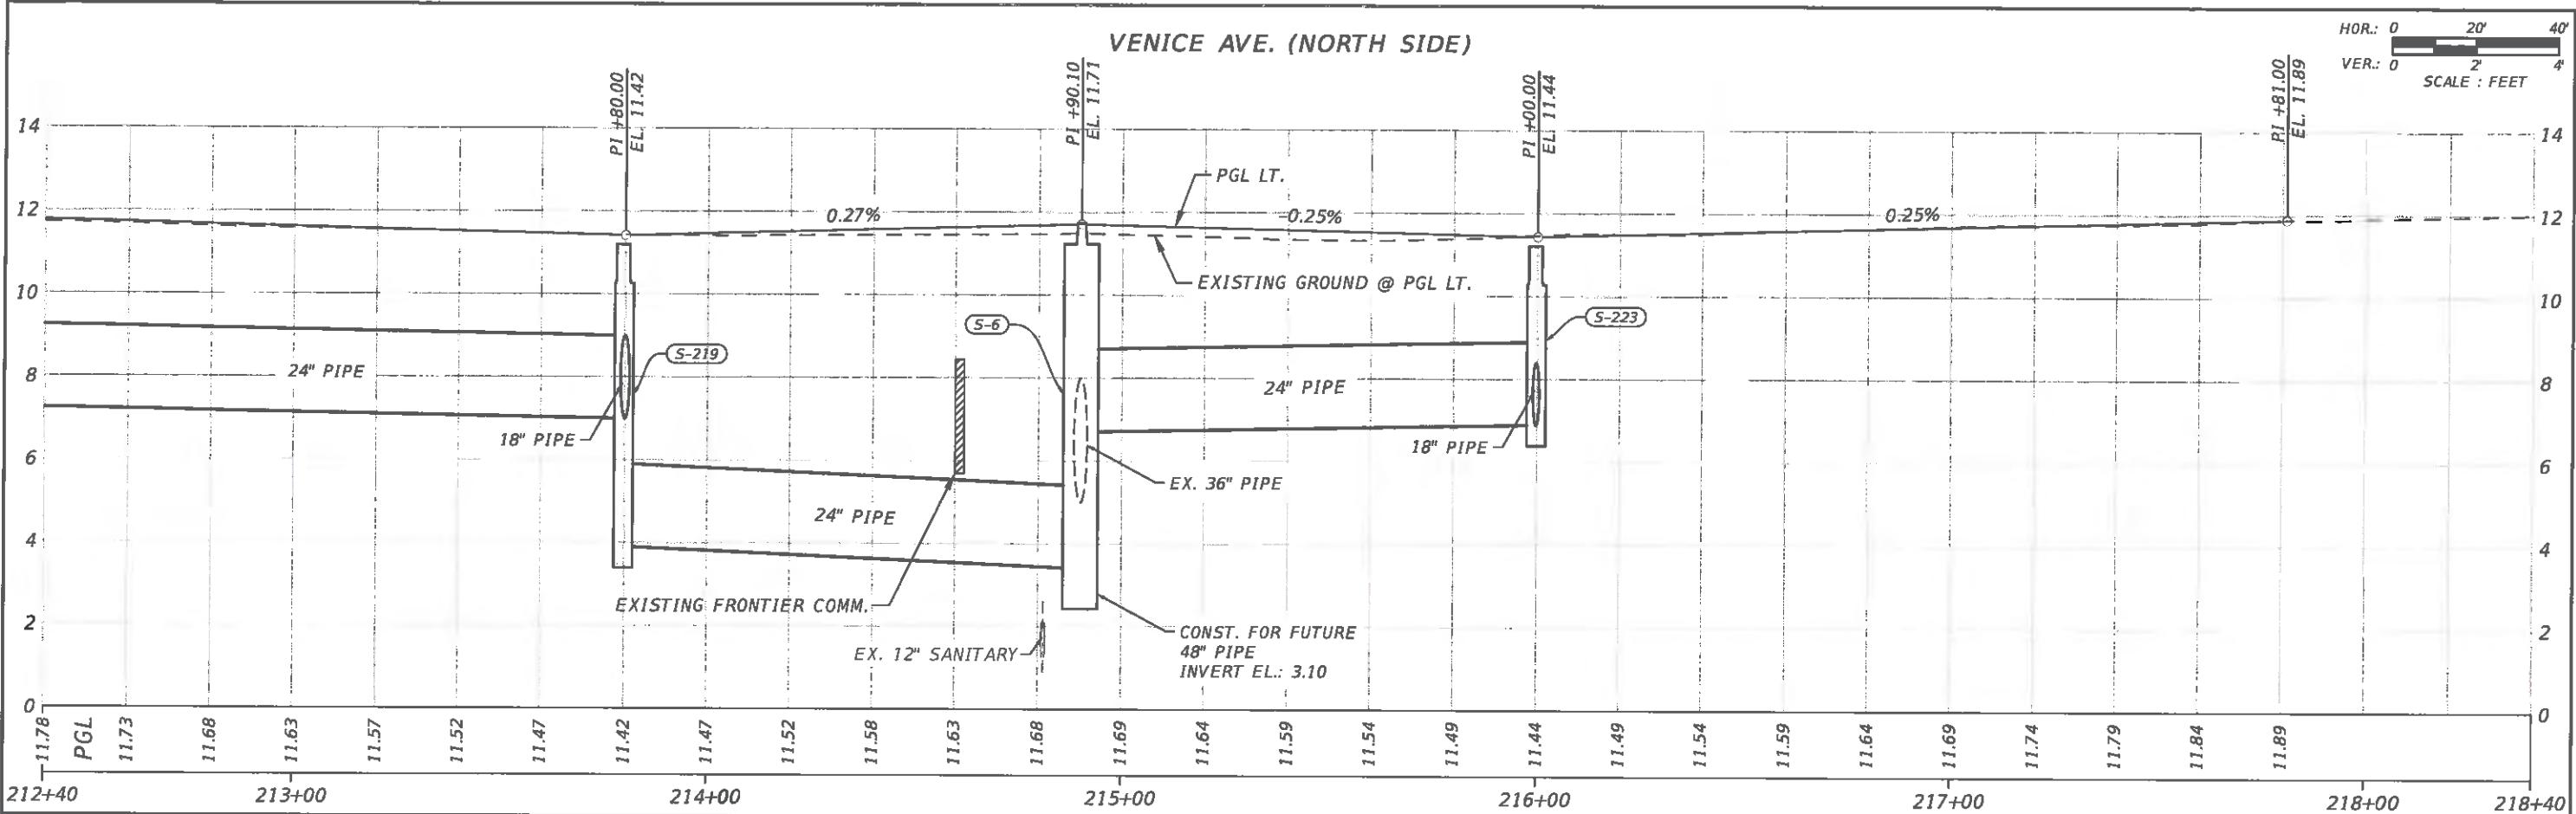


			PREPARED FOR:	PREPARED BY:	PROJECT:	DESCRIPTION:	APPROVED BY:	DATE:
			DESIGNED MLM	DRAWN MA	CITY OF VENICE DOWNTOWN ROADWAY CORRIDOR IMPROVEMENTS	VENICE AVE. PROFILE STA.212+40 TO STA.218+40	JOHN SALATINO, P.E. P.E. LICENSE NUMBER 60921 ATKINS NORTH AMERICA (CERT. OF AUTH. NO. 24) 4030 WEST BOY SCOUT BOULEVARD, SUITE 700 TAMPA, FL 33607-1712	3/14/2018
Page 923 of 1140			DRAWN MA	ATKINS				PROJECT NO.: 100054389
REV. NO.	DATE	DESCRIPTION	CHECKED MLM					SHEET: 34

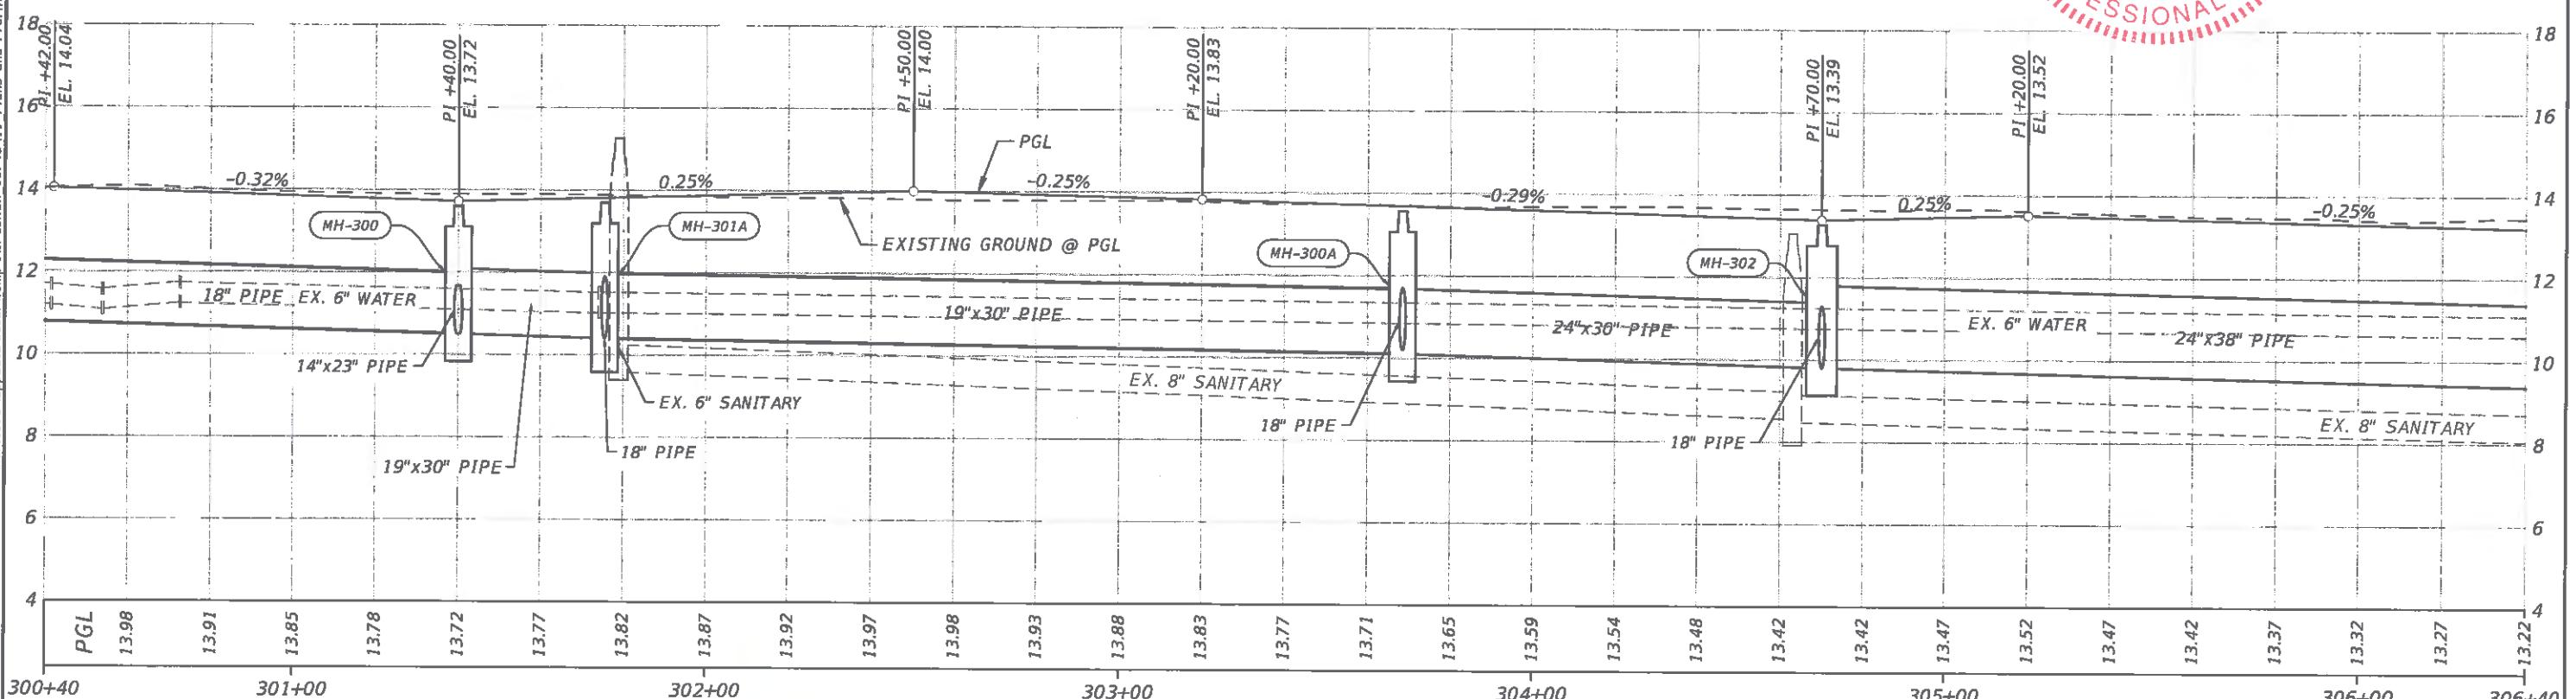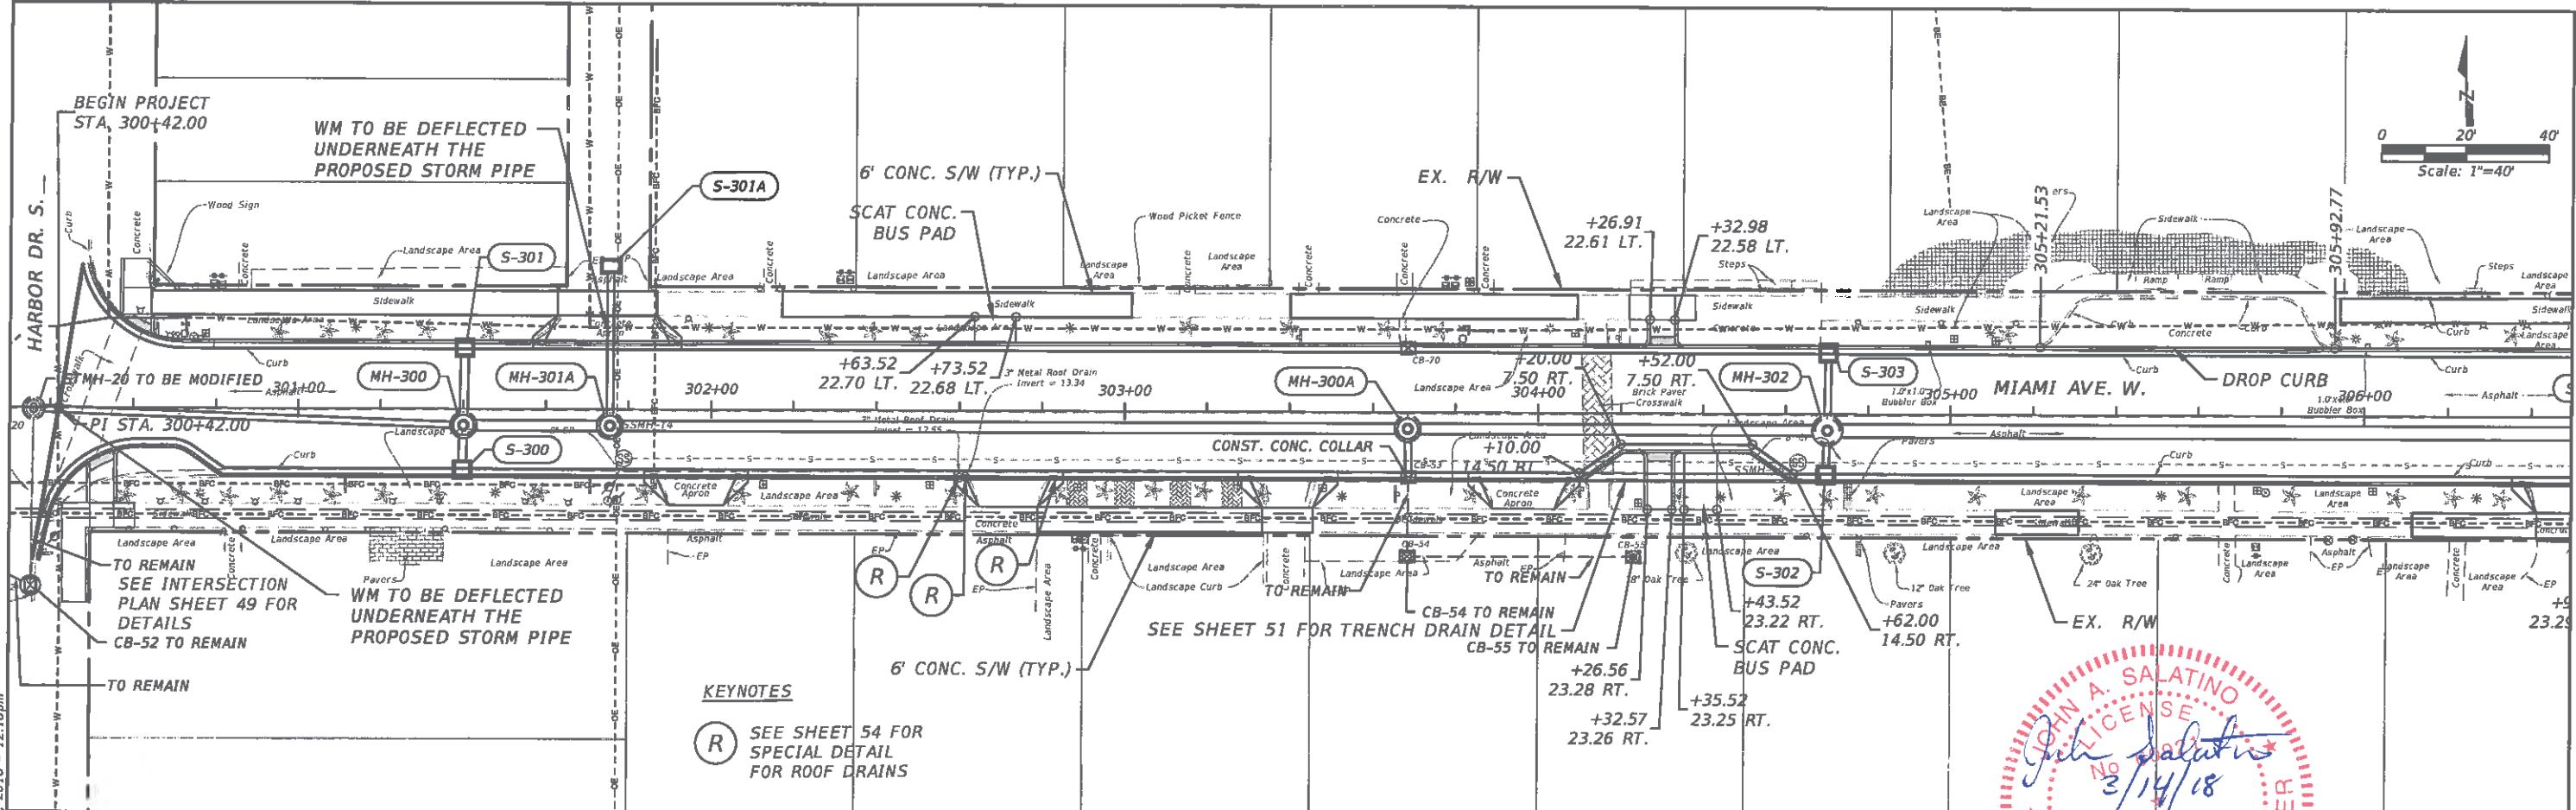


			PREPARED FOR:	PREPARED BY:	PROJECT:	DESCRIPTION:	APPROVED BY:	DATE:
			DESIGNED MLM	DRAWN MA	CITY OF VENICE DOWNTOWN ROADWAY CORRIDOR IMPROVEMENTS	MIAMI AVE. PLAN-PROFILE STA.300+40 TO STA.306+40	JOHN SALATINO, P.E. P.E. LICENSE NUMBER 60921 ATKINS NORTH AMERICA (CERT. OF AUTH. NO. 24) 4030 WEST BOY SCOUT BOULEVARD, SUITE 700 TAMPA, FL 33607-1712	3/14/2018
			DRAWN MLM	MA				PROJECT NO.: 100054389
			CHECKED MLM					SHEET: 35


Page 924 of 1140  
REV. NO. DATE DESCRIPTION

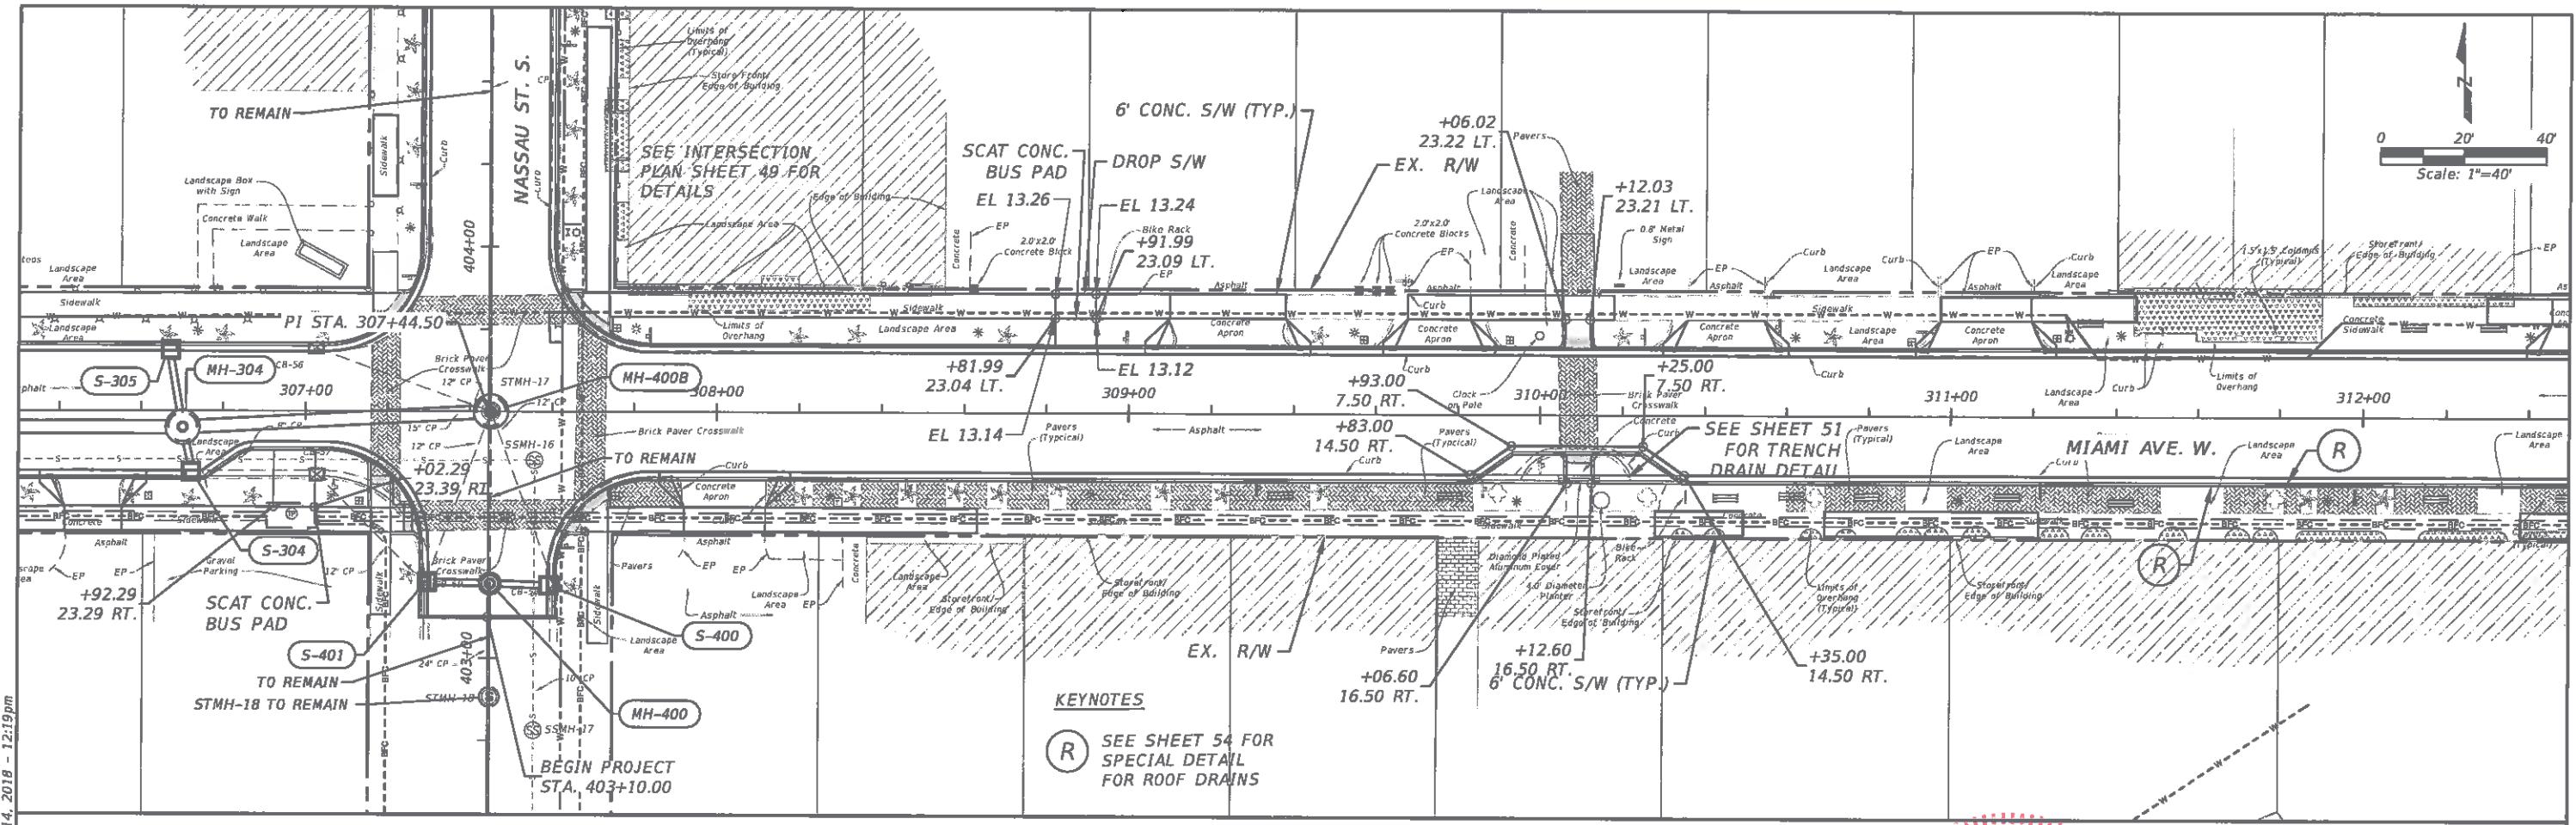


JOHN A. SALATINO  
No. 60921  
3/14/18  
STATE OF FLORIDA  
PROFESSIONAL ENGINEER

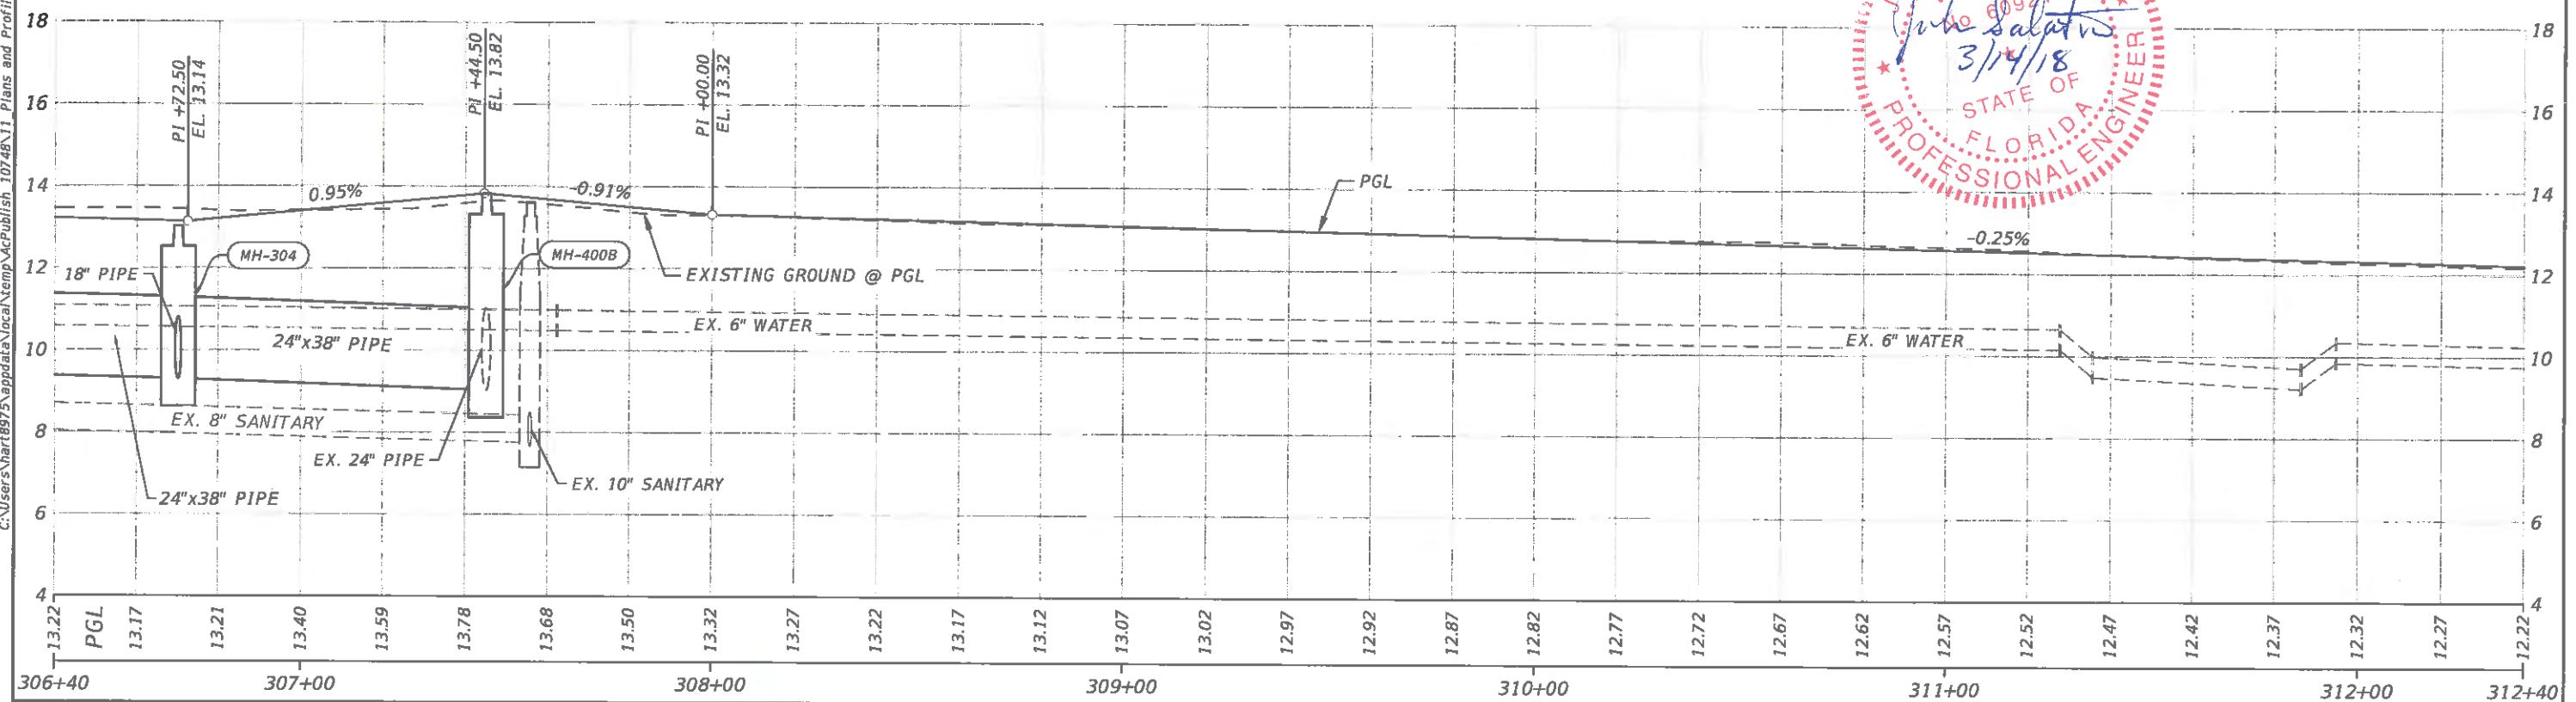



		PREPARED FOR:	PREPARED BY:	PROJECT:	DESCRIPTION:	APPROVED BY:	DATE:
		DESIGNED MLM		CITY OF VENICE	MIAMI AVE.	JOHN SALATINO, P.E.	3/14/2018
		DRAWN MA		DOWNTOWN ROADWAY	PLAN-PROFILE	P.E. LICENSE NUMBER 60921	DATE
		CHECKED MLM		CORRIDOR IMPROVEMENTS	STA.306+40 TO STA.312+40	ATKINS NORTH AMERICA (CERT. OF AUTH. NO. 24)	PROJECT NO.: 100054389
Page 925 of 1140	REV. NO.	DATE	DESCRIPTION			TAMPA, FL 33607-1712	SHEET: 36

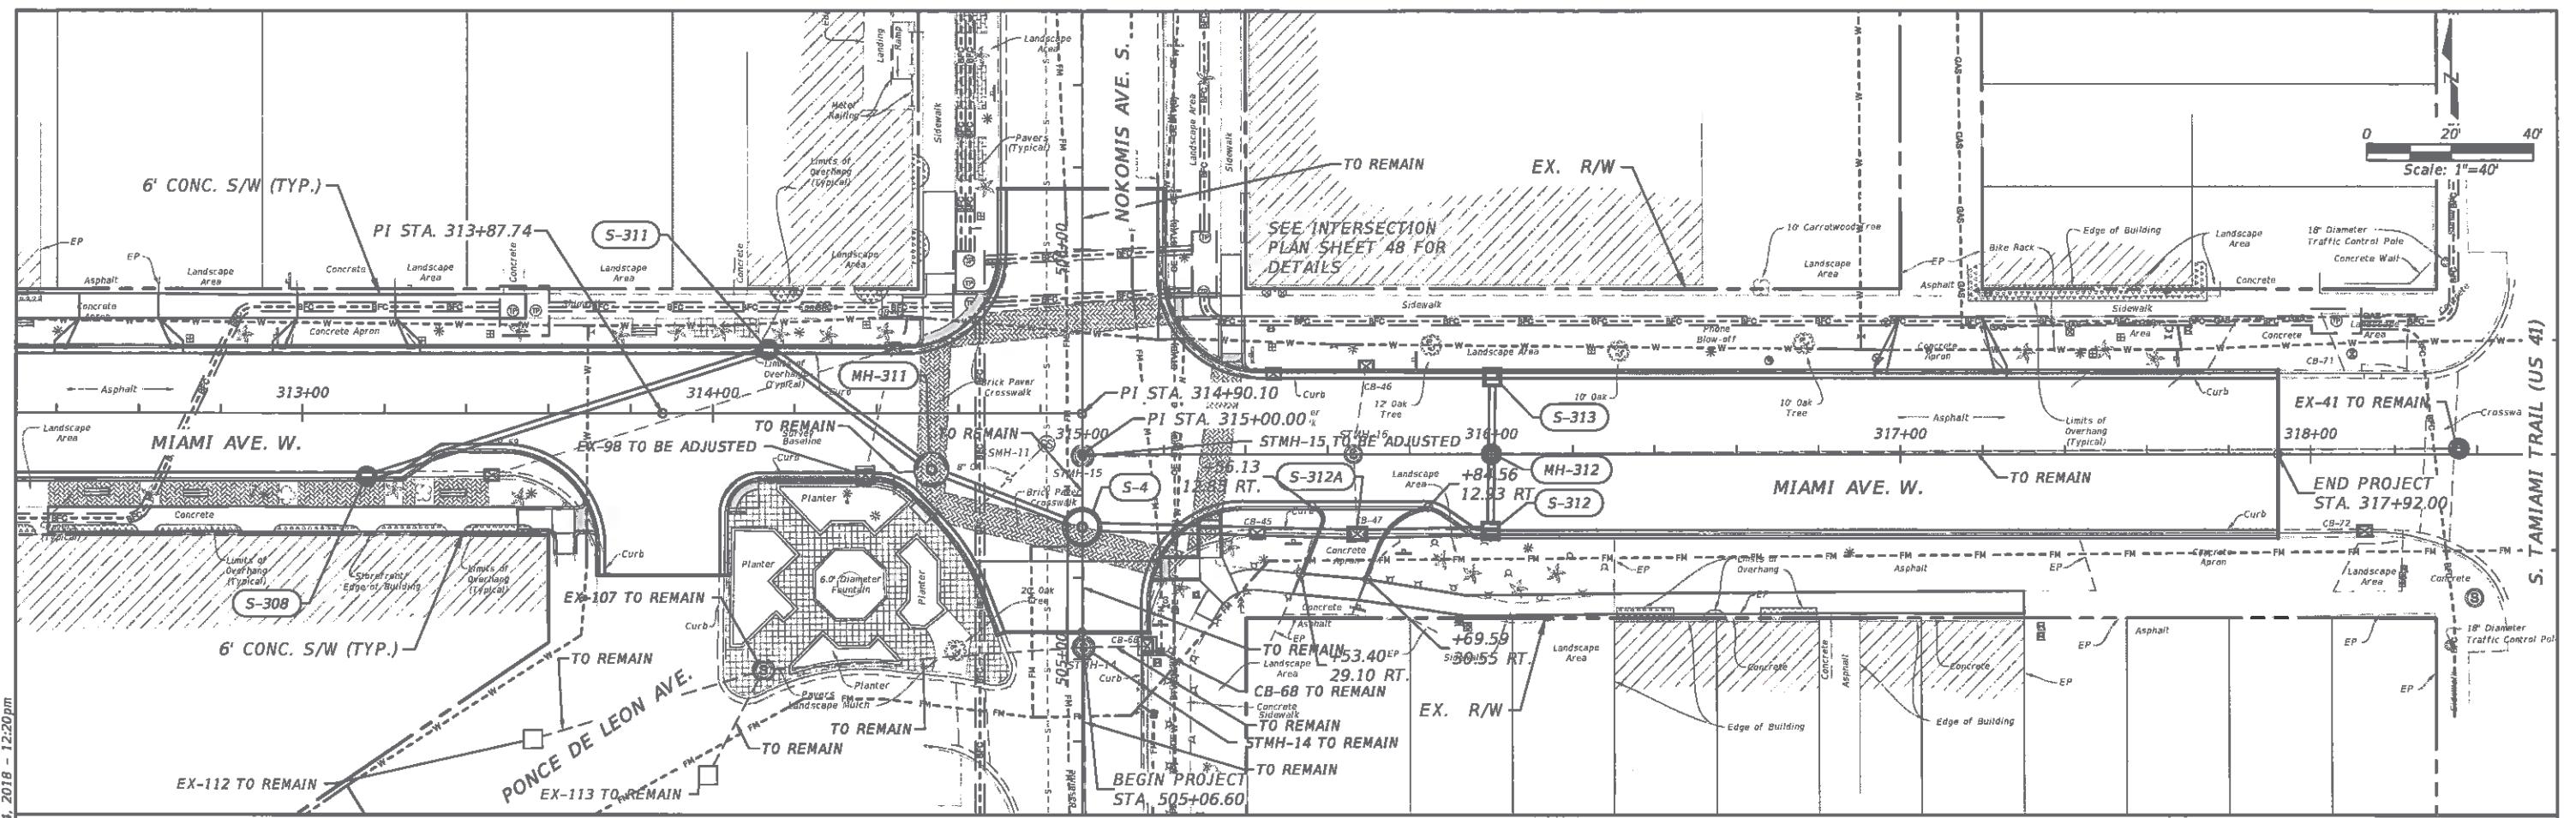


C:\Users\chart8975\appdata\localtemp\AcPublish 1074811\_Plans and Profiles.dwg, Mar 14, 2018 - 12:20pm

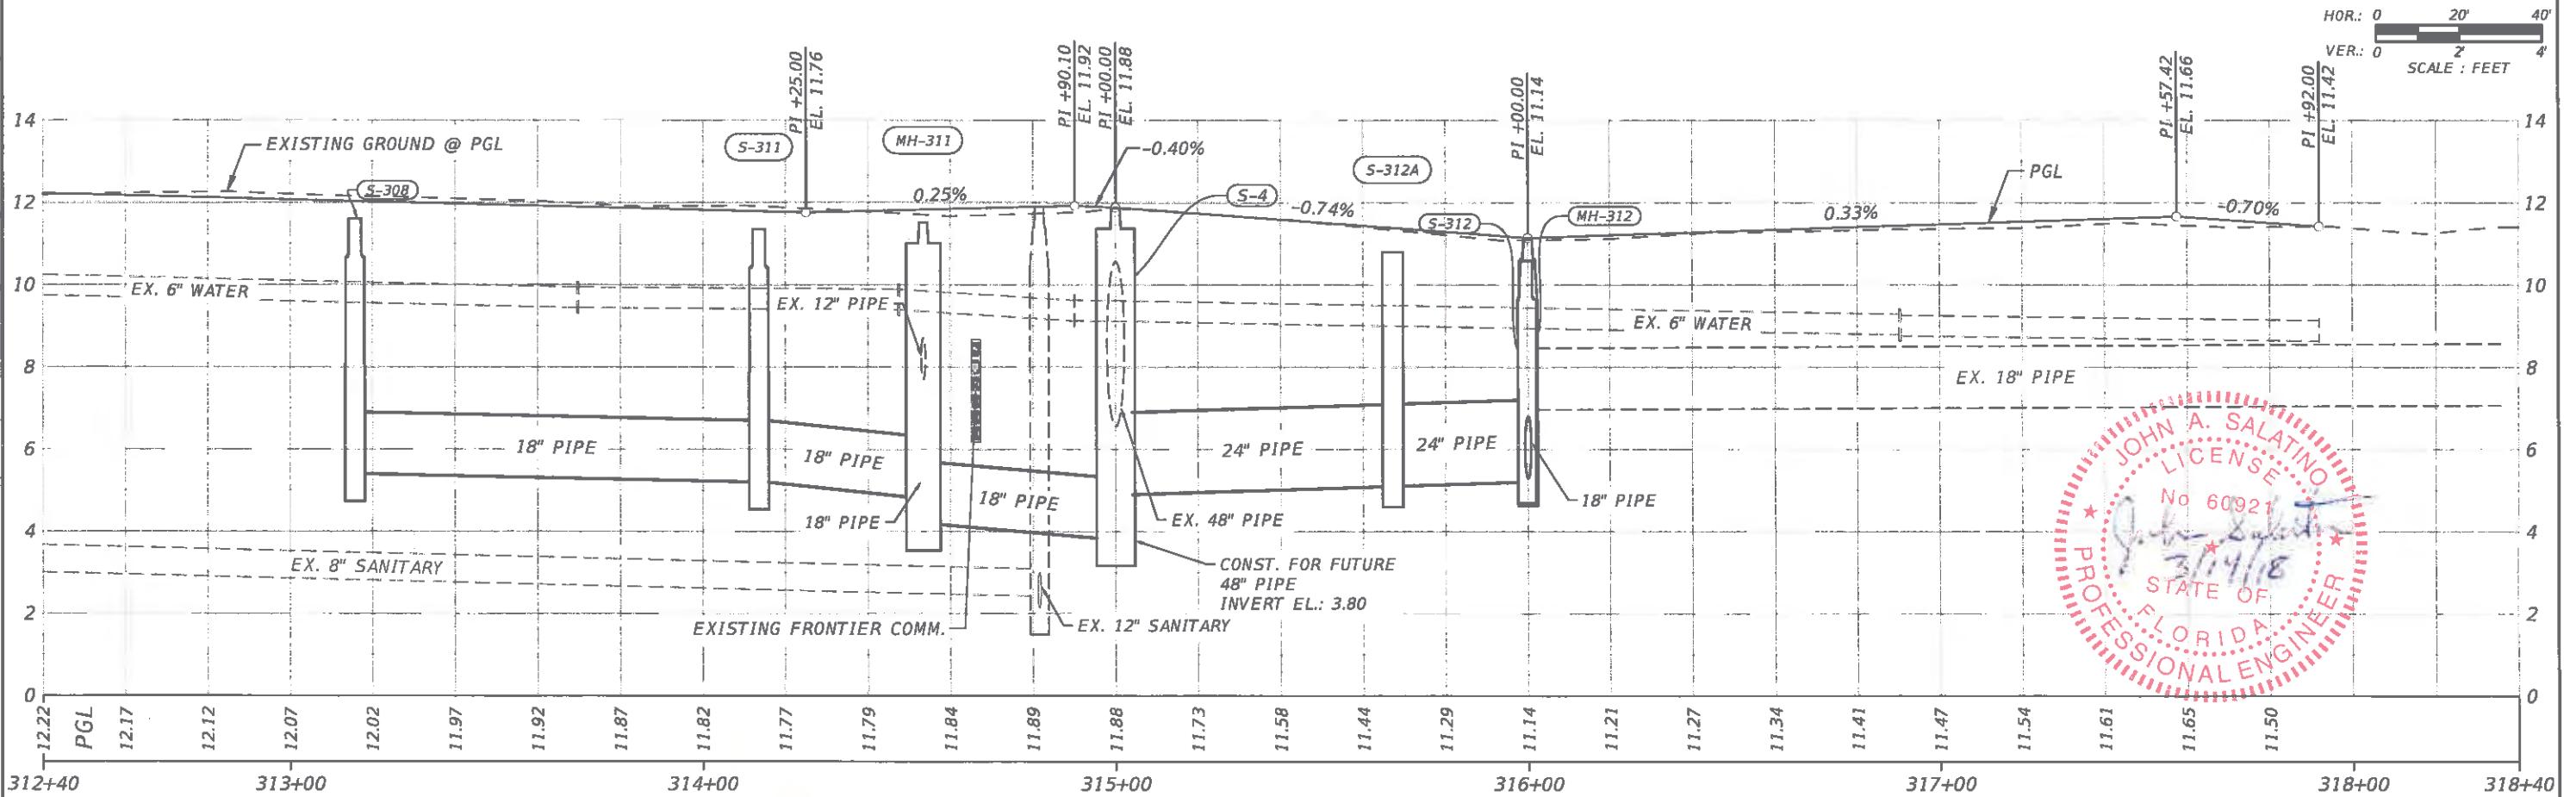


		PREPARED FOR:	PREPARED BY:	PROJECT:	DESCRIPTION:	APPROVED BY:	DATE:
DESIGNED	MLM	DRAWN	MA	ATKINS	CITY OF VENICE DOWNTOWN ROADWAY CORRIDOR IMPROVEMENTS	JOHN SALATINO, P.E. P.E. LICENSE NUMBER 60921 ATKINS NORTH AMERICA (CERT. OF AUTH. NO. 24) 4030 WEST BOY SCOUT BOULEVARD, SUITE 700 TAMPA, FL 33607-1712	3/14/2018
DRAINED	MA	CHECKED	MLM	Venice, FL City on the Gulf	MIAMI AVE. PLAN-PROFILE STA.312+40 TO STA.318+40		PROJECT NO.: 100054389
REV. NO.	DATE	DESCRIPTION					SHEET: 37

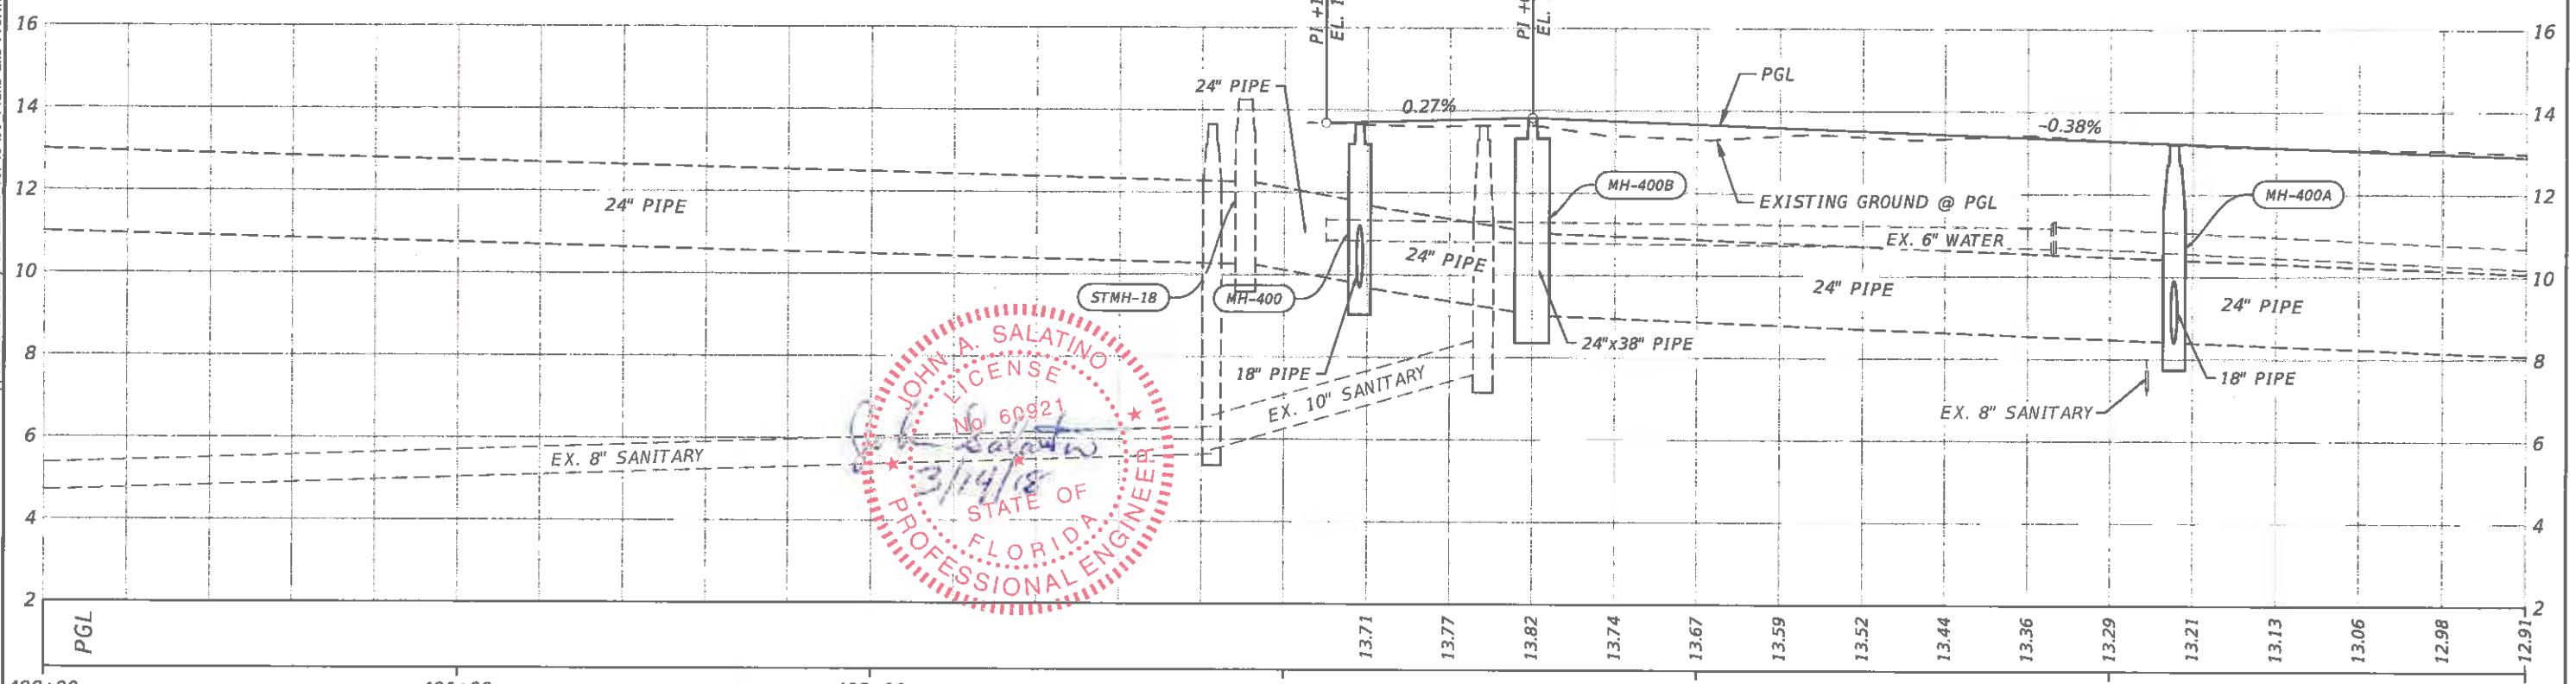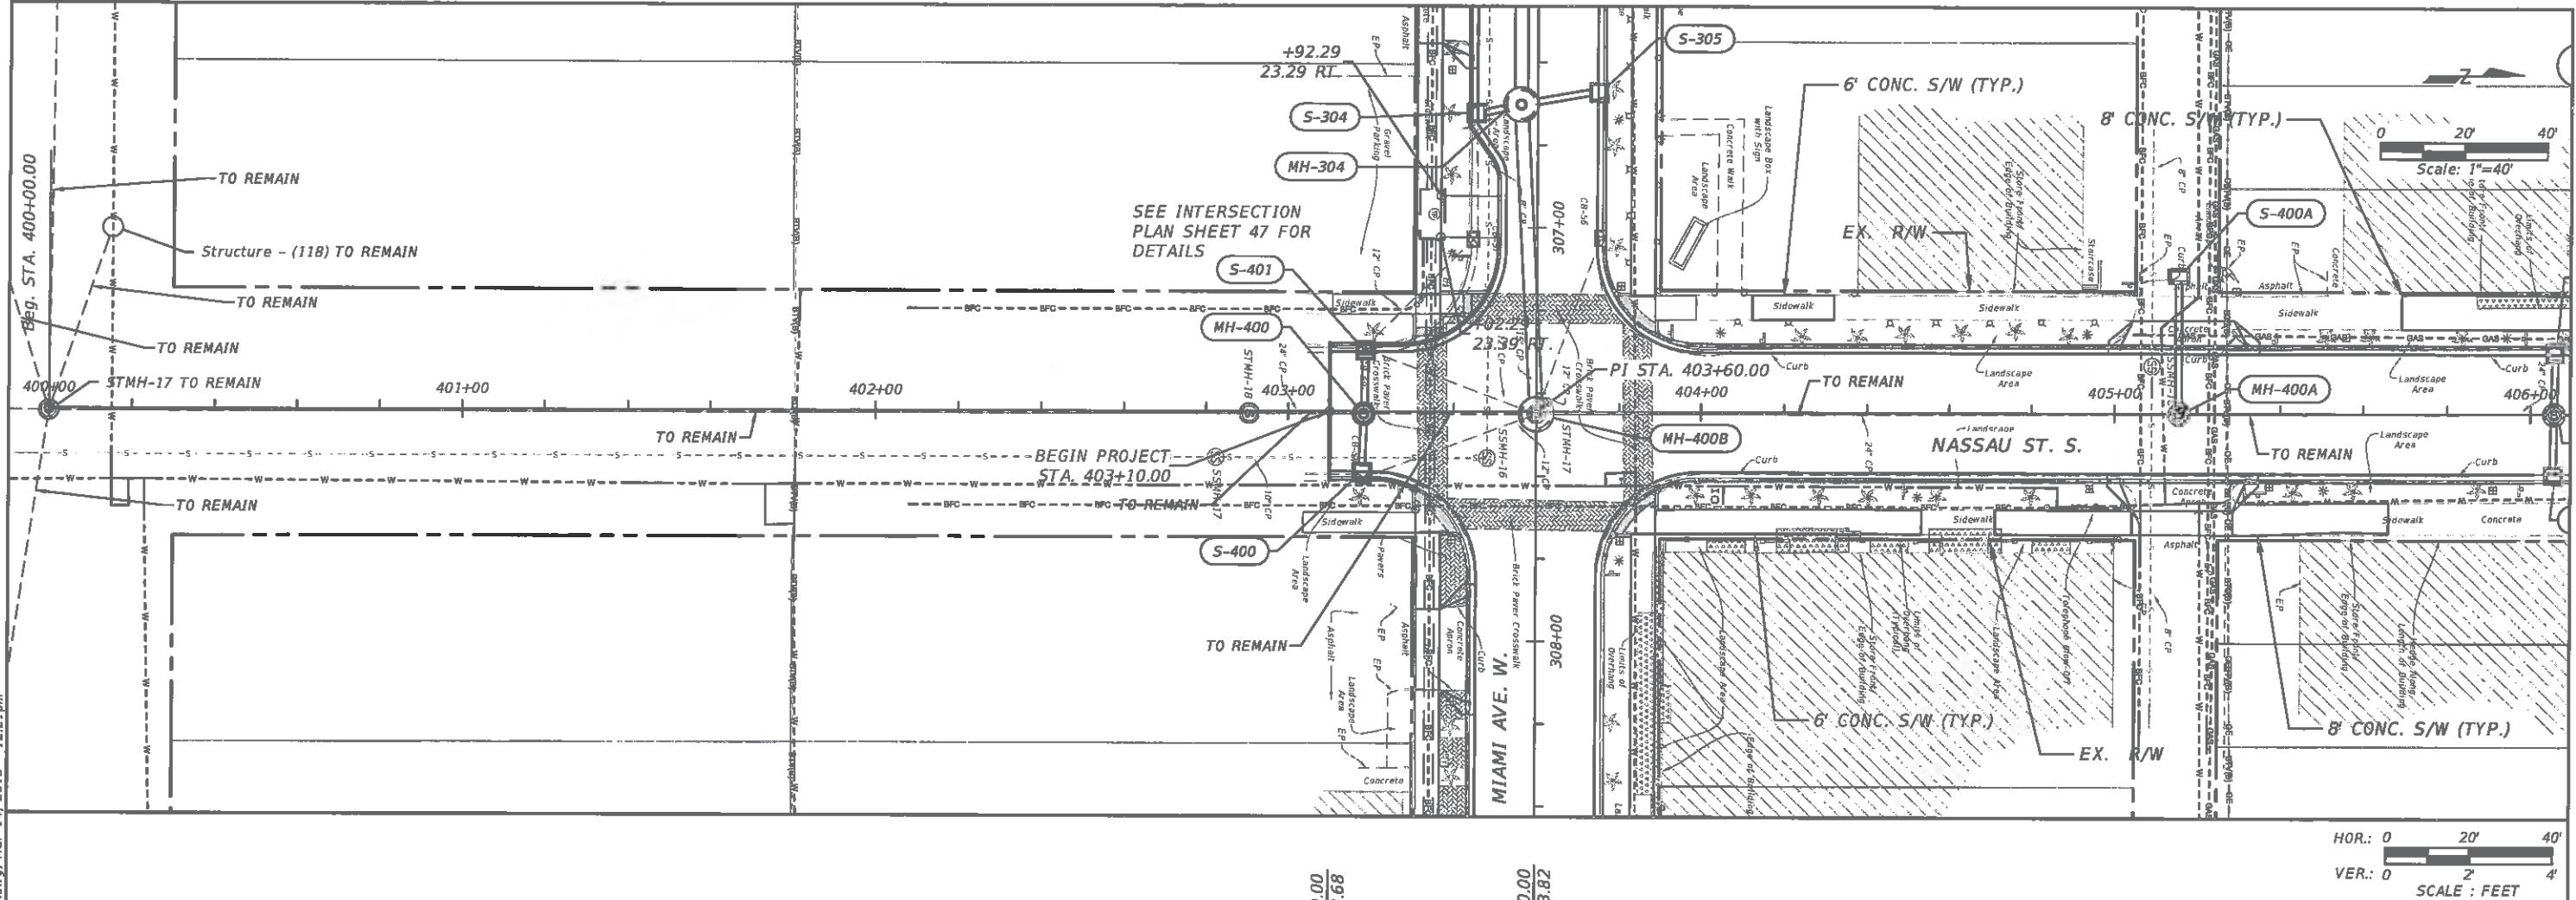

PREPARED FOR:	PREPARED BY:	PROJECT:	DESCRIPTION:	APPROVED BY:	DATE:	
DESIGNED MLM DRAWN MA CHECKED MLM	Venice, FL City on the Gulf	ATKINS	CITY OF VENICE DOWNTOWN ROADWAY CORRIDOR IMPROVEMENTS	NASSAU ST. PLAN-PROFILE STA.400+00 TO STA.406+00	JOHN SALATINO, P.E. P.E. LICENSE NUMBER 60921 ATKINS NORTH AMERICA (CERT. OF AUTH. NO. 24) 4030 WEST BOY SCOUT BOULEVARD, SUITE 700 TAMPA, FL 33607-1712	3/14/2018
Page 927 of 1140	REV. NO. DATE DESCRIPTION	PROJECT NO.: 100054389	SHEET: 38			

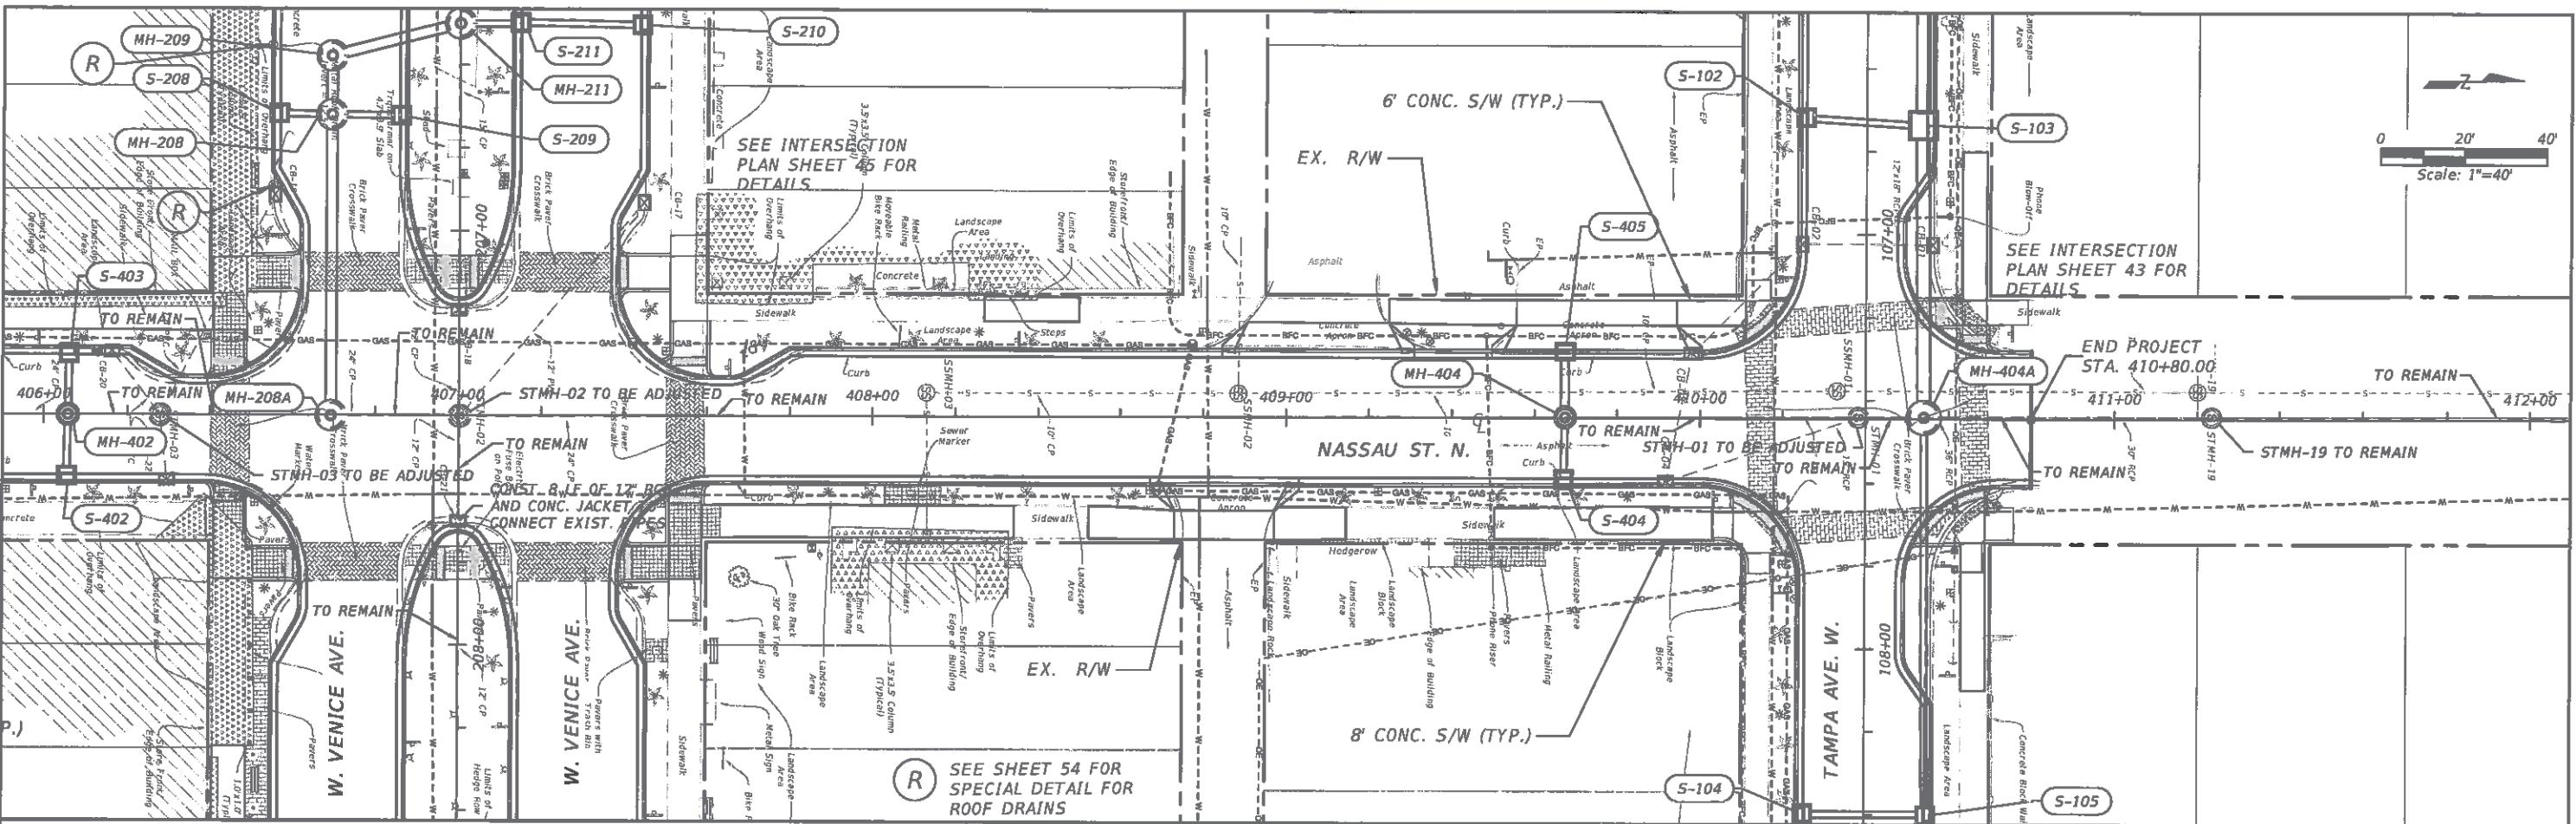



Scale: 1"=40'  
0 20' 40'


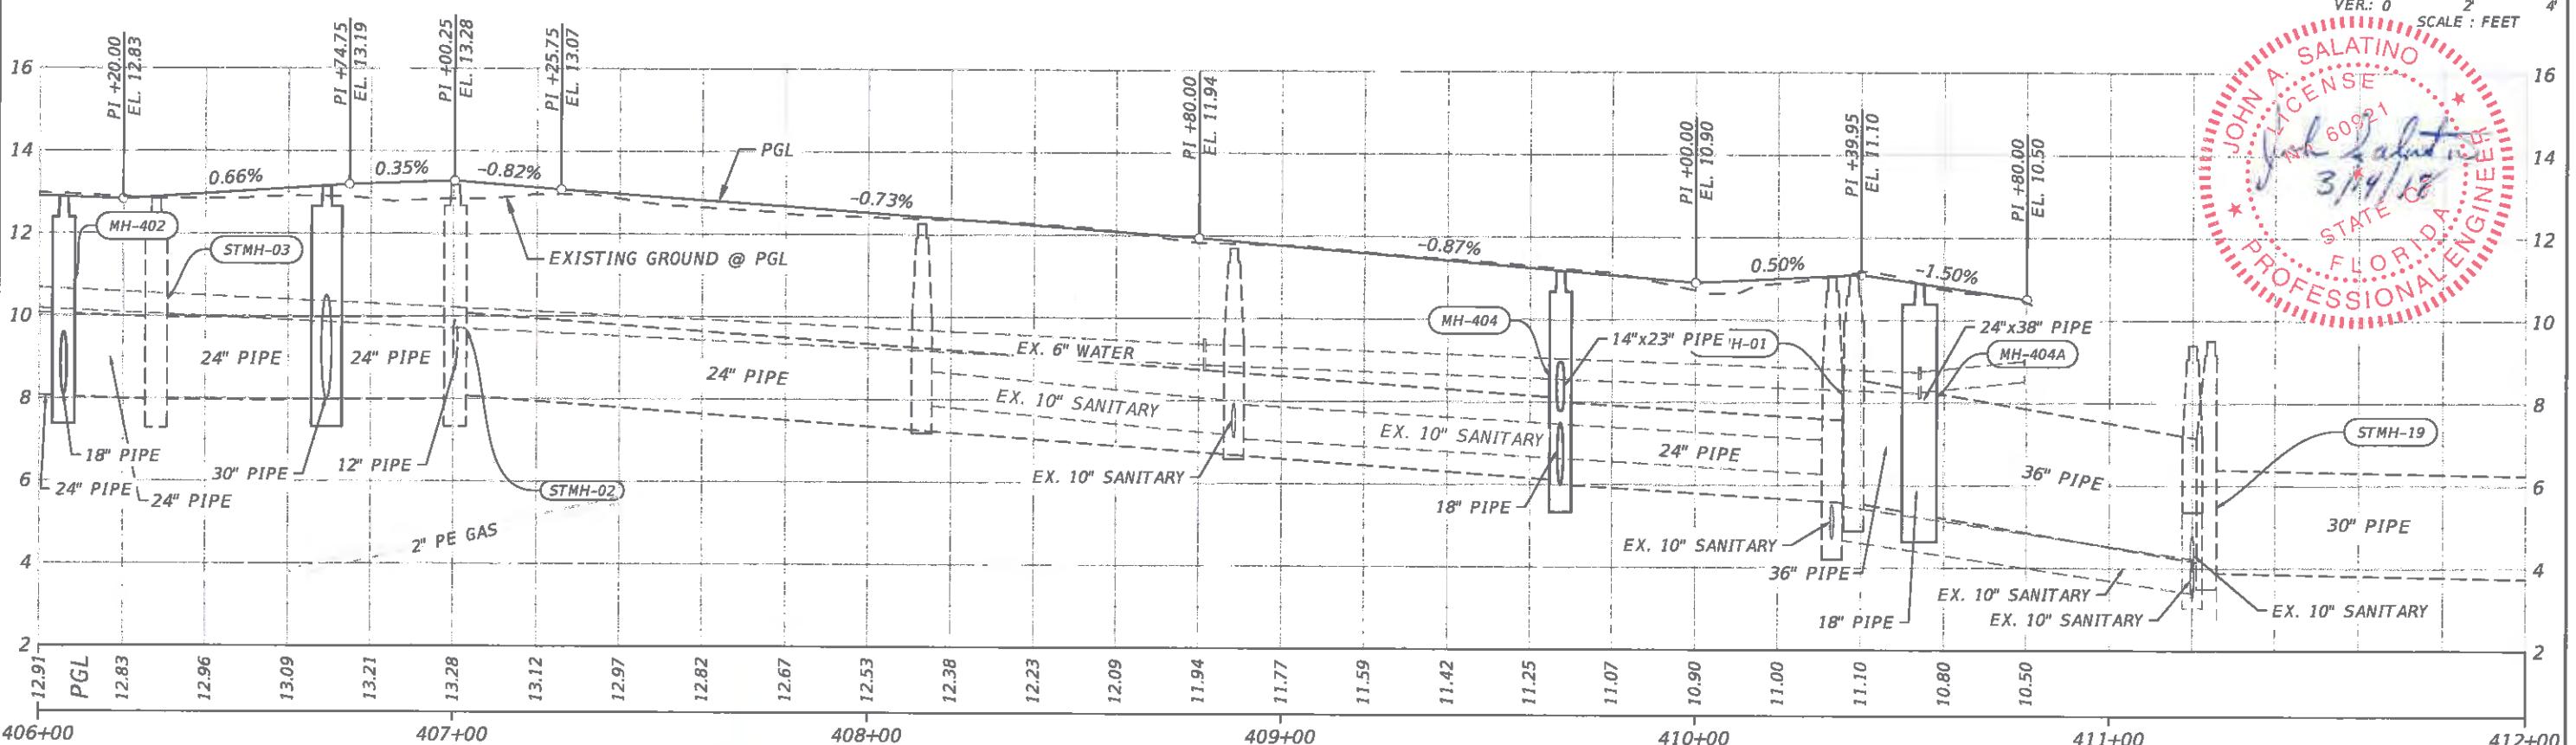


HOR.: 0 20' 40'  
VER.: 0 2' 4'  
SCALE : FEET



JOHN A. SALATINO  
LIC# 60921  
3/14/18  
STATE OF FLORIDA  
PROFESSIONAL ENGINEER

PREPARED FOR:	PREPARED BY:	PROJECT:	DESCRIPTION:	APPROVED BY:	DATE:
DESIGNED MLM DRAWN MA CHECKED MLM	Venice, FL City on the Gulf	ATKINS	CITY OF VENICE DOWNTOWN ROADWAY CORRIDOR IMPROVEMENTS	NASSAU ST. PLAN-PROFILE STA.406+00 TO STA.412+00	JOHN SALATINO, P.E. P.E. LICENSE NUMBER 60921 ATKINS NORTH AMERICA (CERT. OF AUTH. NO. 24) 4030 WEST BOY SCOUT BOULEVARD, SUITE 700 TAMPA, FL 33607-1712
REV. NO. Page 928 of 1140	DATE 3/14/2018	DESCRIPTION	DATE 3/14/2018	PROJECT NO. 100054389	SHEET 39

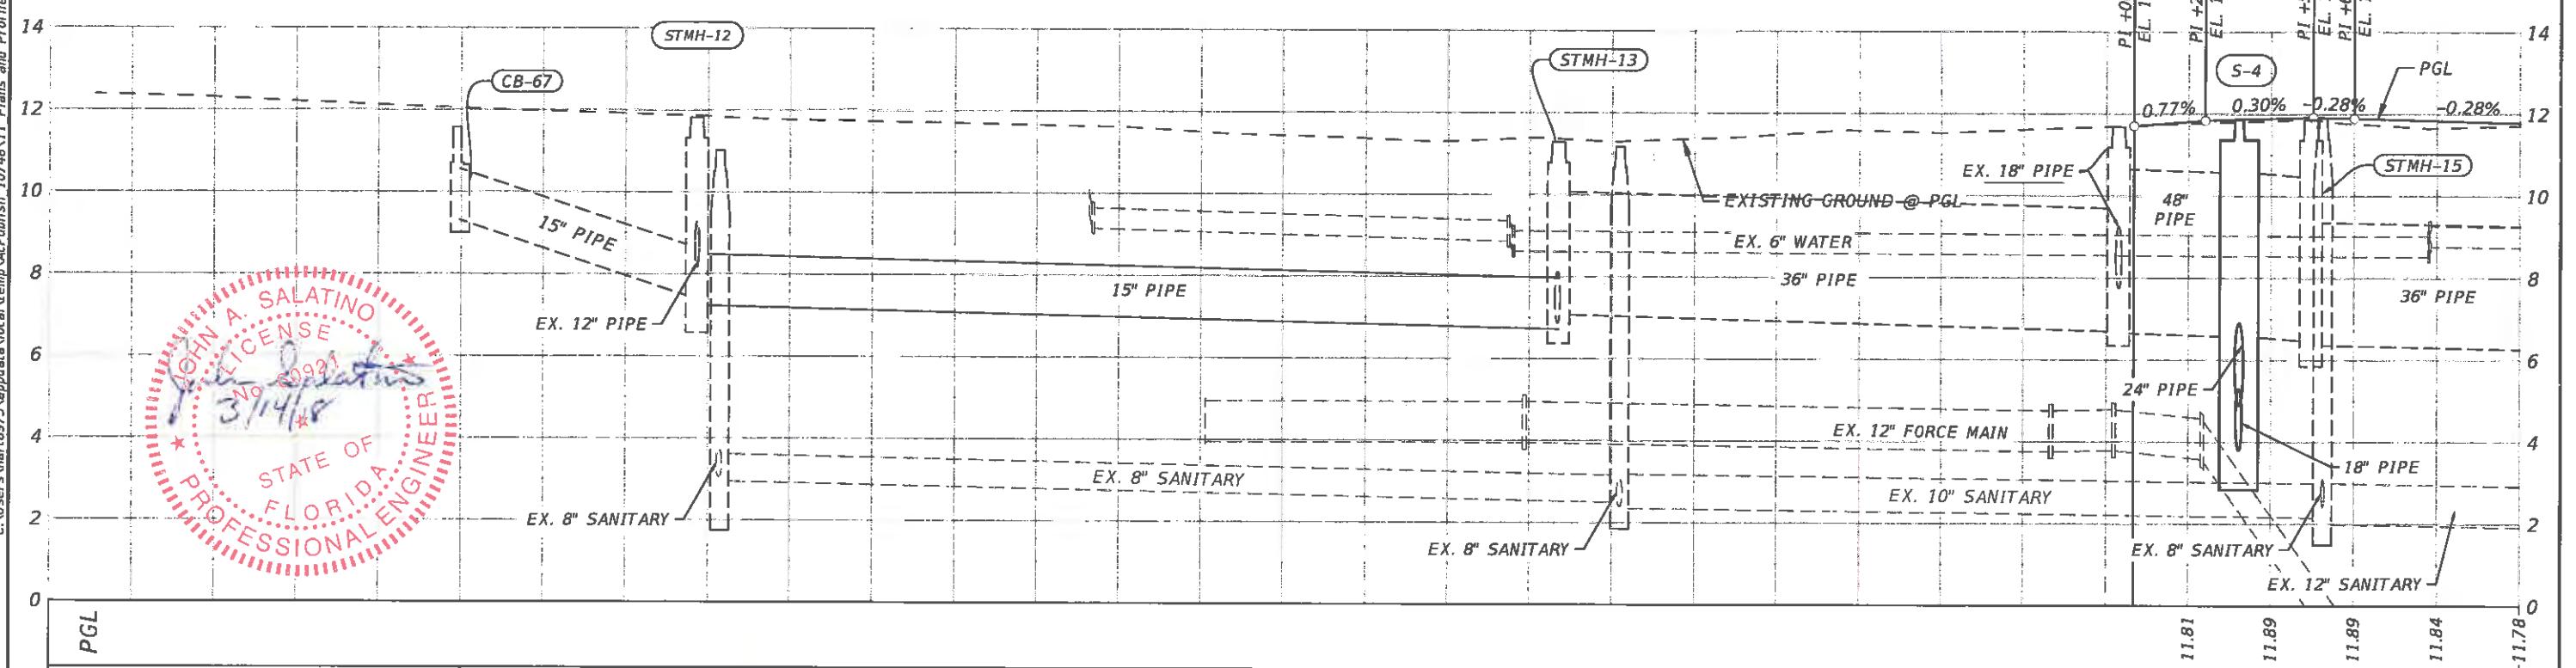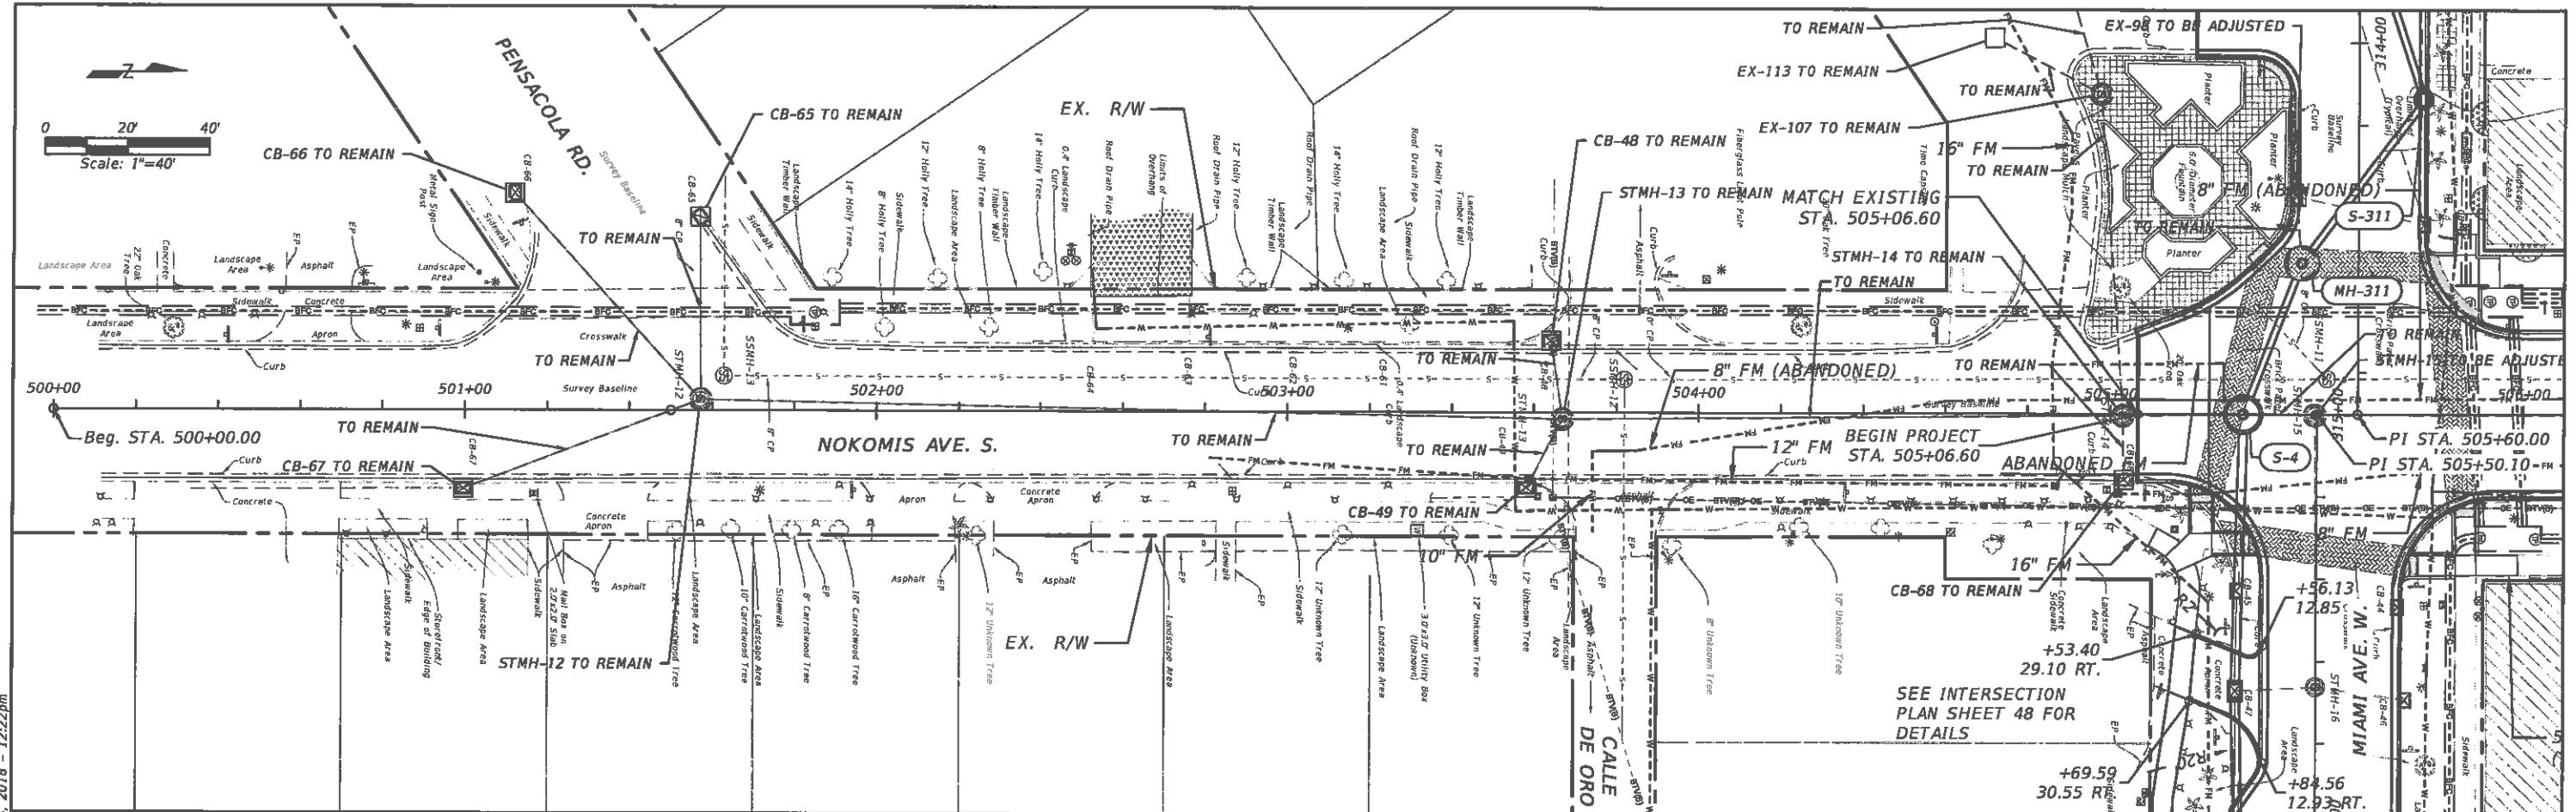


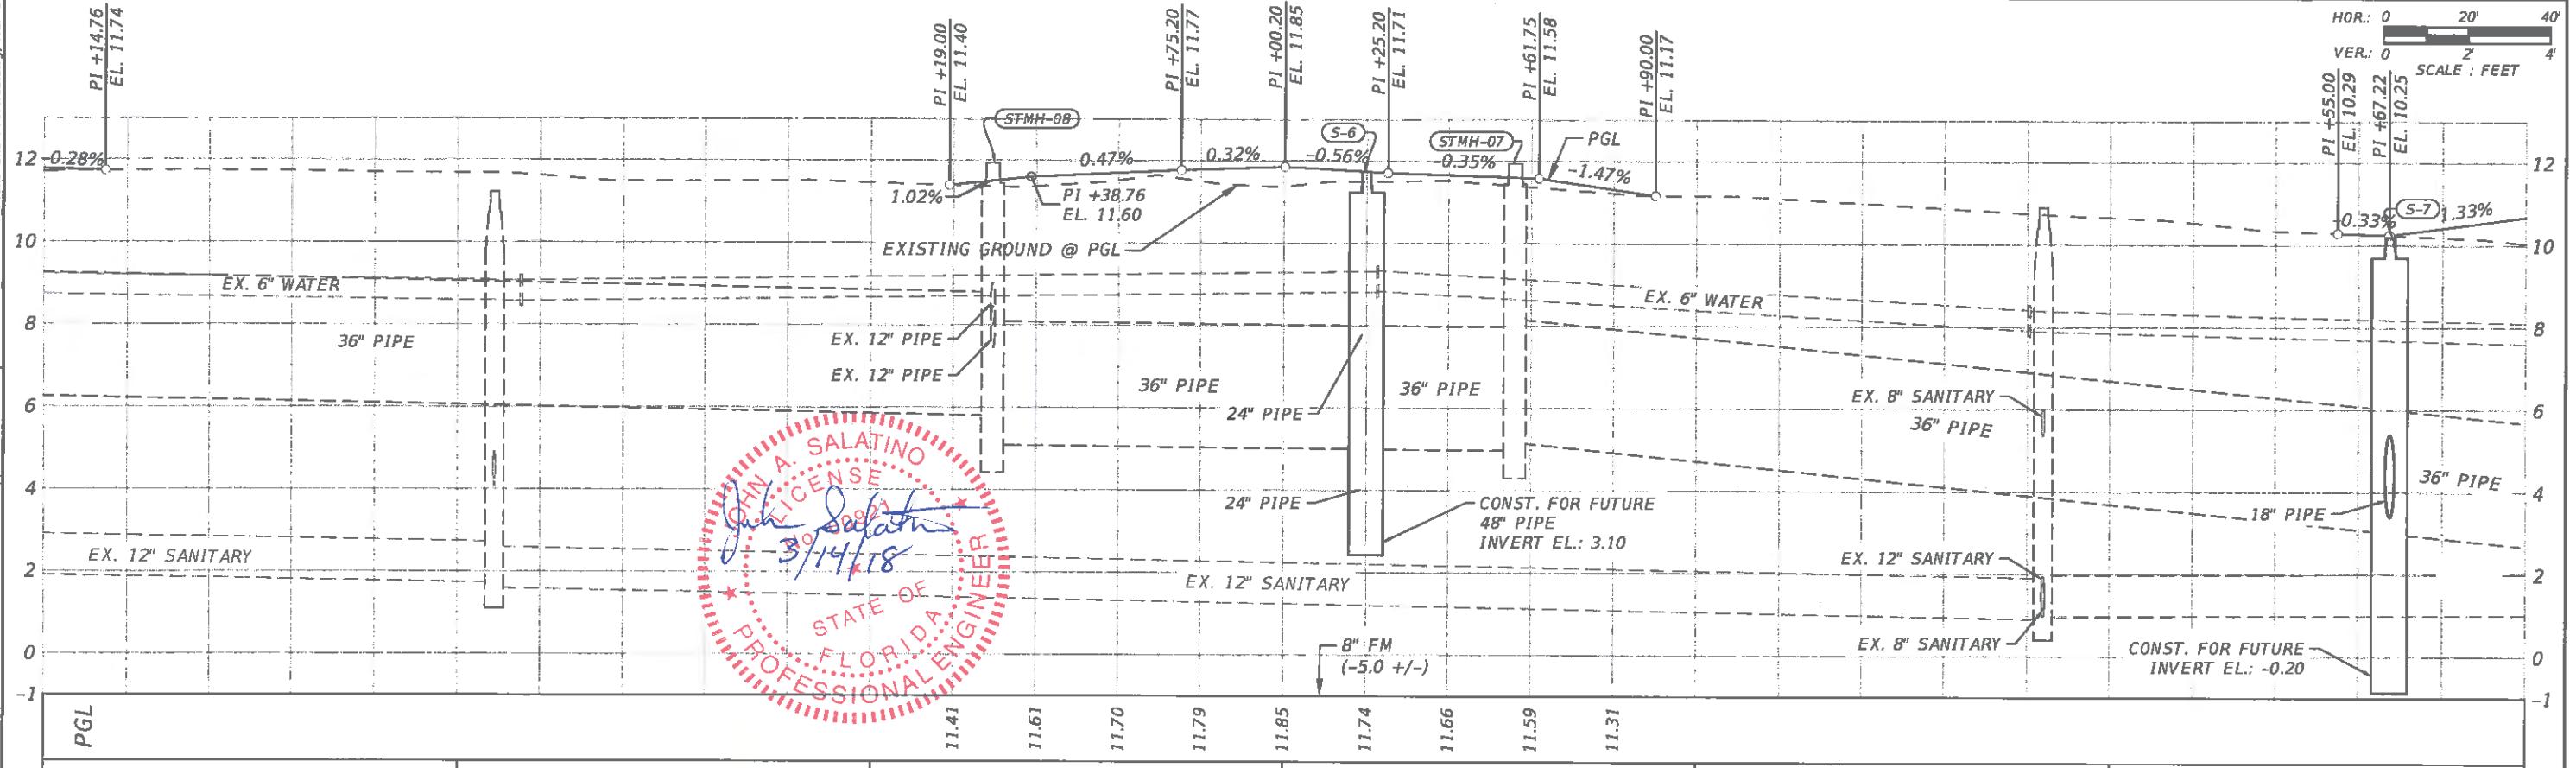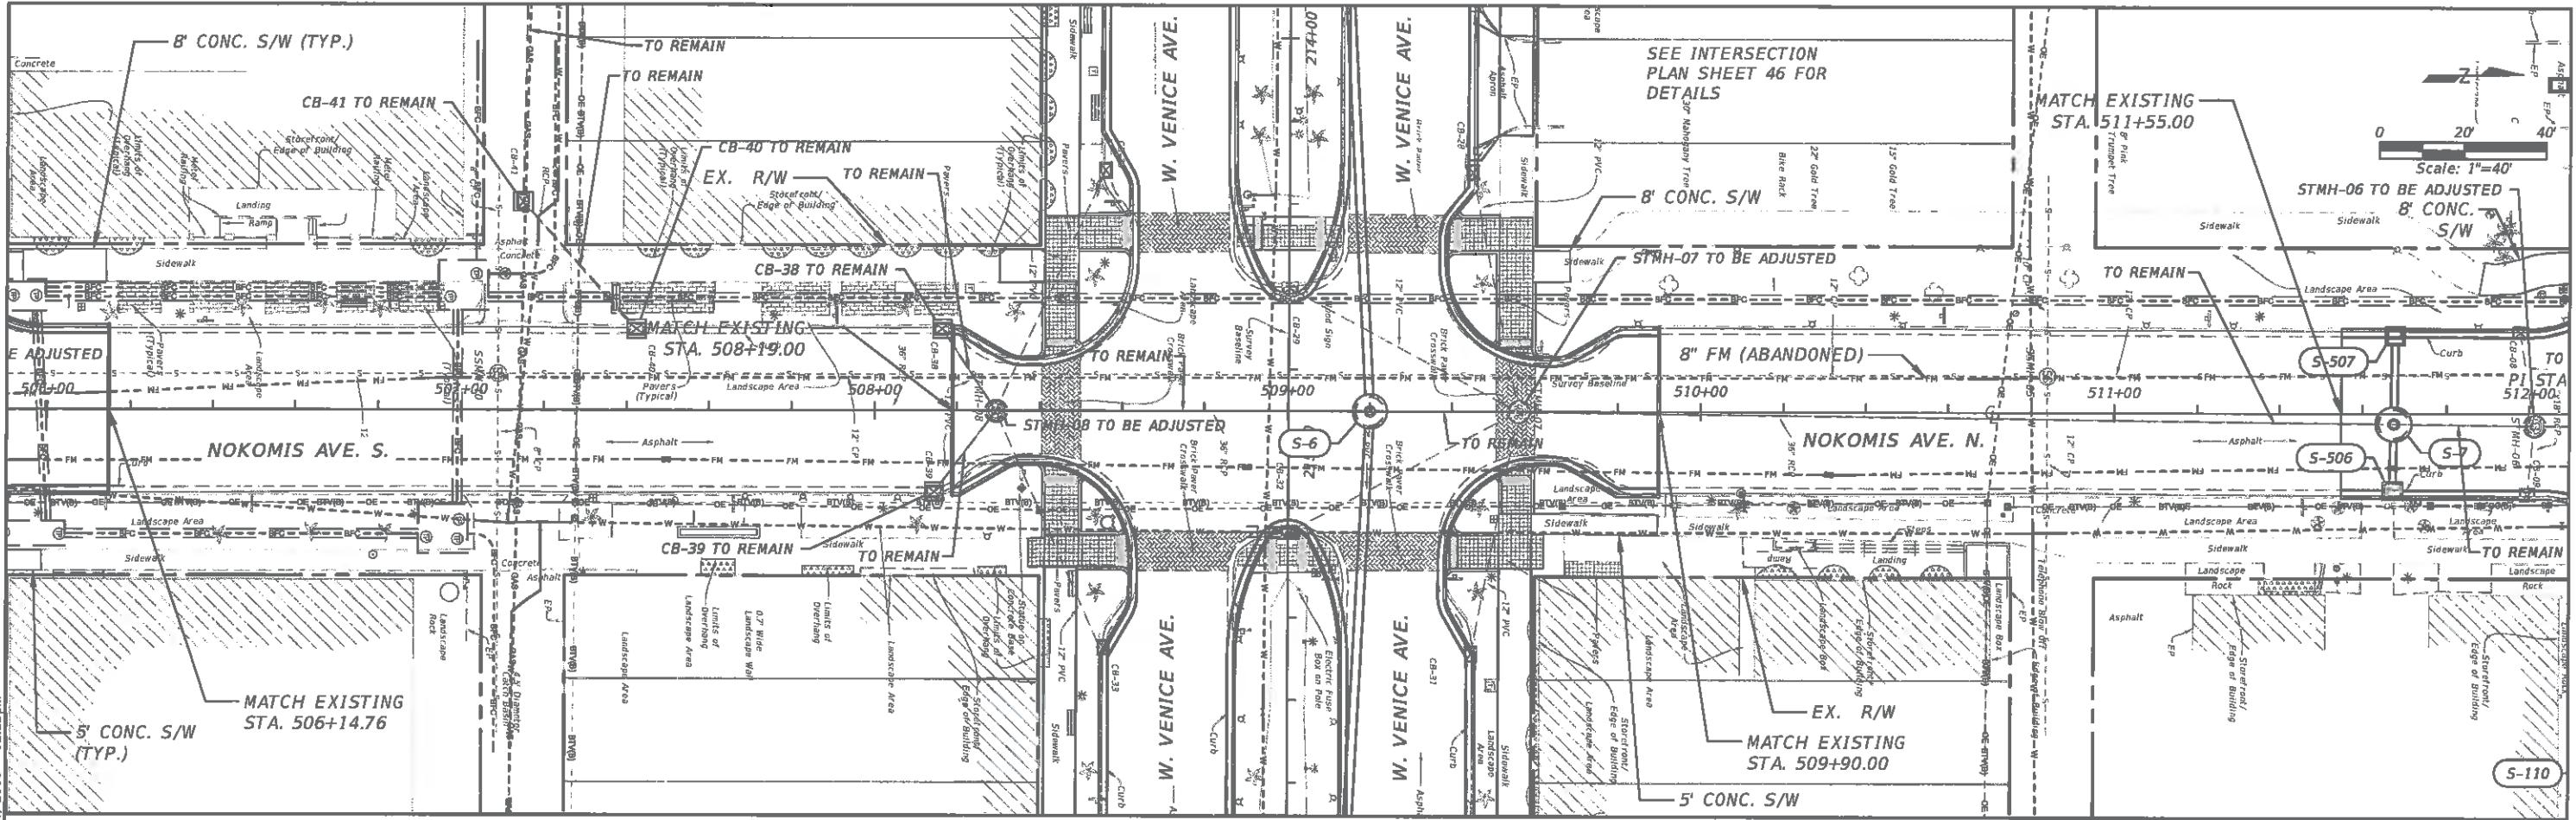


		PREPARED FOR:	PREPARED BY:	PROJECT:	DESCRIPTION:	APPROVED BY:	DATE:
DESIGNED	MLM	DRAWN	MA	CHECKED	MLM	JOHN SALATINO, P.E.	3/14/2018
Page 930 of 1140		Venice, FL City on the Gulf	ATKINS	CITY OF VENICE DOWNTOWN ROADWAY CORRIDOR IMPROVEMENTS	NOKOMIS AVE. PLAN-PROFILE STA.506+00 TO STA.512+00	JOHN SALATINO, P.E. P.E. LICENSE NUMBER 60921 ATKINS NORTH AMERICA (CERT. OF AUTH. NO. 24) 4030 WEST BOY SCOUT BOULEVARD, SUITE 700 TAMPA, FL 33607-1712	DATE PROJECT NO.: 100054389 SHEET: 41
REV. NO.	DATE	DESCRIPTION					

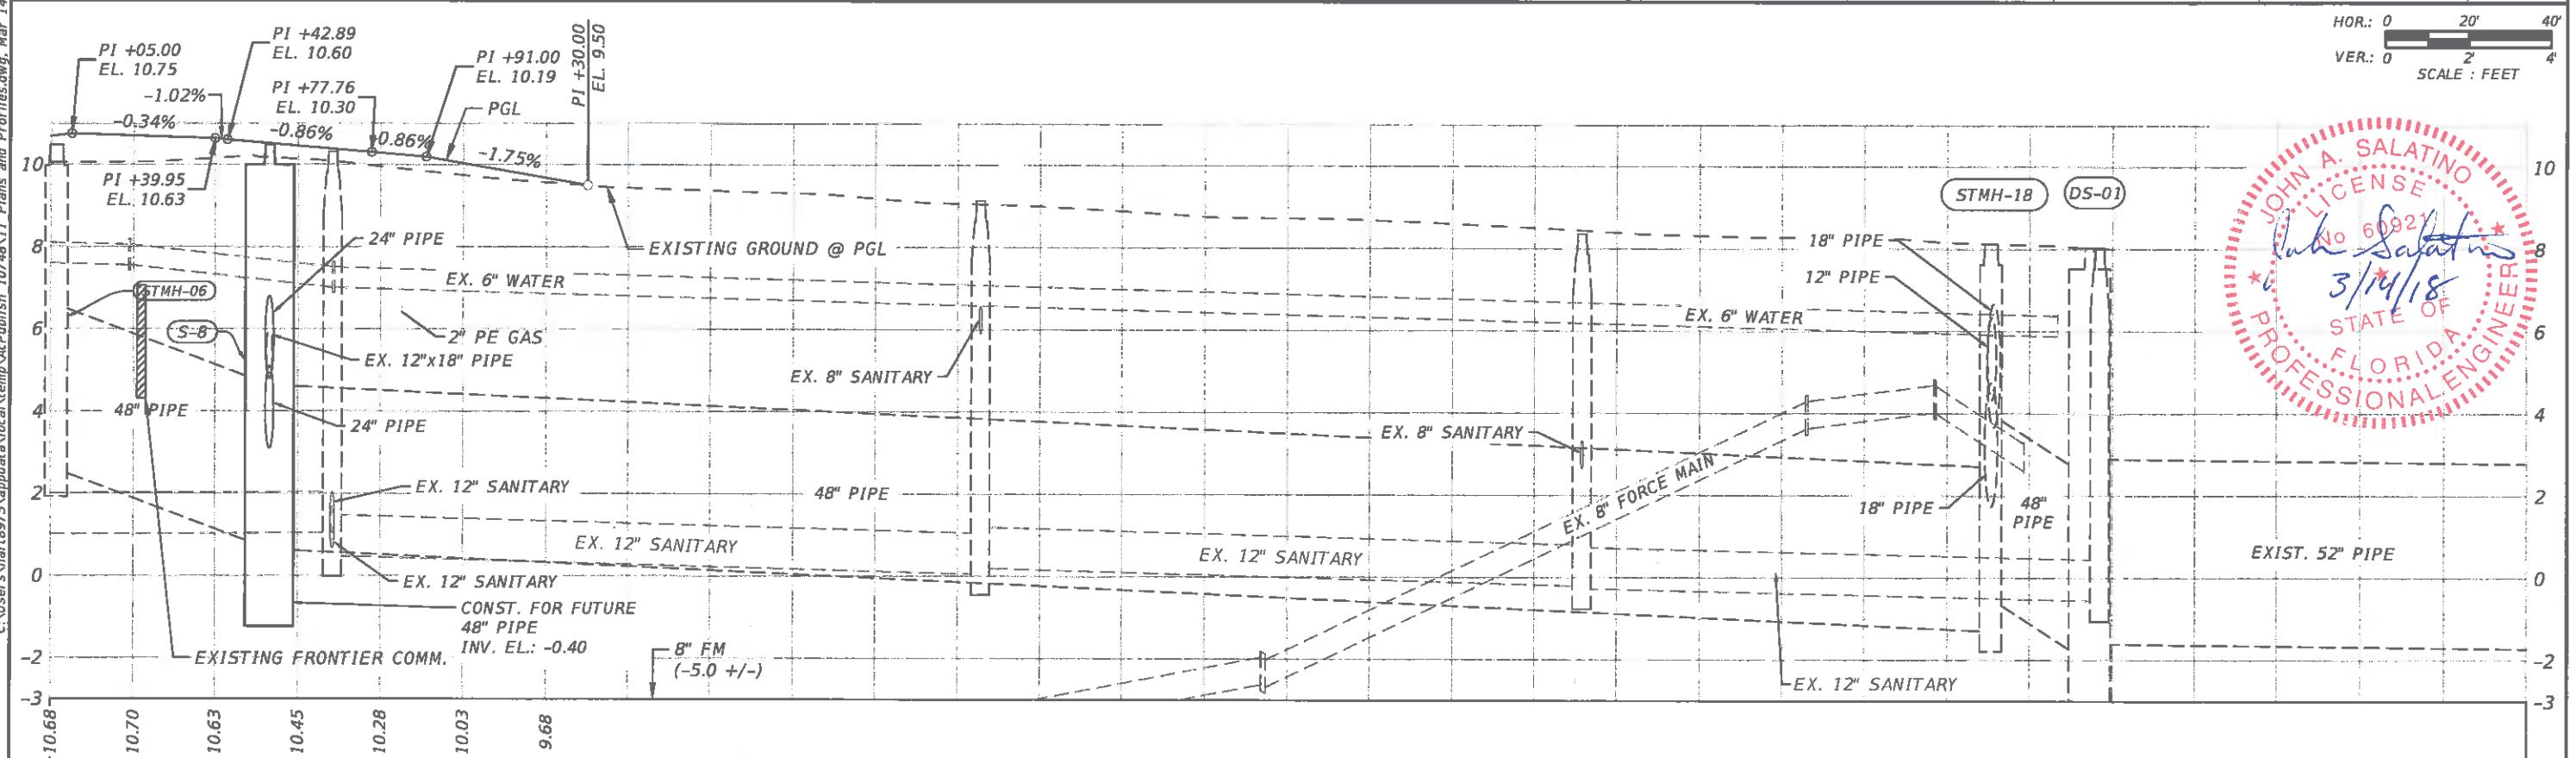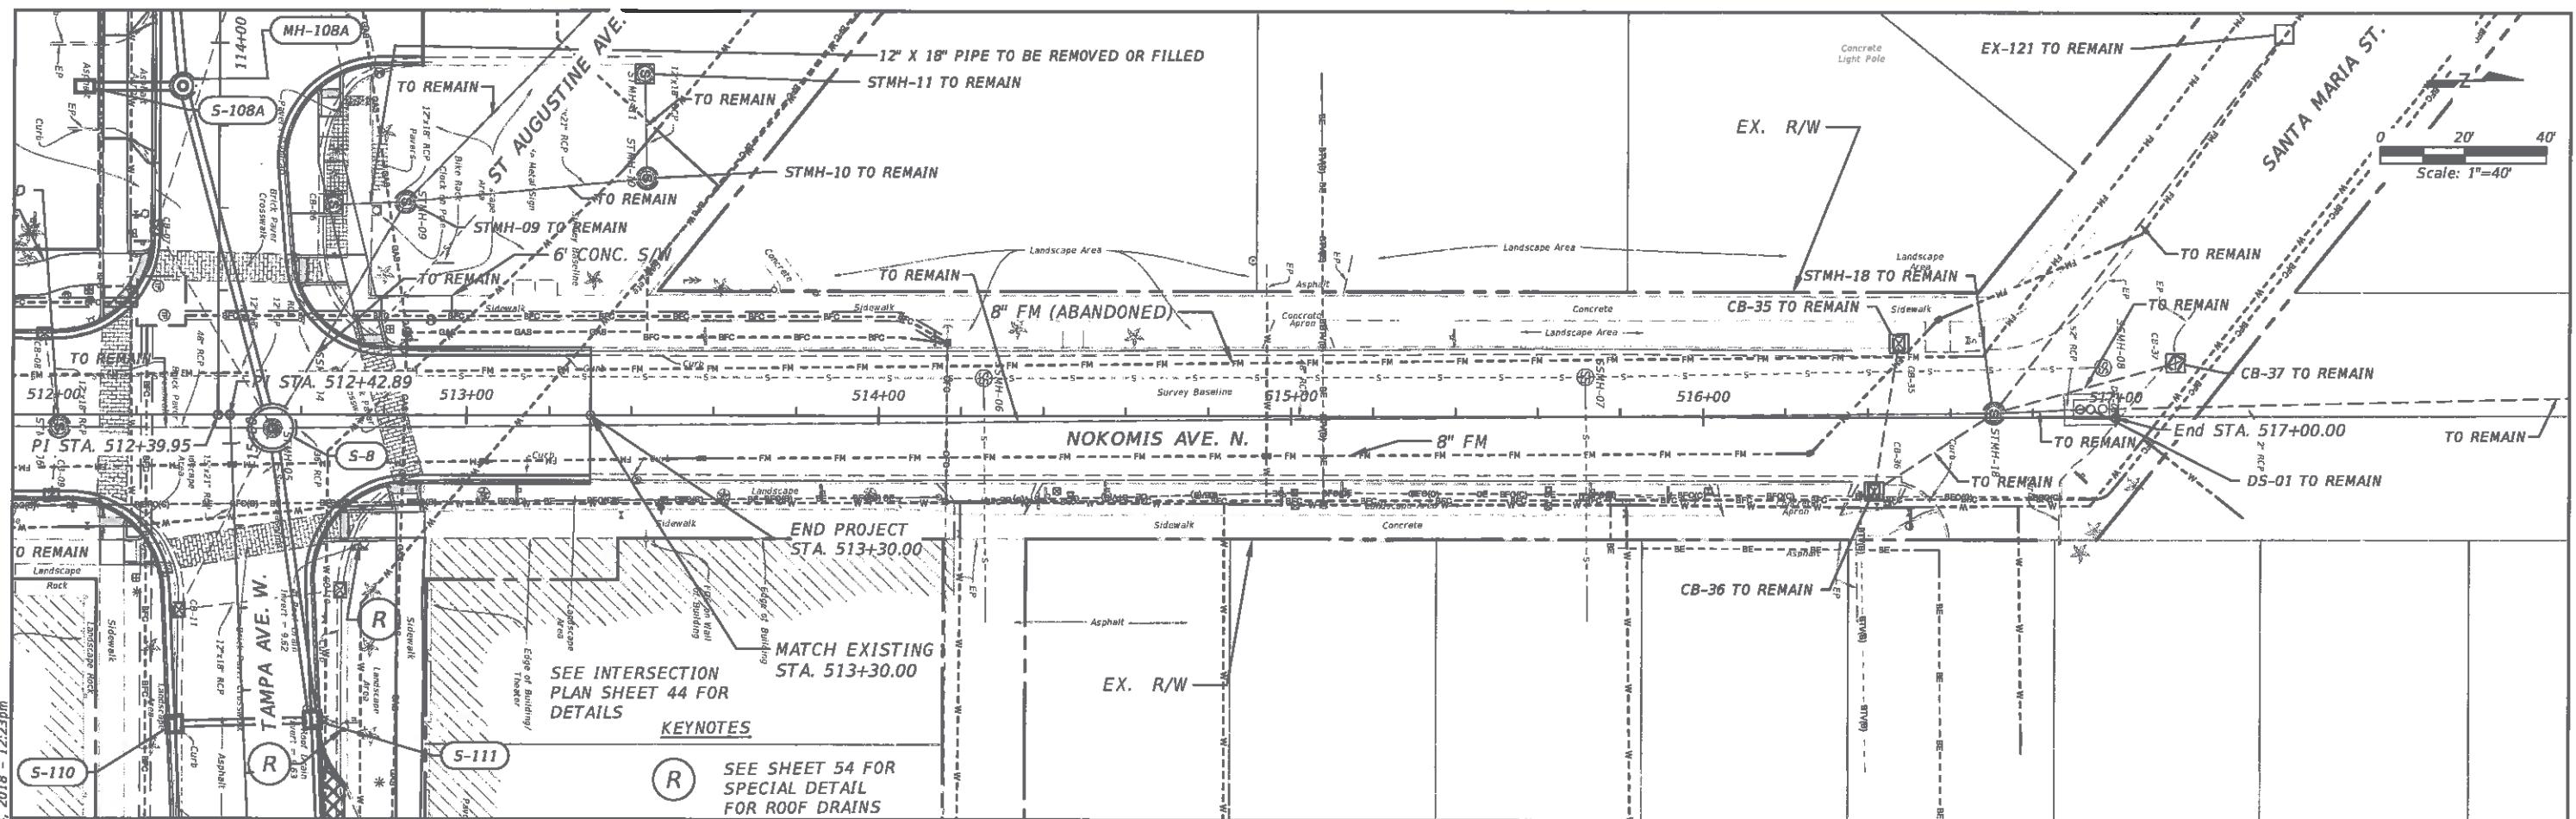

512+00	513+00	514+00	515+00	516+00	517+00	518+00

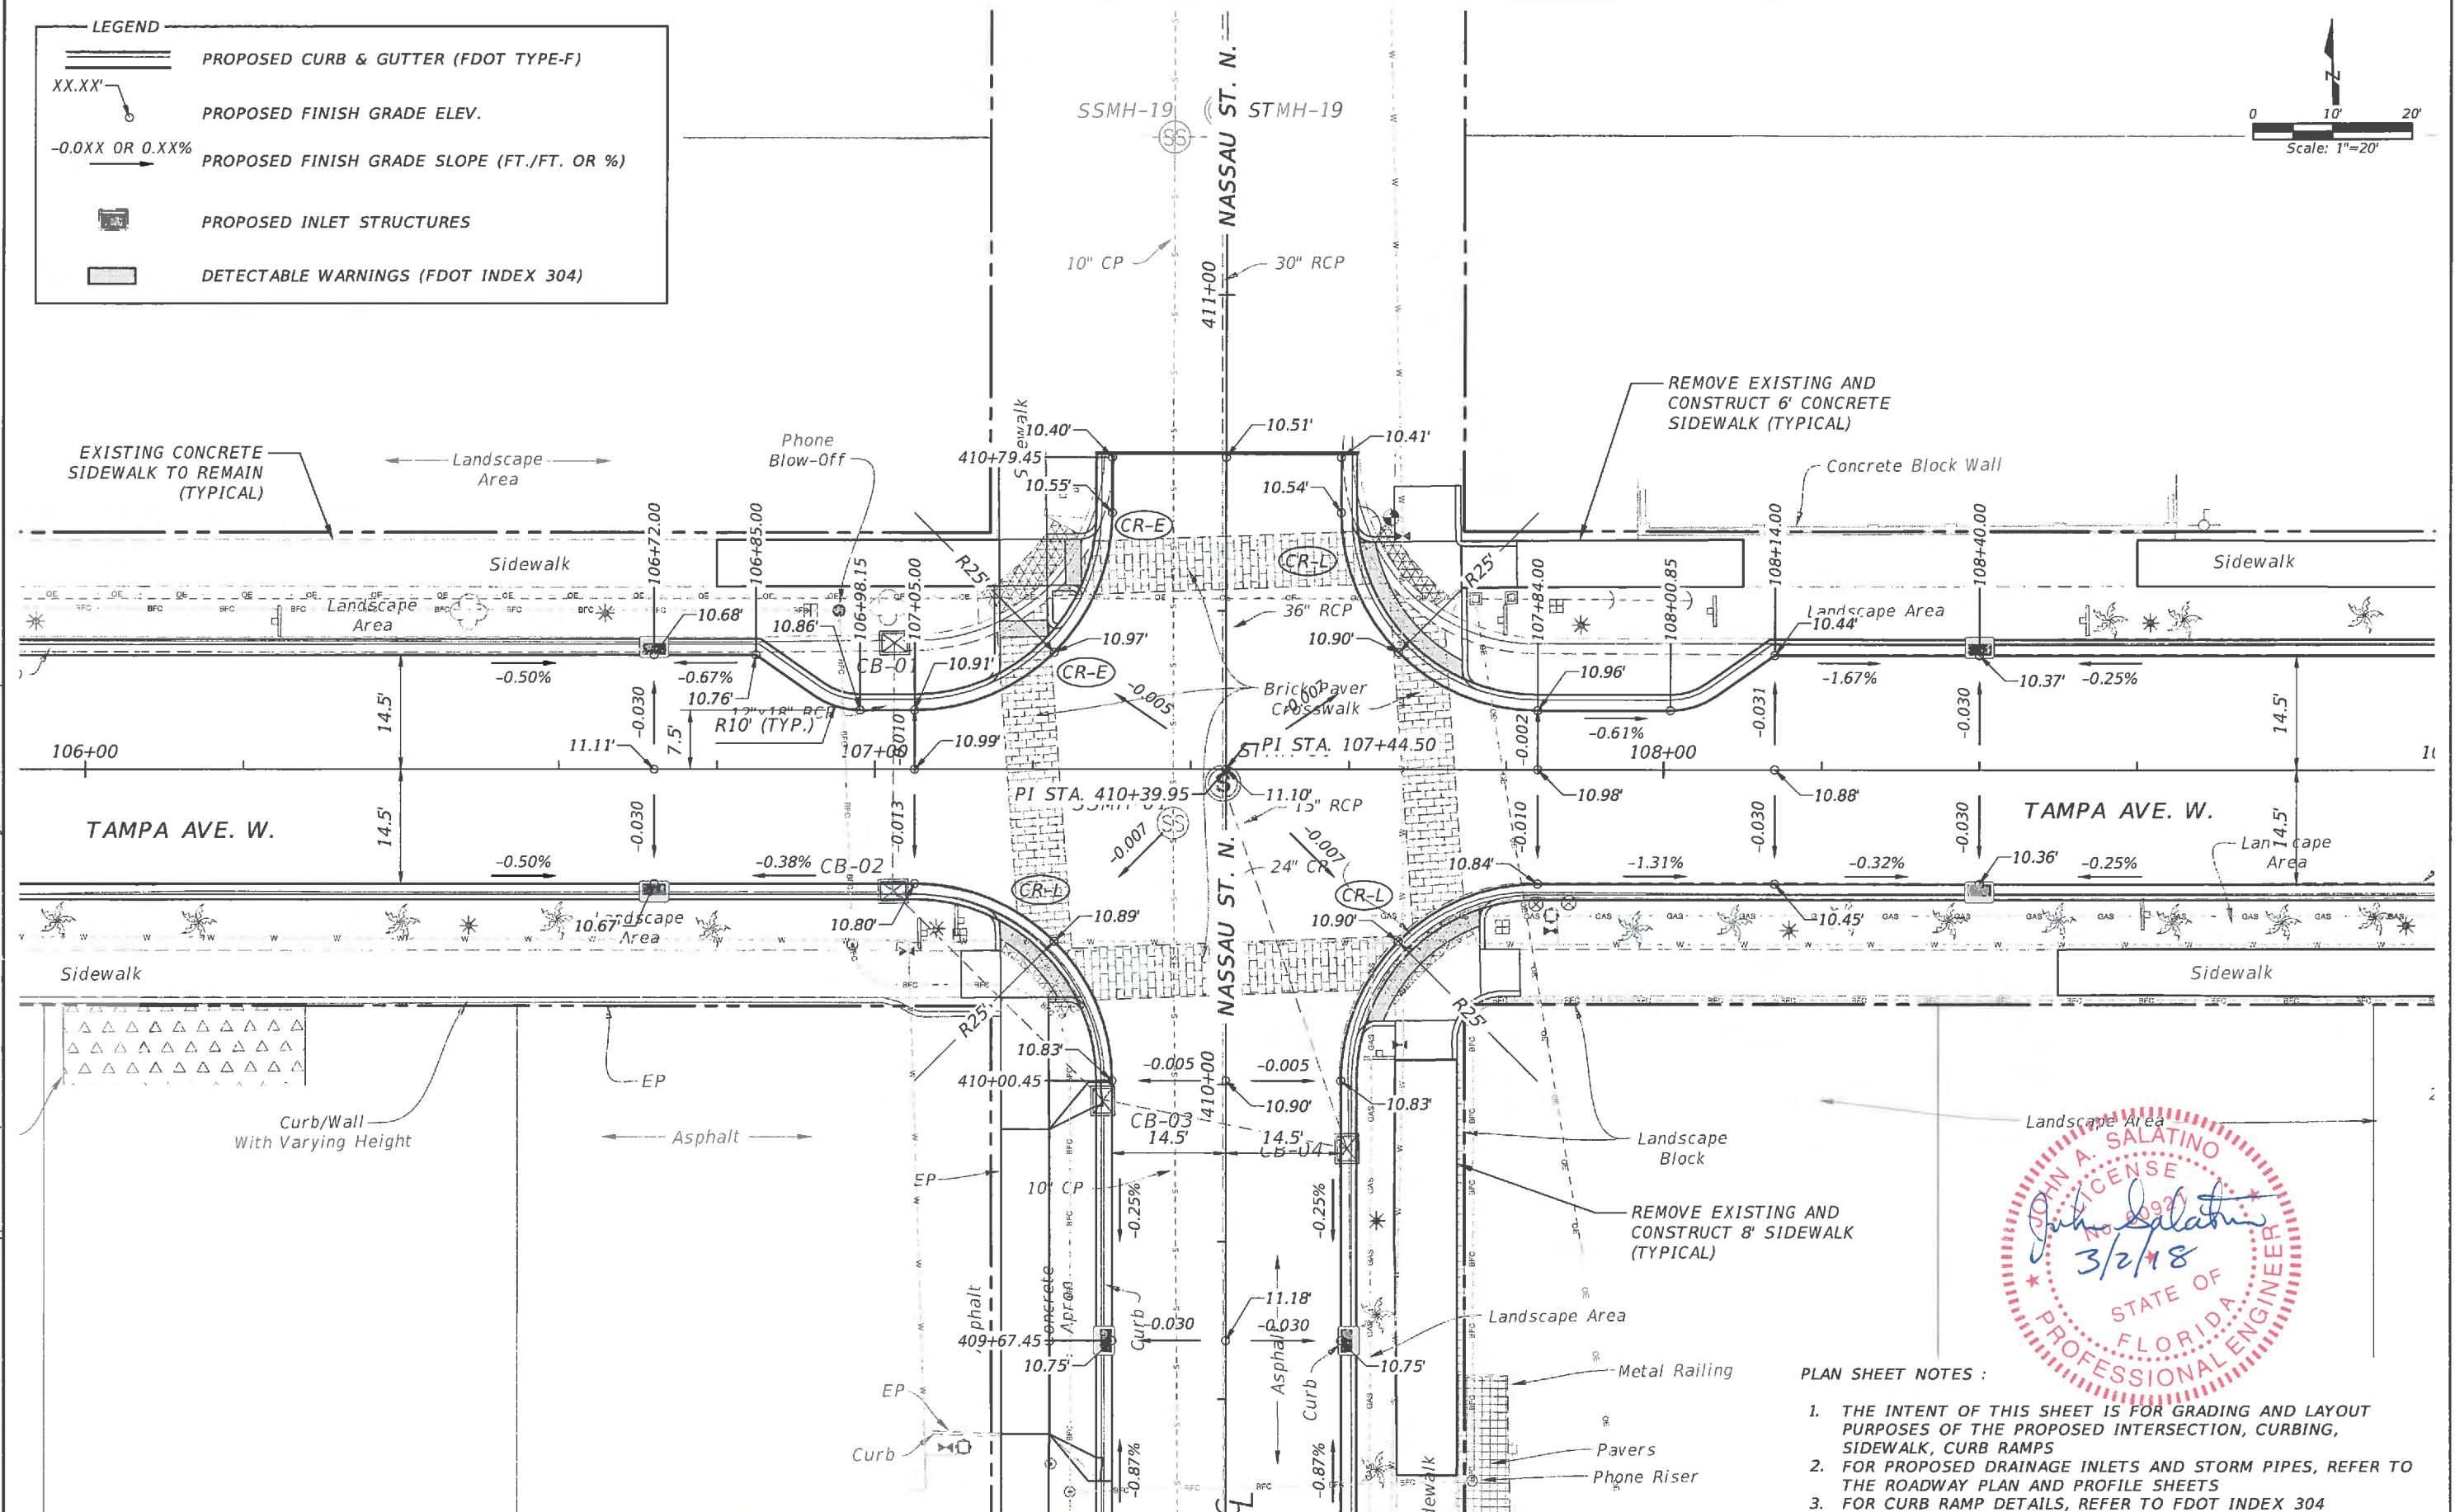

PREPARED FOR:	PREPARED BY:	PROJECT:	DESCRIPTION:	APPROVED BY:	DATE:
DESIGNED MLM DRAWN MA CHECKED MLM	Venice, FL City on the Gulf	ATKINS	CITY OF VENICE DOWNTOWN ROADWAY CORRIDOR IMPROVEMENTS	JOHN SALATINO, P.E. P.E. LICENSE NUMBER 60921 ATKINS NORTH AMERICA (CERT. OF AUTH. NO. 24) 4030 WEST BOY SCOUT BOULEVARD, SUITE 700 TAMPA, FL 33607-1712	2/28/2018
Page 932 of 1140 REV. NO. DATE DESCRIPTION			TAMPA AVE. & NASSAU ST. INTERSECTION PLAN		PROJECT NO.: 100054389 SHEET: 43

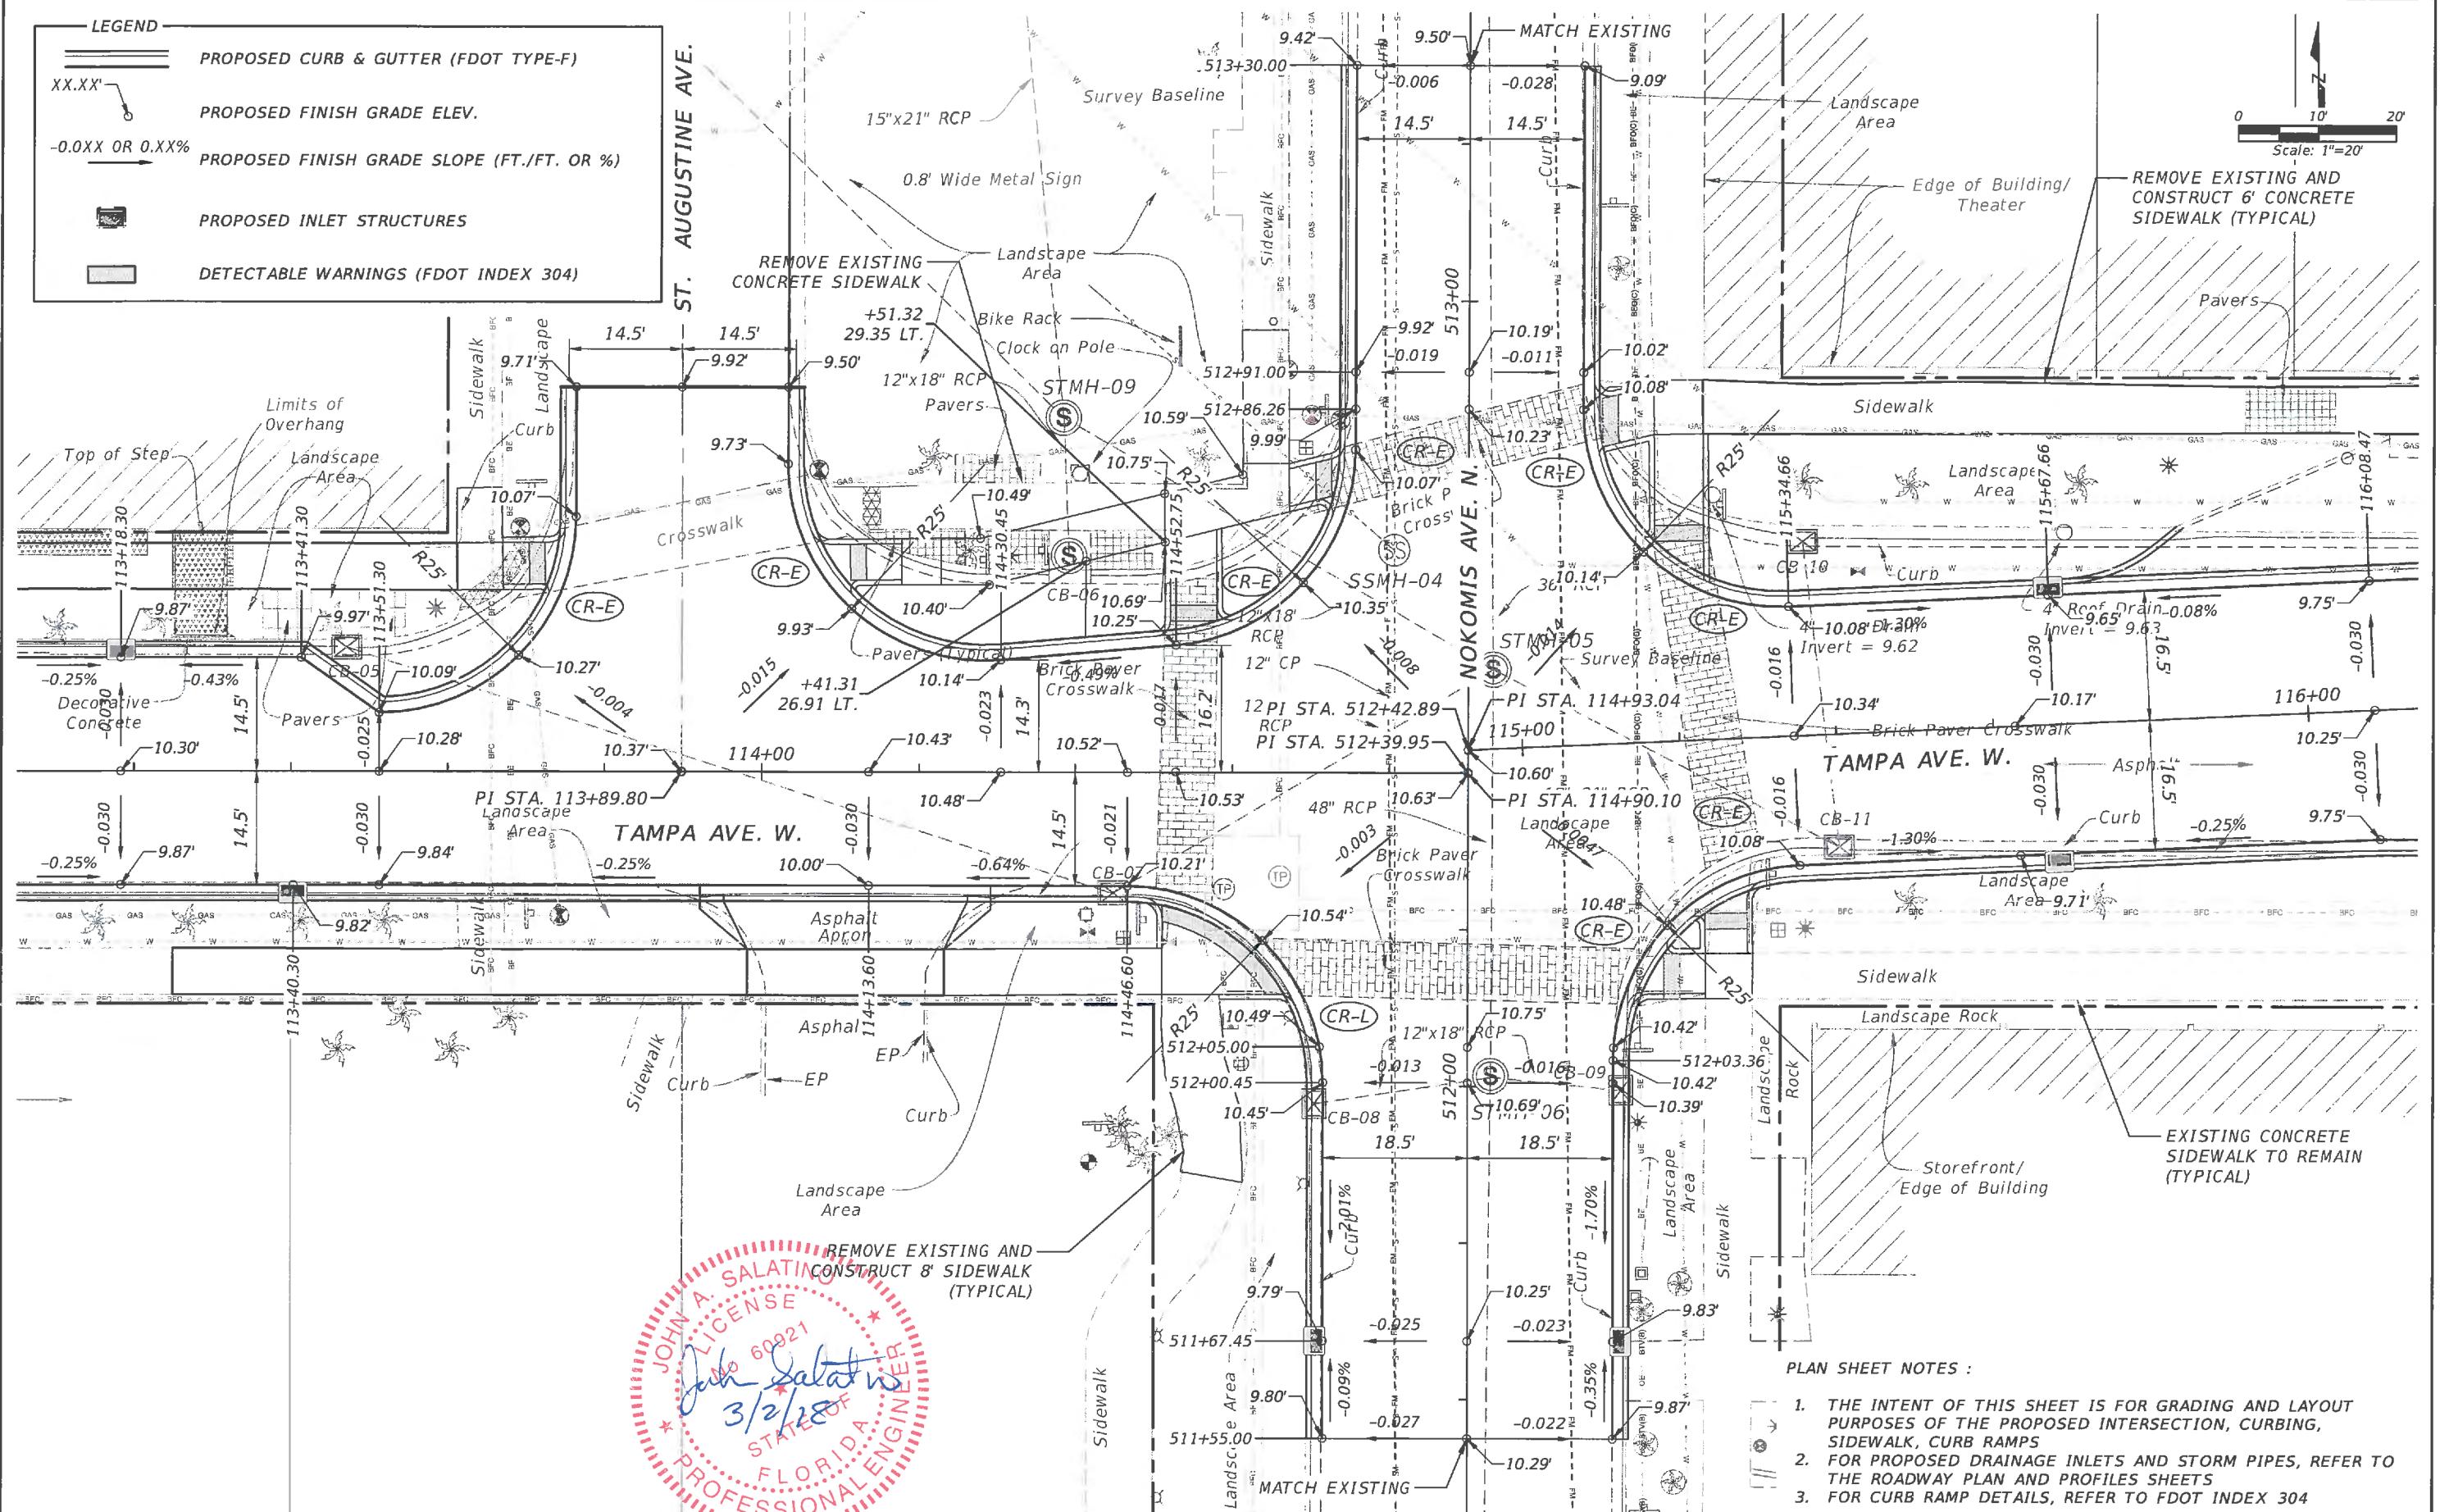

PREPARED FOR:	PREPARED BY:	PROJECT:	DESCRIPTION:	APPROVED BY:	DATE:
DESIGNED MLM	DRAWN MA	ATKINS	CITY OF VENICE DOWNTOWN ROADWAY CORRIDOR IMPROVEMENTS	JOHN SALATINO, P.E. P.E. LICENSE NUMBER 60921 ATKINS NORTH AMERICA (CERT. OF AUTH. NO. 24) 4030 WEST BOY SCOUT BOULEVARD, SUITE 700 TAMPA, FL 33607-1712	2/28/2018
Page 933 of 1140	MA	ATKINS	TAMPA AVE. & NOKOMIS AVE. INTERSECTION PLAN	JOHN SALATINO, P.E. P.E. LICENSE NUMBER 60921 ATKINS NORTH AMERICA (CERT. OF AUTH. NO. 24) 4030 WEST BOY SCOUT BOULEVARD, SUITE 700 TAMPA, FL 33607-1712	2/28/2018

PREPARED FOR:  
**Venice, FL**  
City on the Gulf


PREPARED BY:  
**ATKINS**


PROJECT:  
CITY OF VENICE  
DOWNTOWN ROADWAY  
CORRIDOR IMPROVEMENTS

DESCRIPTION:  
TAMPA AVE.  
& NOKOMIS AVE.  
INTERSECTION PLAN


APPROVED BY:  
JOHN SALATINO, P.E.  
P.E. LICENSE NUMBER 60921  
ATKINS NORTH AMERICA (CERT. OF AUTH. NO. 24)  
4030 WEST BOY SCOUT BOULEVARD, SUITE 700  
TAMPA, FL 33607-1712

DATE:  
2/28/2018  
PROJECT NO.:  
100054389  
SHEET:  
44

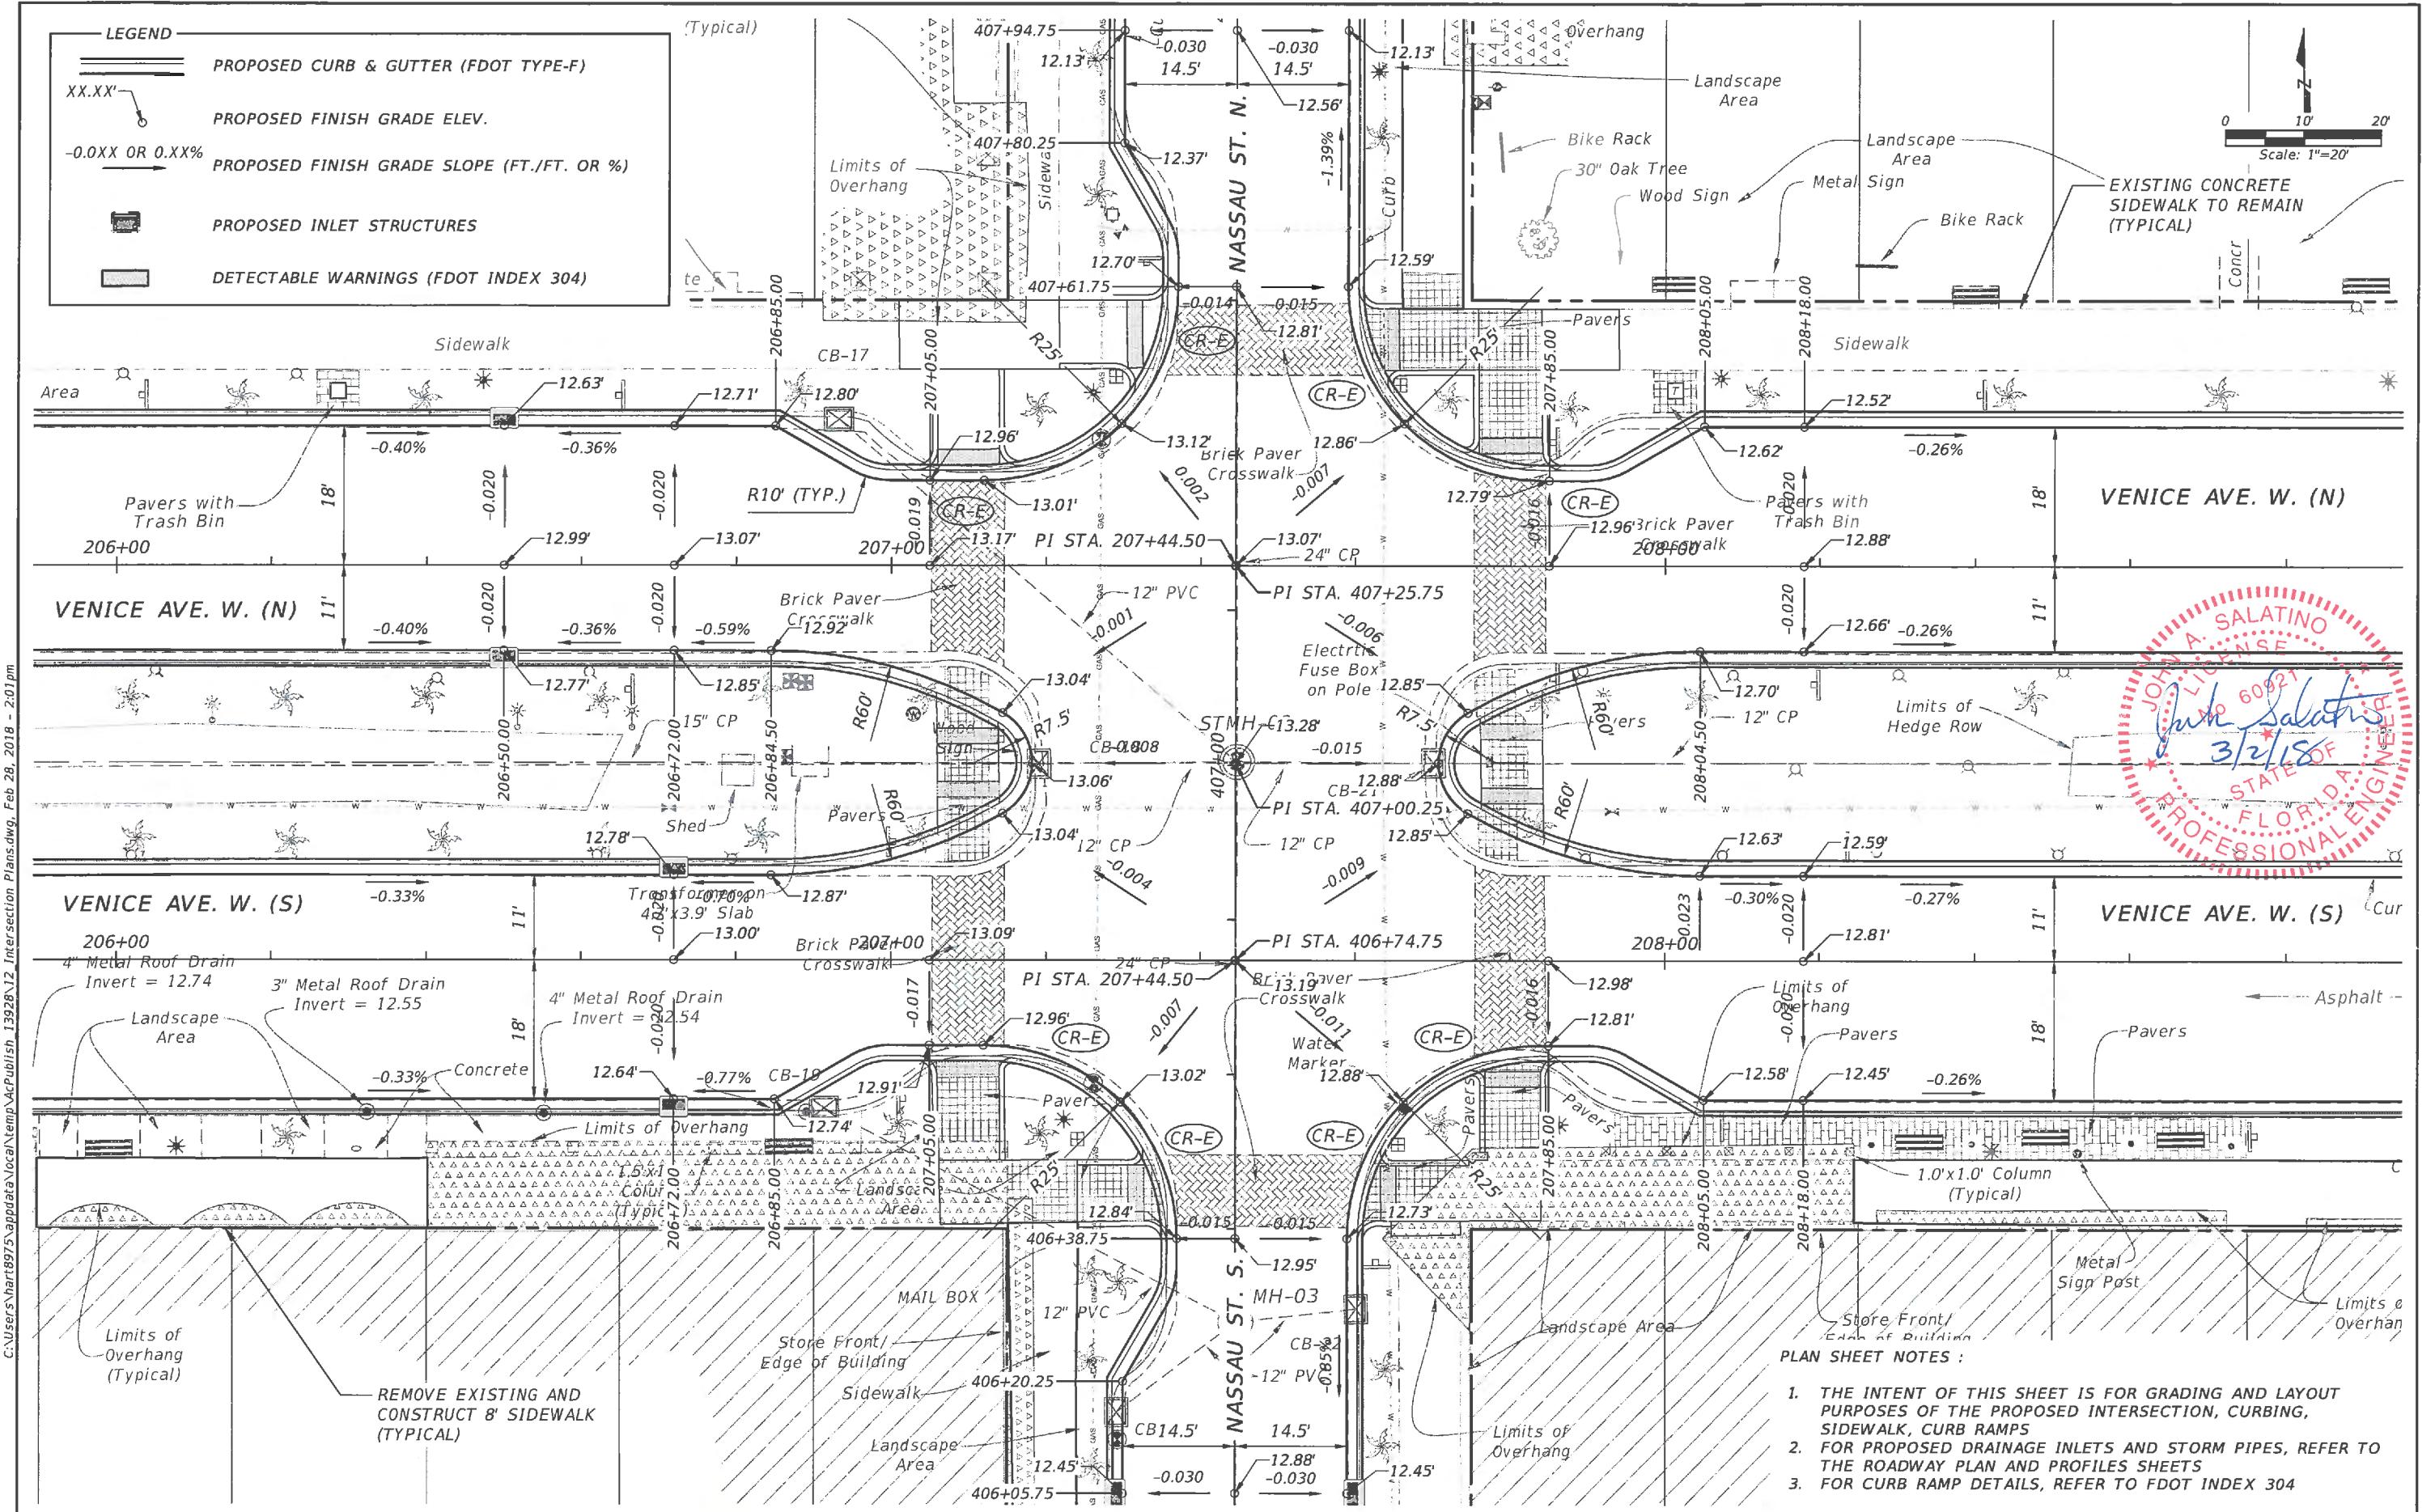

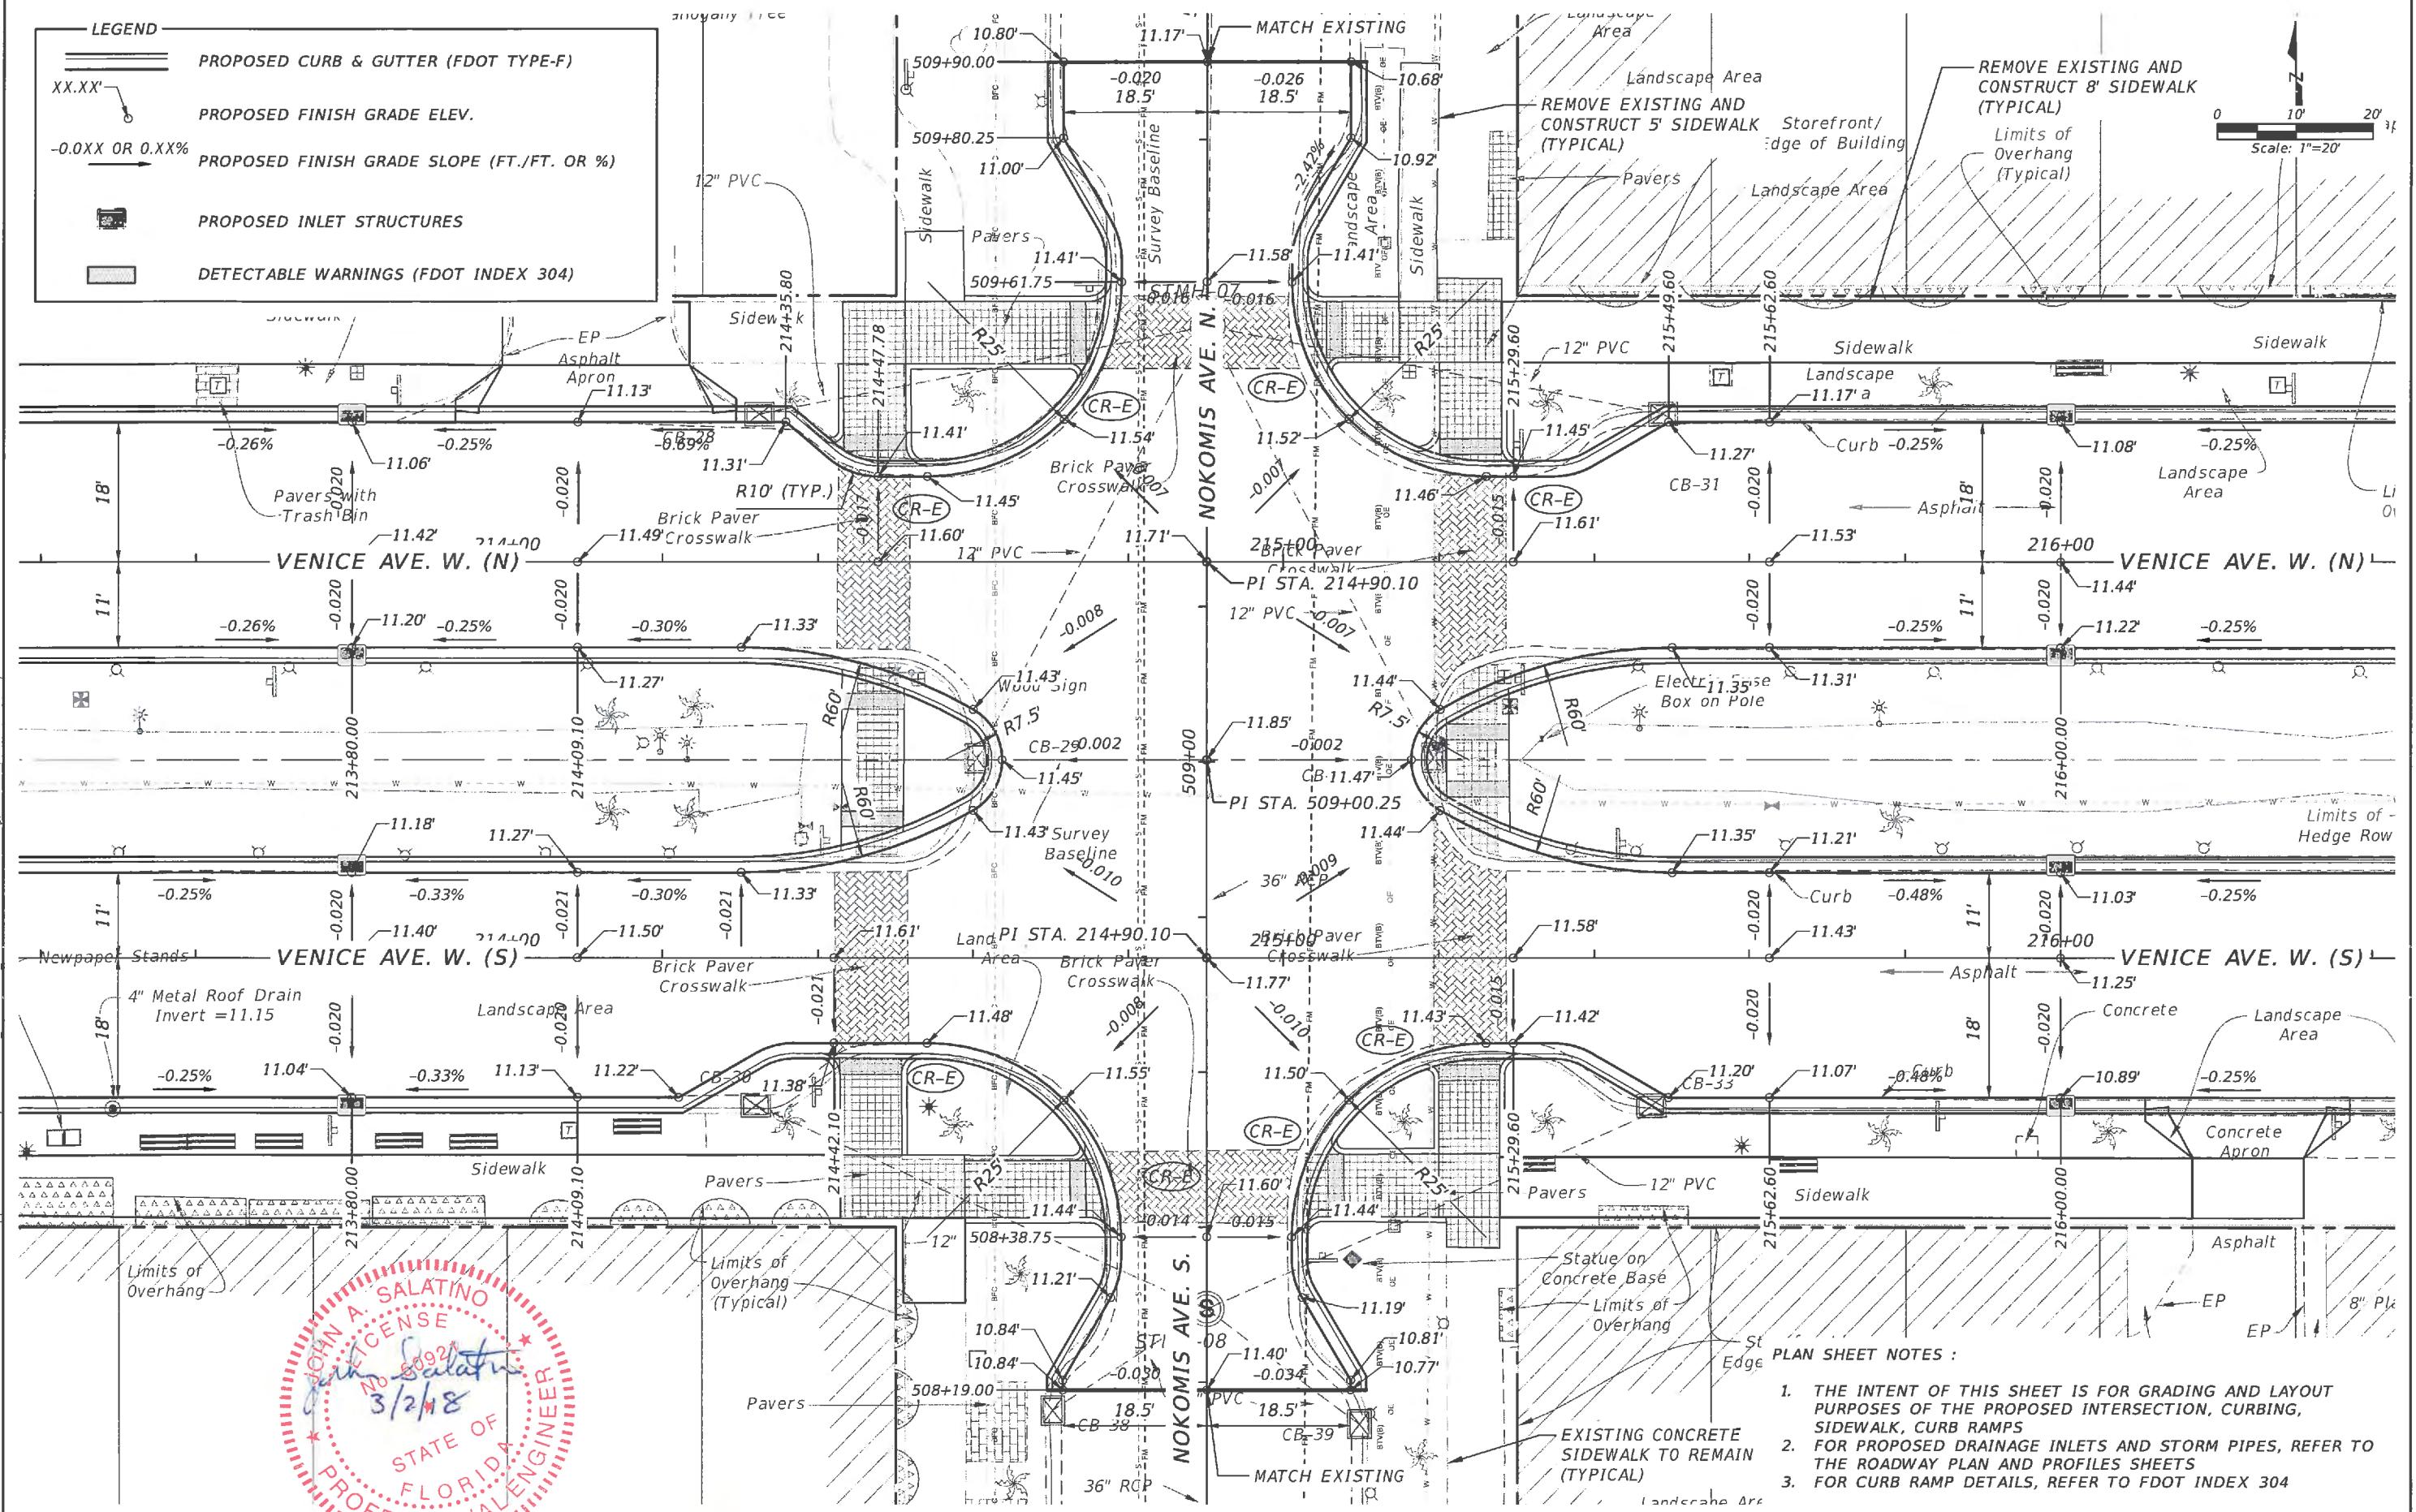

PREPARED FOR:	PREPARED BY:	PROJECT:	DESCRIPTION:	APPROVED BY:	DATE:
DESIGNED MLM DRAWN MA CHECKED MLM	Venice, FL City on the Gulf	ATKINS	CITY OF VENICE DOWNTOWN ROADWAY CORRIDOR IMPROVEMENTS	JOHN SALATINO, P.E. P.E. LICENSE NUMBER 60921 ATKINS NORTH AMERICA (CERT. OF AUTH. NO. 24) 4030 WEST BOY SCOUT BOULEVARD, SUITE 700 TAMPA, FL 33607-1712	2/28/2018 DATE PROJECT NO.: 100054389 SHEET: 46
Page 935 of 1140 REV. NO. DATE DESCRIPTION			VENICE AVE. & NOKOMIS AVE. INTERSECTION PLAN		

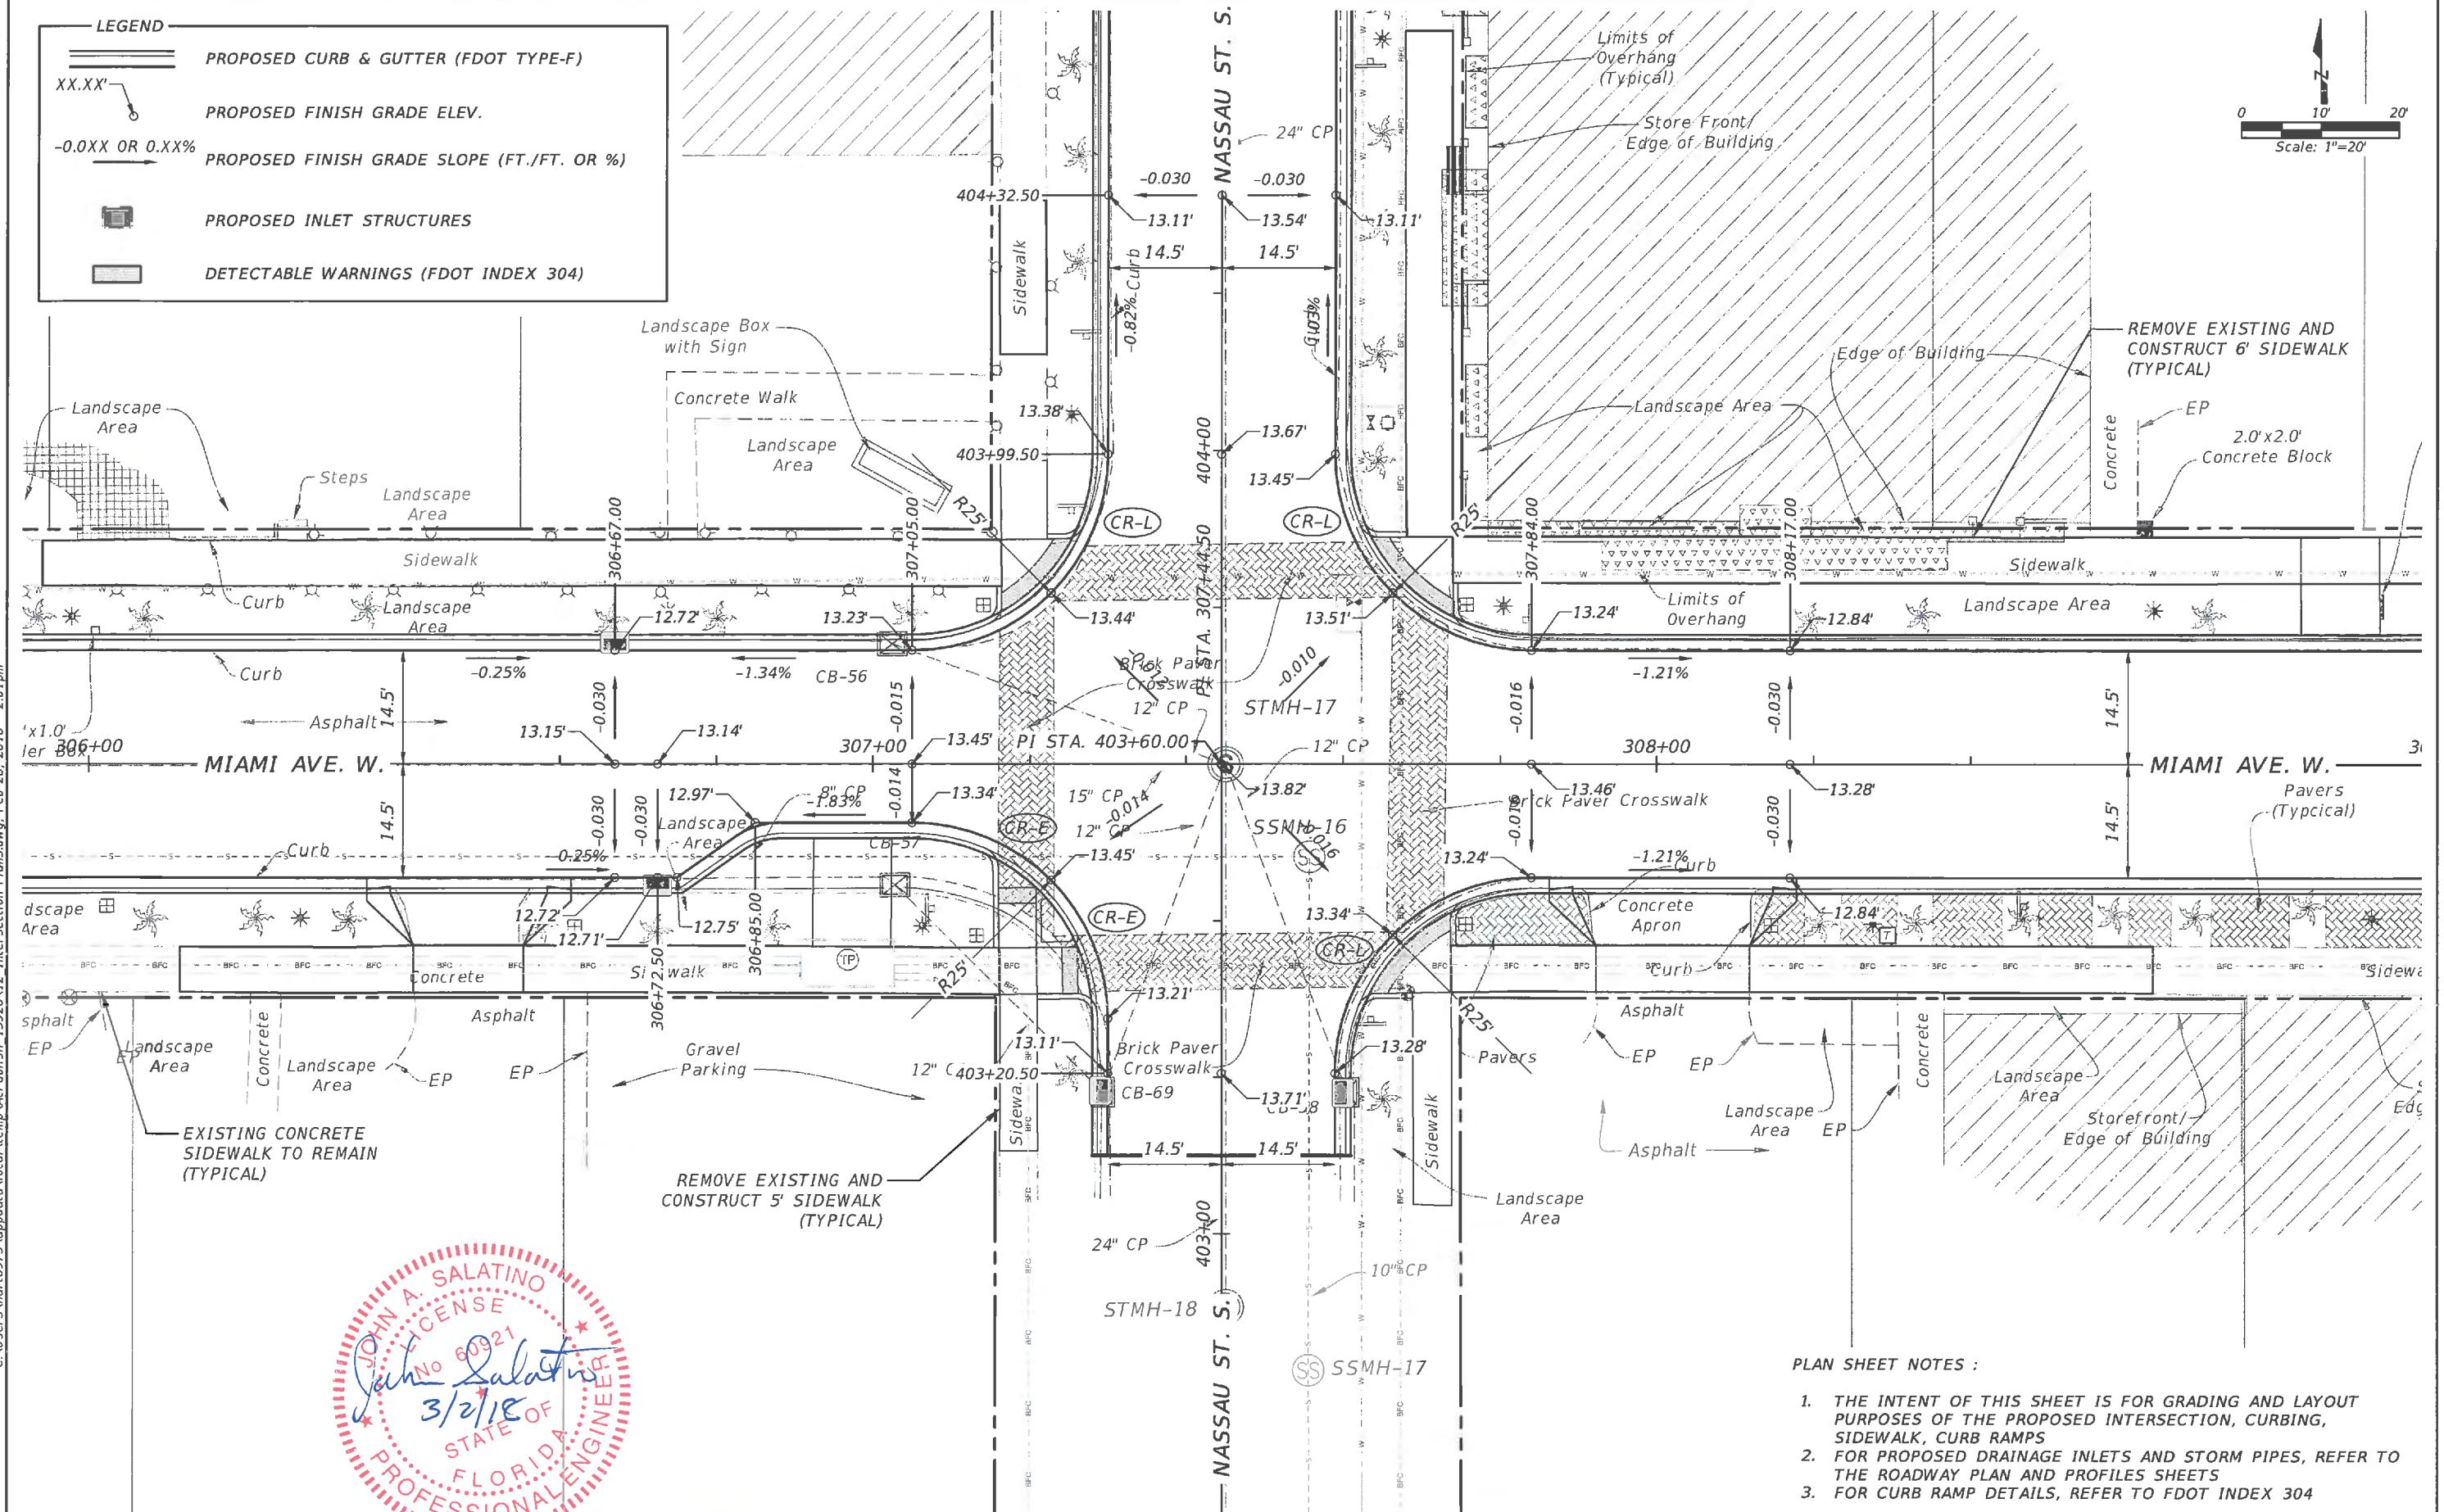

		DESIGNED MLM	DRAWN MA	CHECKED MLM
Page 936 of 1140				
REV. NO.	DATE	DESCRIPTION		

PREPARED FOR:  
**Venice, FL**  
City on the Gulf


PREPARED BY:  
**ATKINS**

PROJECT:  
**CITY OF VENICE  
DOWNTOWN ROADWAY  
CORRIDOR IMPROVEMENTS**



DESCRIPTION:  
**MIAMI AVE.  
& NASSAU ST.  
INTERSECTION PLAN**

APPROVED BY:  
**JOHN SALATINO, P.E.  
P.E. LICENSE NUMBER 60921  
ATKINS NORTH AMERICA (CERT. OF AUTH. NO. 24)  
4030 WEST BOY SCOUT BOULEVARD, SUITE 700  
TAMPA, FL 33607-1712**

DATE: 2/28/2018  
PROJECT NO.: 100054389  
SHEET: 47

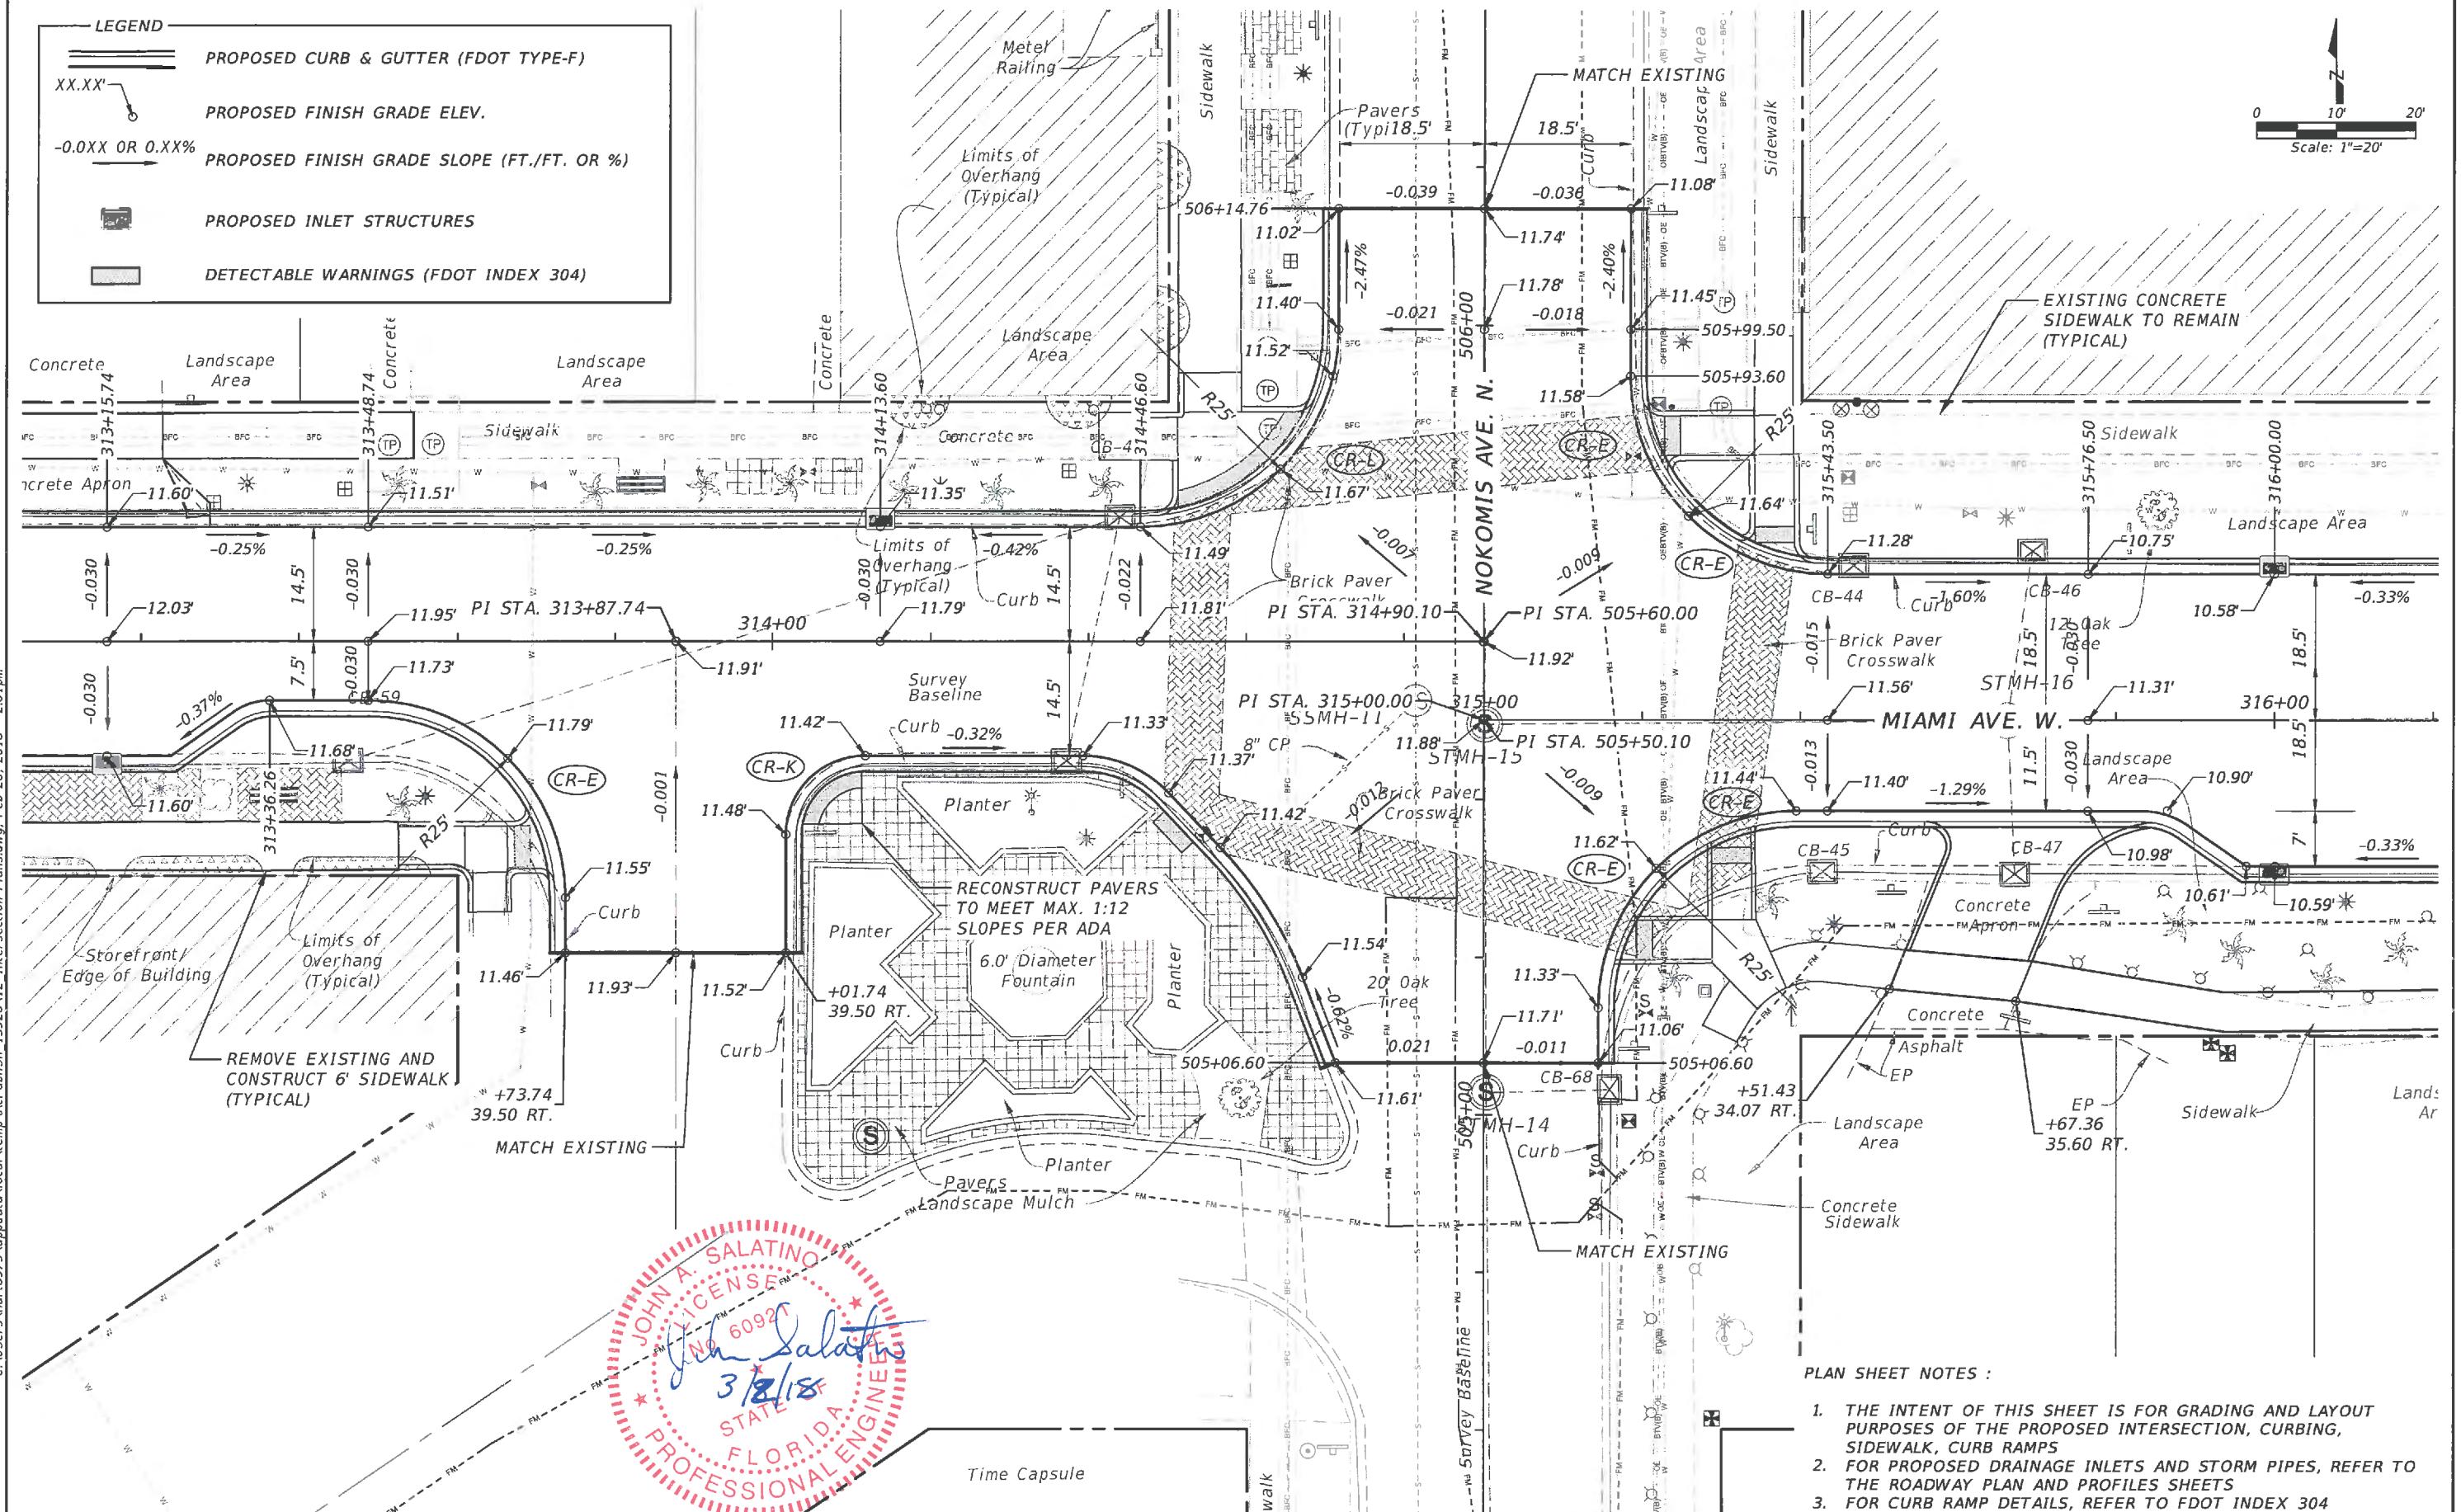

PREPARED FOR:	PREPARED BY:	PROJECT:	DESCRIPTION:	APPROVED BY:	DATE:
DESIGNED MLM	DRAWN MA	ATKINS	CITY OF VENICE DOWNTOWN ROADWAY CORRIDOR IMPROVEMENTS	JOHN SALATINO, P.E. P.E. LICENSE NUMBER 60921 ATKINS NORTH AMERICA (CERT. OF AUTH. NO. 24) 4030 WEST BOY SCOUT BOULEVARD, SUITE 700 TAMPA, FL 33607-1712	2/28/2018
Page 937 of 1140	DRAWN MA	PROJECT NO.: 100054389	DESCRIPTION: MIAMI AVE. & NOKOMIS AVE. INTERSECTION PLAN	SHEET: 48	REV. NO.: DATE DESCRIPTION

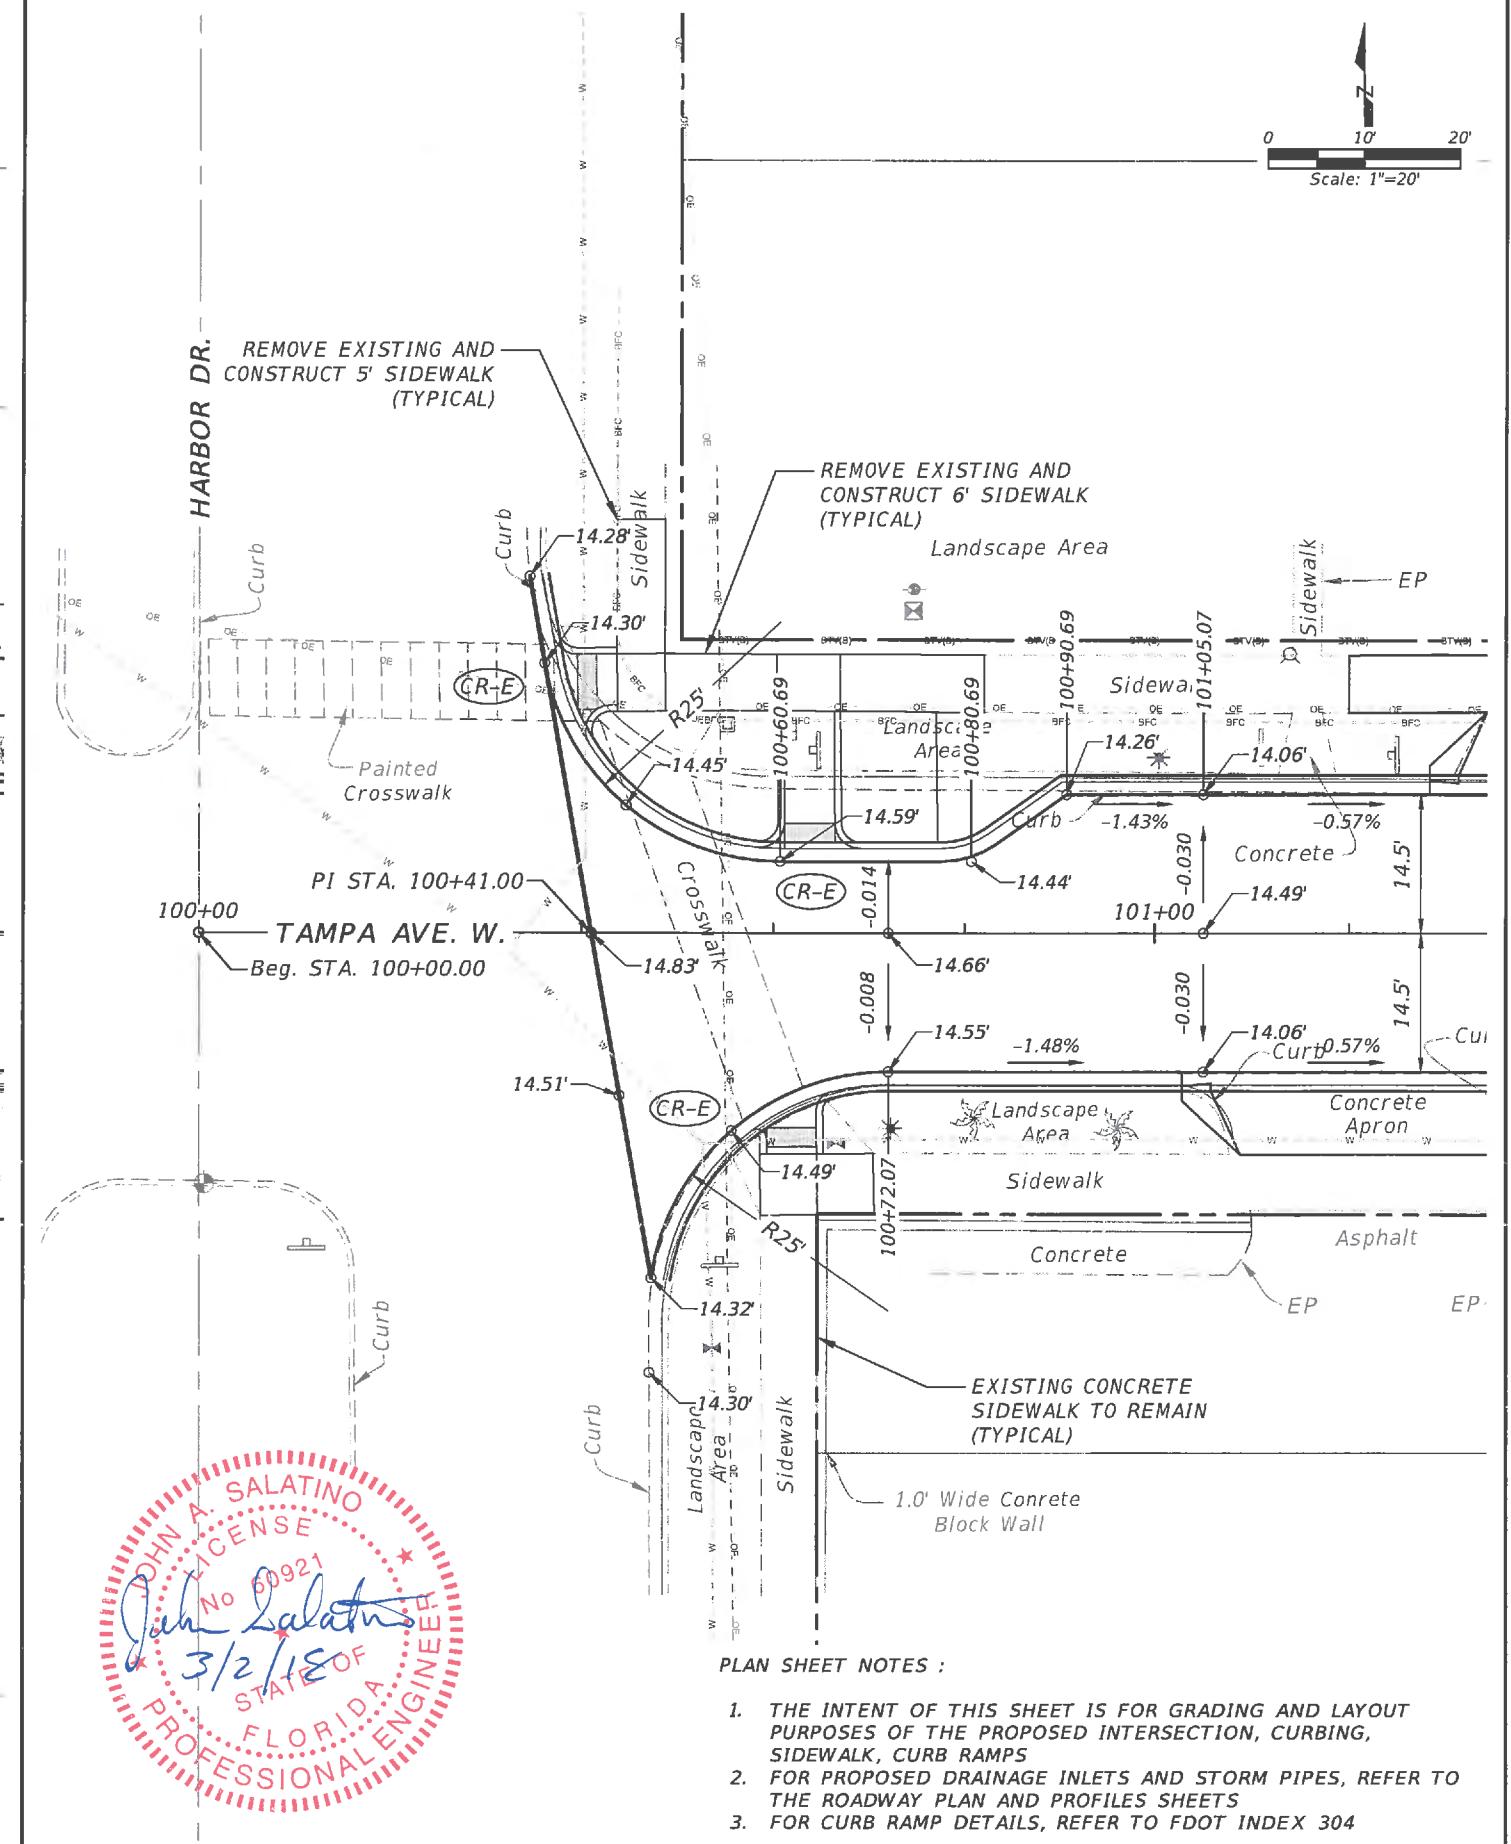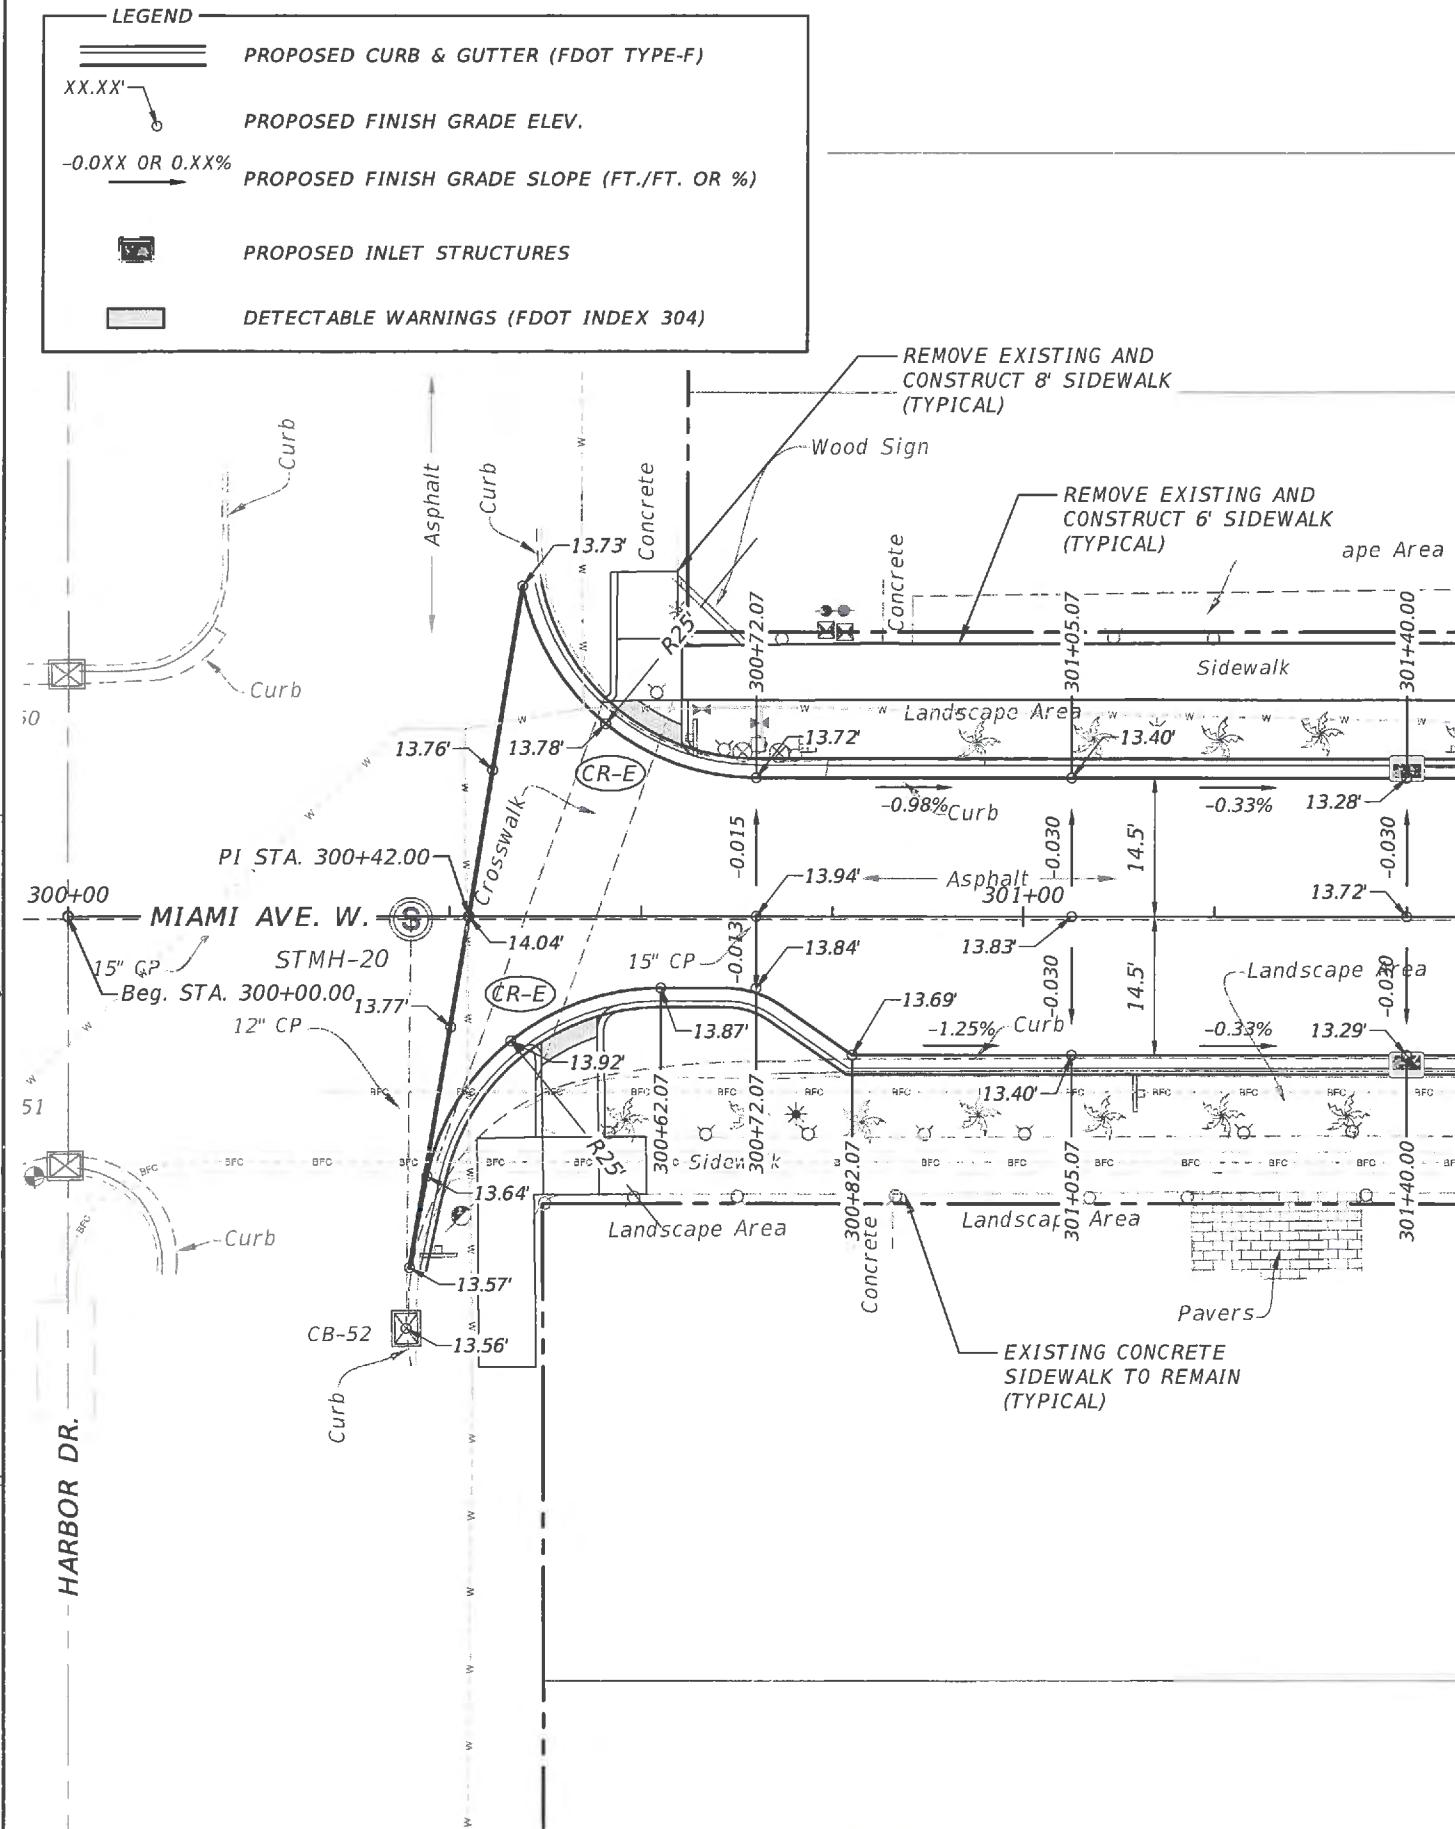


PREPARED FOR:	PREPARED BY:	PROJECT:	DESCRIPTION:	APPROVED BY:	DATE:
DESIGNED MLM DRAWN MA CHECKED MLM	PREPARED FOR: <b>Venice, FL</b> City on the Gulf	PREPARED BY: <b>ATKINS</b>	PROJECT: <b>CITY OF VENICE DOWNTOWN ROADWAY CORRIDOR IMPROVEMENTS</b>	DESCRIPTION: <b>TAMPA AVE. / MIAMI AVE. &amp; HARBOR DR. INTERSECTION PLAN</b>	APPROVED BY: JOHN SALATINO, P.E. P.E. LICENSE NUMBER 60921 ATKINS NORTH AMERICA (CERT. OF AUTH. NO. 24) 4030 WEST BOY SCOUT BOULEVARD, SUITE 700 TAMPA, FL 33607-1712
Page 938 of 1140	DRAWN MA	DATE	DATE	DATE	2/28/2018 PROJECT NO.: 100054389 SHEET: 49

DRIVEWAY PROFILES				
	CENTERLINE STATION	SIDE	APPLICATION	DRIVEWAY WIDTH
TAMPA AVE.	101+24.60	RT.	G-5	31.47'
	101+43.30	LT.	G-5	17.59'
	101+95.61	LT.	G-5	17.72'
	102+63.98	LT.	G-5	29.35'
	103+14.75	RT.	G-5	49.23'
	103+91.57	RT.	G-4	43.43'
	105+33.80	RT.	G-4	30.59'
	105+57.54	LT.	G-5	24.34'
	109+78.67	LT.	G-5	26.00'
	114+10.67	RT.	G-4	25.00'
VENICE AVE.	117+03.00	RT.	G-8	19.00'
	204+92.71	LT.	G-4	17.60'
	214+11.39	LT.	G-4	24.00'
	216+24.07	RT.	G-4	14.18'
MIAMI AVE.	217+69.33	LT.	G-4	23.34'
	301+74.66	LT.	G-4	24.00'
	301+96.47	RT.	G-5	13.25'
	302+71.99	RT.	G-5	14.30'
	303+39.62	RT.	G-5	12.00'
	303+96.64	RT.	G-5	15.00'
	306+48.39	RT.	G-5	14.00'
	308+02.07	RT.	G-5	19.50'
	309+23.96	LT.	G-5	28.10'
	309+75.27	LT.	G-5	15.20'
	310+45.00	LT.	G-5	18.81'
	311+08.36	LT.	G-5	22.13'
	312+55.11	LT.	G-5	19.28'
	313+10.68	LT.	G-5	24.00'
NASSAU ST.	315+59.40	RT.	G-8	16.22'
	317+09.79	LT.	G-8	20.20'
	405+16.47	RT.	G-5	24.32'
	405+16.59	LT.	G-4	24.43'
	408+85.22	RT.	G-4	24.00'

NOTE: DRIVEWAY APPLICATIONS ARE APPROXIMATE AND BASED ON EXISTING CONDITIONS


## DRIVEWAY NOTES:

1. FOR ADDITIONAL CONSTRUCTION DETAILS, REFER TO FDOT INDEX 515.
2. REFER TO SECTION 522 OF THE FDOT STANDARD SPECIFICATIONS FOR CONSTRUCTION REQUIREMENTS.

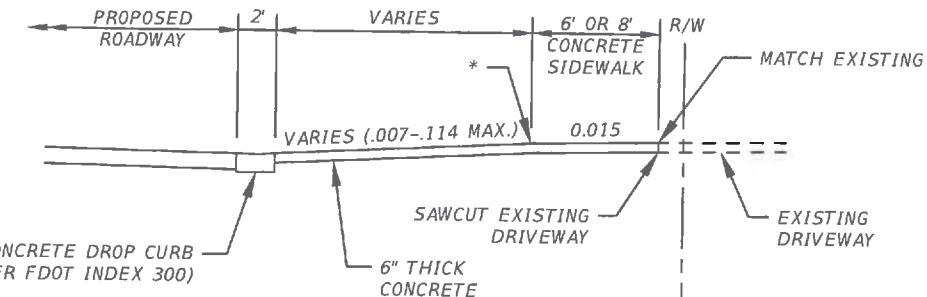


PROFILE VIEW

\* ALTERNATE MATCH POINT WHERE PLANS DO NOT INDICATE CONCRETE SIDEWALK REPLACEMENT

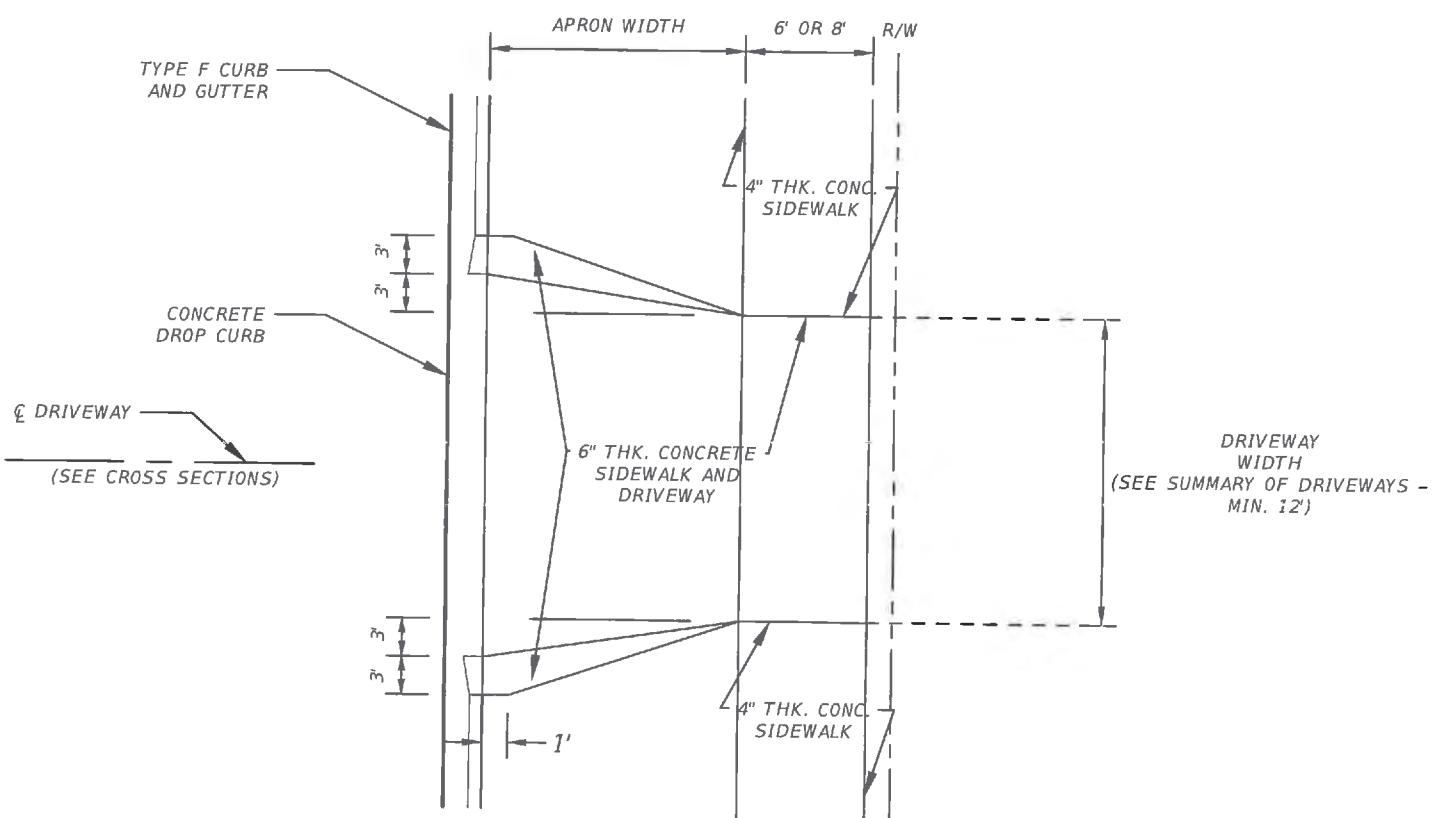




PLAN VIEW

DRIVEWAY DETAIL (N.T.S.)

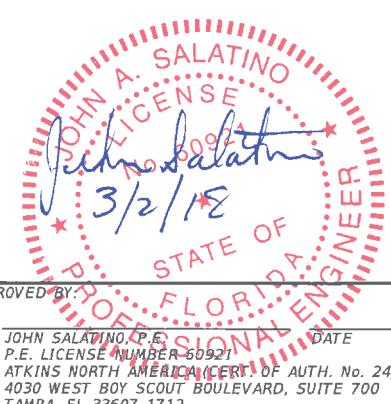

			PREPARED FOR:	PREPARED BY:	PROJECT:	DESCRIPTION:	APPROVED BY:		DATE:
			DESIGNED MLM	DRAWN MA	ATKINS	CITY OF VENICE DOWNTOWN ROADWAY CORRIDOR IMPROVEMENTS	JOHN SALATINO, P.E.	P.E. LICENSE NUMBER 60921	2/28/2018
			DRAWN MA	CHECKED MLM		Special Details		ATKINS NORTH AMERICA (CERT. OF AUTH. NO. 24)	PROJECT NO.: 100054389
Page 939 of 1140	REV. NO.	DATE	DESCRIPTION					TAMPA, FL 33607-1712	SHEET: 50

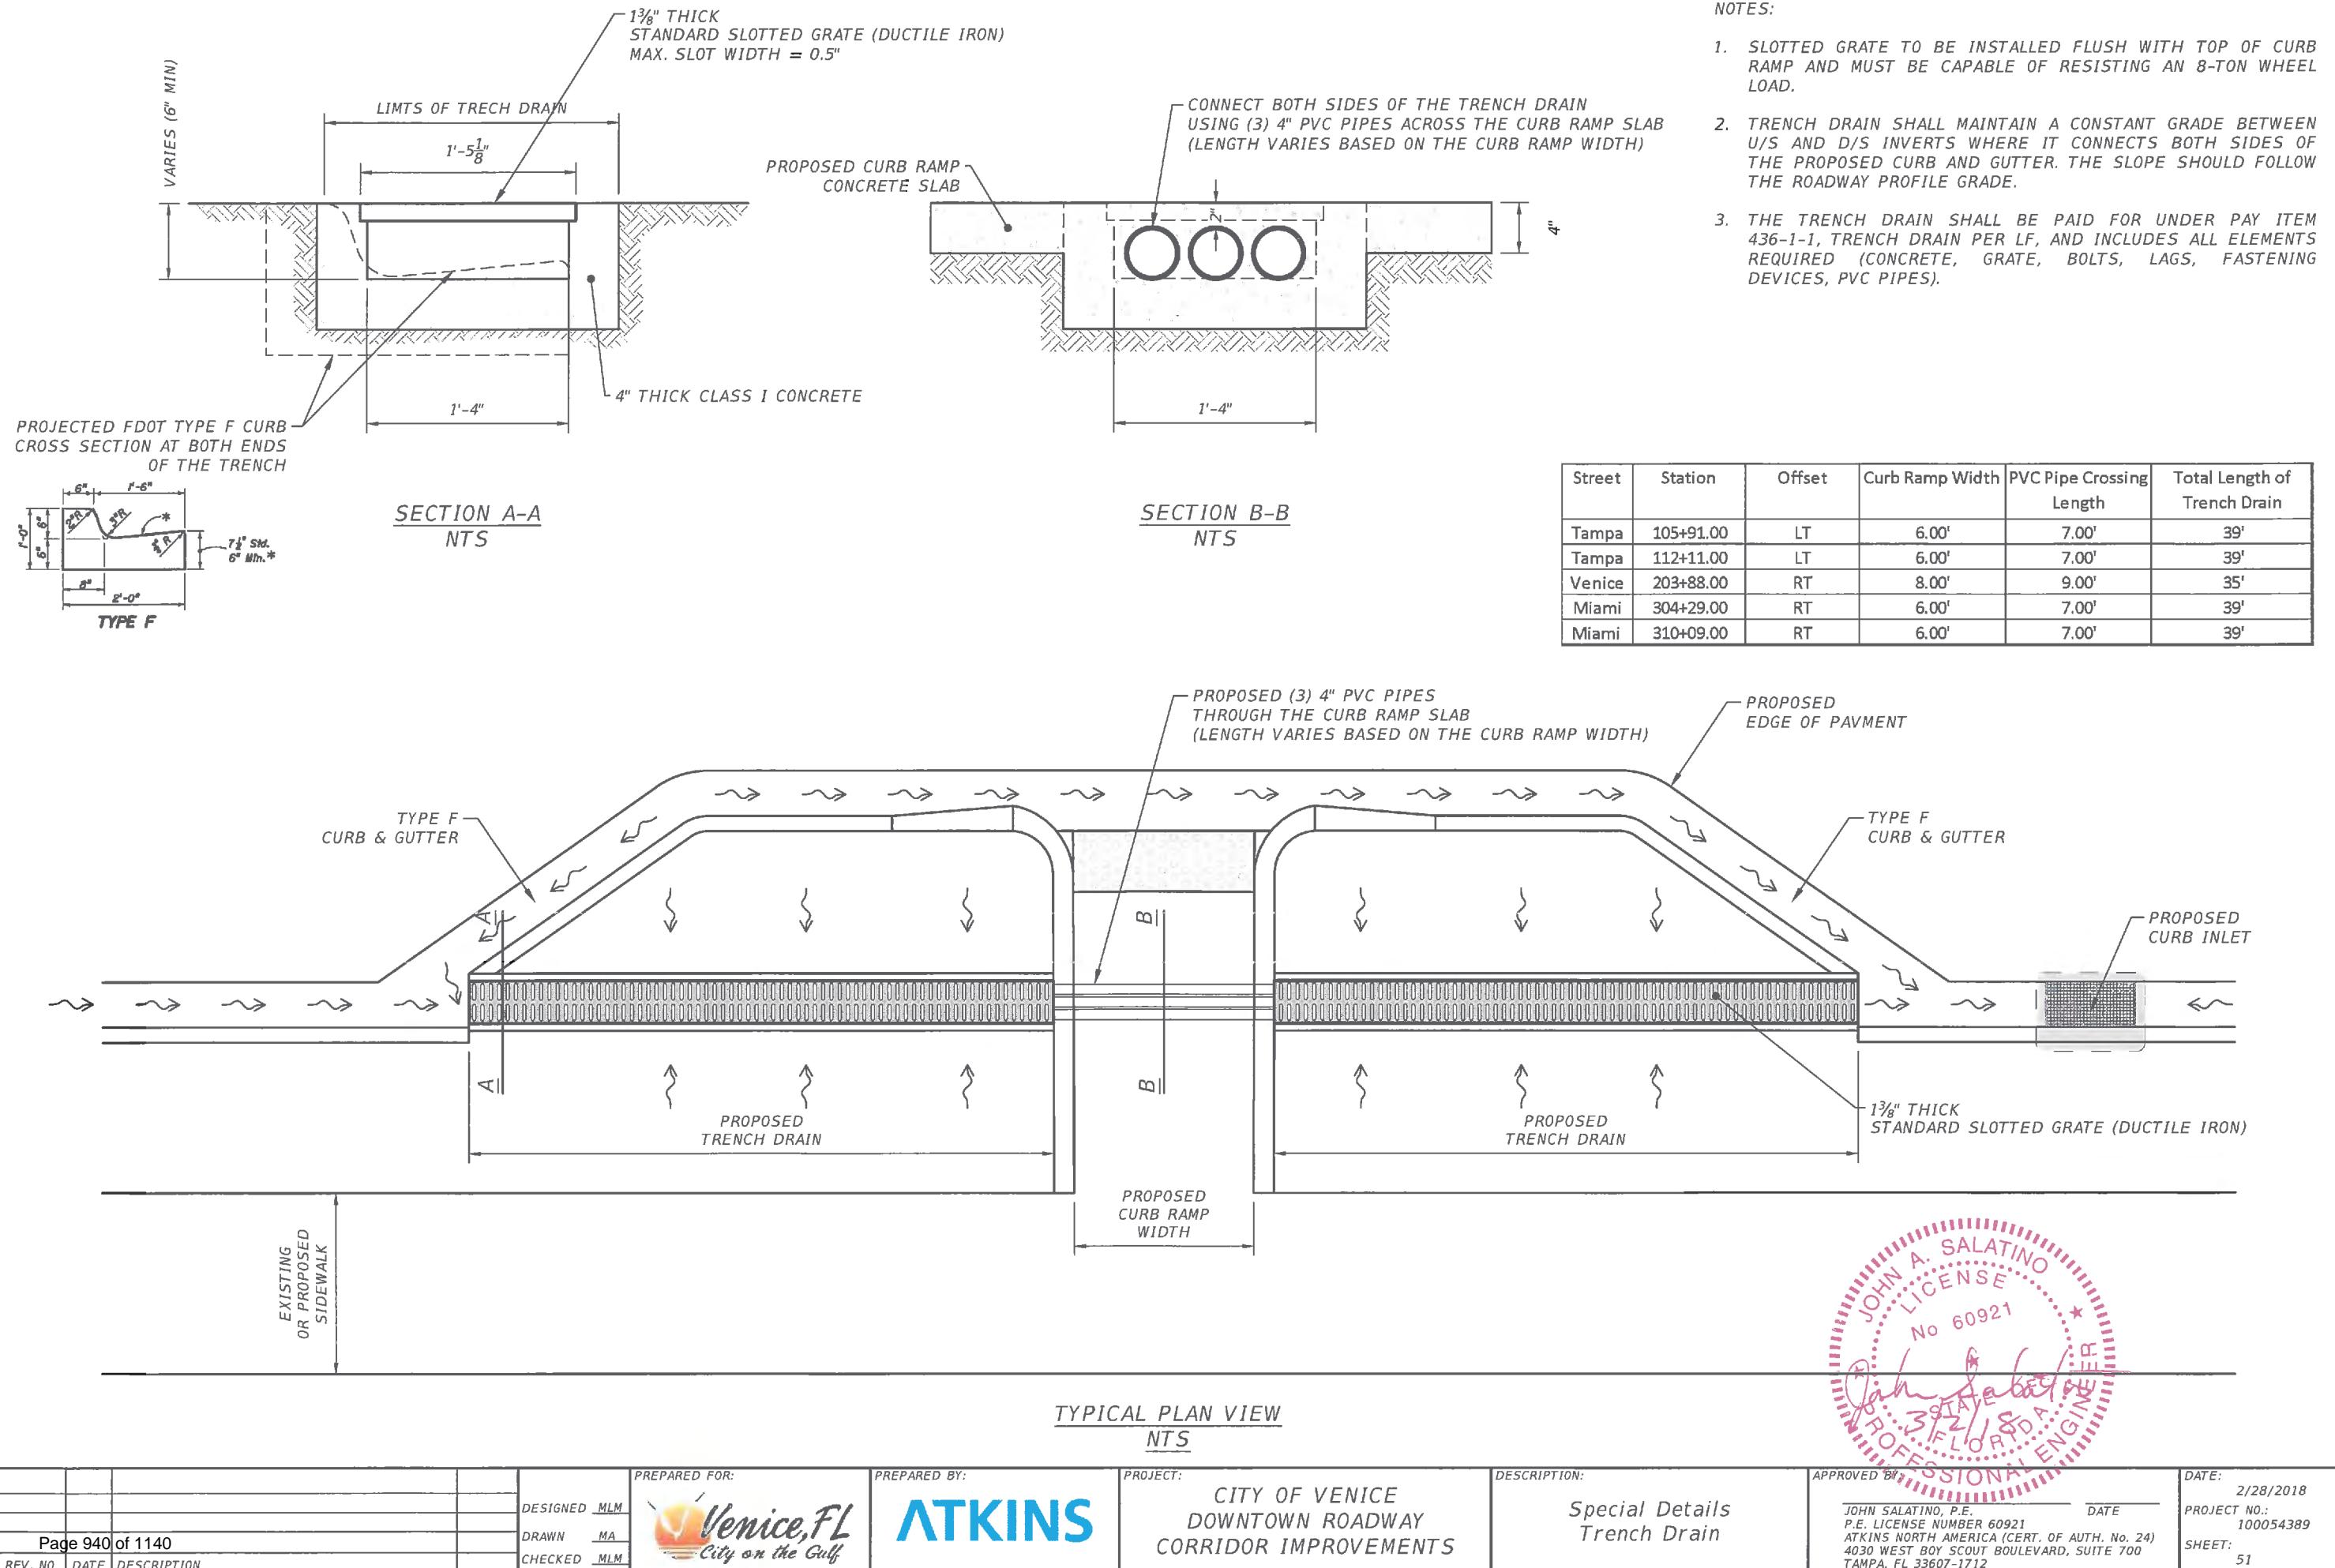

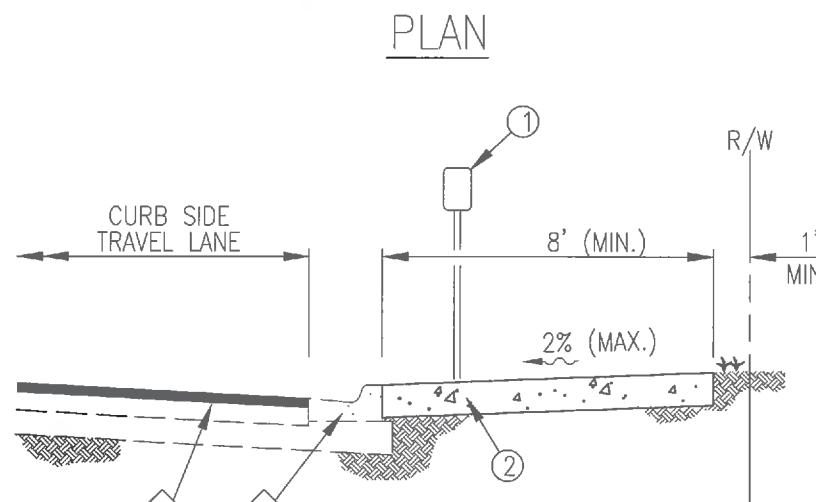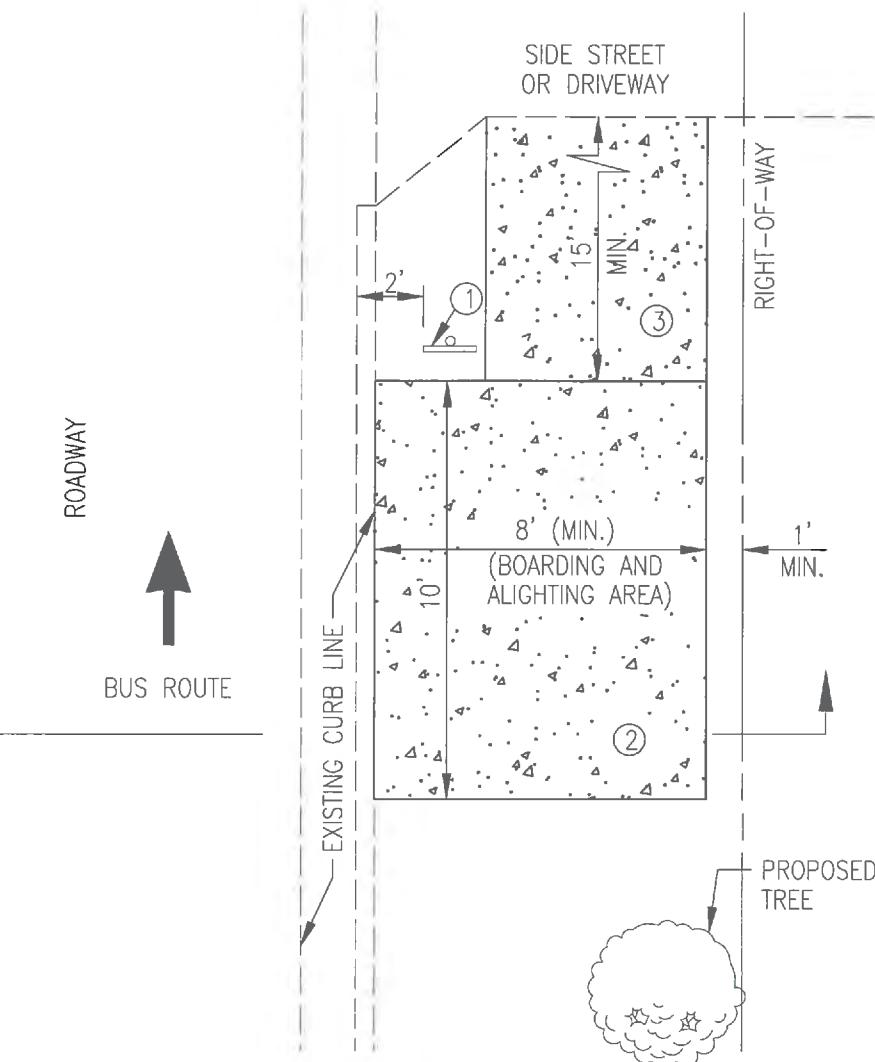SECTIONLEGEND

SCAT = SARASOTA COUNTY AREA TRANSIT  
 MUTCD = MANUAL ON UNIFORM TRAFFIC CONTROL DEVICES  
 FDOT = FLORIDA DEPARTMENT OF TRANSPORTATION

EXISTING FEATURES:

- ① ROADWAY PAVEMENT
- ② TYPES "E" OR "F" CURB AND GUTTER
- ③ CONCRETE SIDEWALK (4" THICK)

PROPOSED FACILITIES:

- ① SCAT TRANSIT SIGN
- ② CONCRETE BOARDING AND ALIGHTING AREA (6" THICK)
- ③ CONCRETE SIDEWALK (4" THICK)

MATERIALS:


1. All concrete shall be 3,000 psi concrete for non-structural pads.

DESIGN NOTES:


1. Boarding and alighting areas shall be designed in accordance with applicable ADA Standards and the FDOT Plans Preparation Manual, Volume I, Chapter 8, and Florida Administrative Code, Rule 14-20 Private Use of Right of Way.
2. Should another type of curb and gutter exist along the transit stop frontage, the curb and gutter shall be replaced with type "E" or "F" curb and gutter along the entire boarding and alighting area frontage with 3' curb transitions provided beyond the boarding and alighting area limits.
3. Street trees are desired adjacent to new facility construction and optional with facility retrofits. Contact the Sarasota County Forestry Division for tree type selection and placement guidelines.
4. Should an unavoidable constraint hinder the desired ten (10) foot width, a boarding and alighting area width of less than ten (10) feet may be considered. In no case shall the boarding and alighting area be less than five (5) feet wide.
5. Typical boarding and alighting area cross slopes shall not exceed 2%. Should adjacent existing sidewalk cross slope exceed 2%, a short segment of existing concrete sidewalk shall be removed and reconstructed to transition the boarding and alighting area back into the existing sidewalk. The length of existing sidewalk removal shall be determined based on the transition meeting all applicable ADA Standards for longitudinal slopes.
6. All transit stop facilities shall be constructed in accordance with the design plans when provided, SCAT Design Standards, Sarasota County Standards Specification 480, manufacturer specifications, and FDOT criteria.
7. Sidewalk connections to the closest side street/driveway or existing sidewalk shall be incorporated into the design plans.

PAY ITEM NOTES:

1. The boarding and alighting area concrete is to be paid for under pay item 522-2 concrete sidewalk and driveways (6" thickness) per SY.


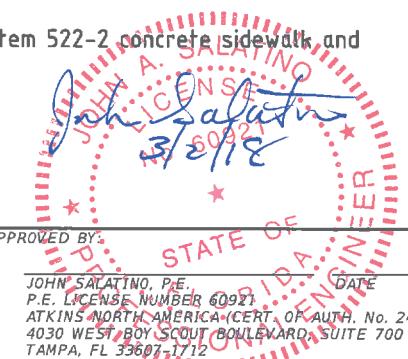


DESIGNED	PREPARED FOR:	PREPARED BY:	PROJECT:	DESCRIPTION:	APPROVED BY:	DATE:
MLM	Venice, FL City on the Gulf	ATKINS	CITY OF VENICE DOWNTOWN ROADWAY CORRIDOR IMPROVEMENTS	Special Details SCAT Bus Pad	JOHN A. SALATINO, P.E. P.E. LICENSE NUMBER 60921 ATKINS NORTH AMERICA (CERT. OF AUTH. NO. 24) 4030 WEST BOY SCOUT BOULEVARD, SUITE 700 TAMPA, FL 33607-1712	2/28/2018
DRAWN	MA					PROJECT NO.: 100054389
CHECKED	MLM					SHEET: 52

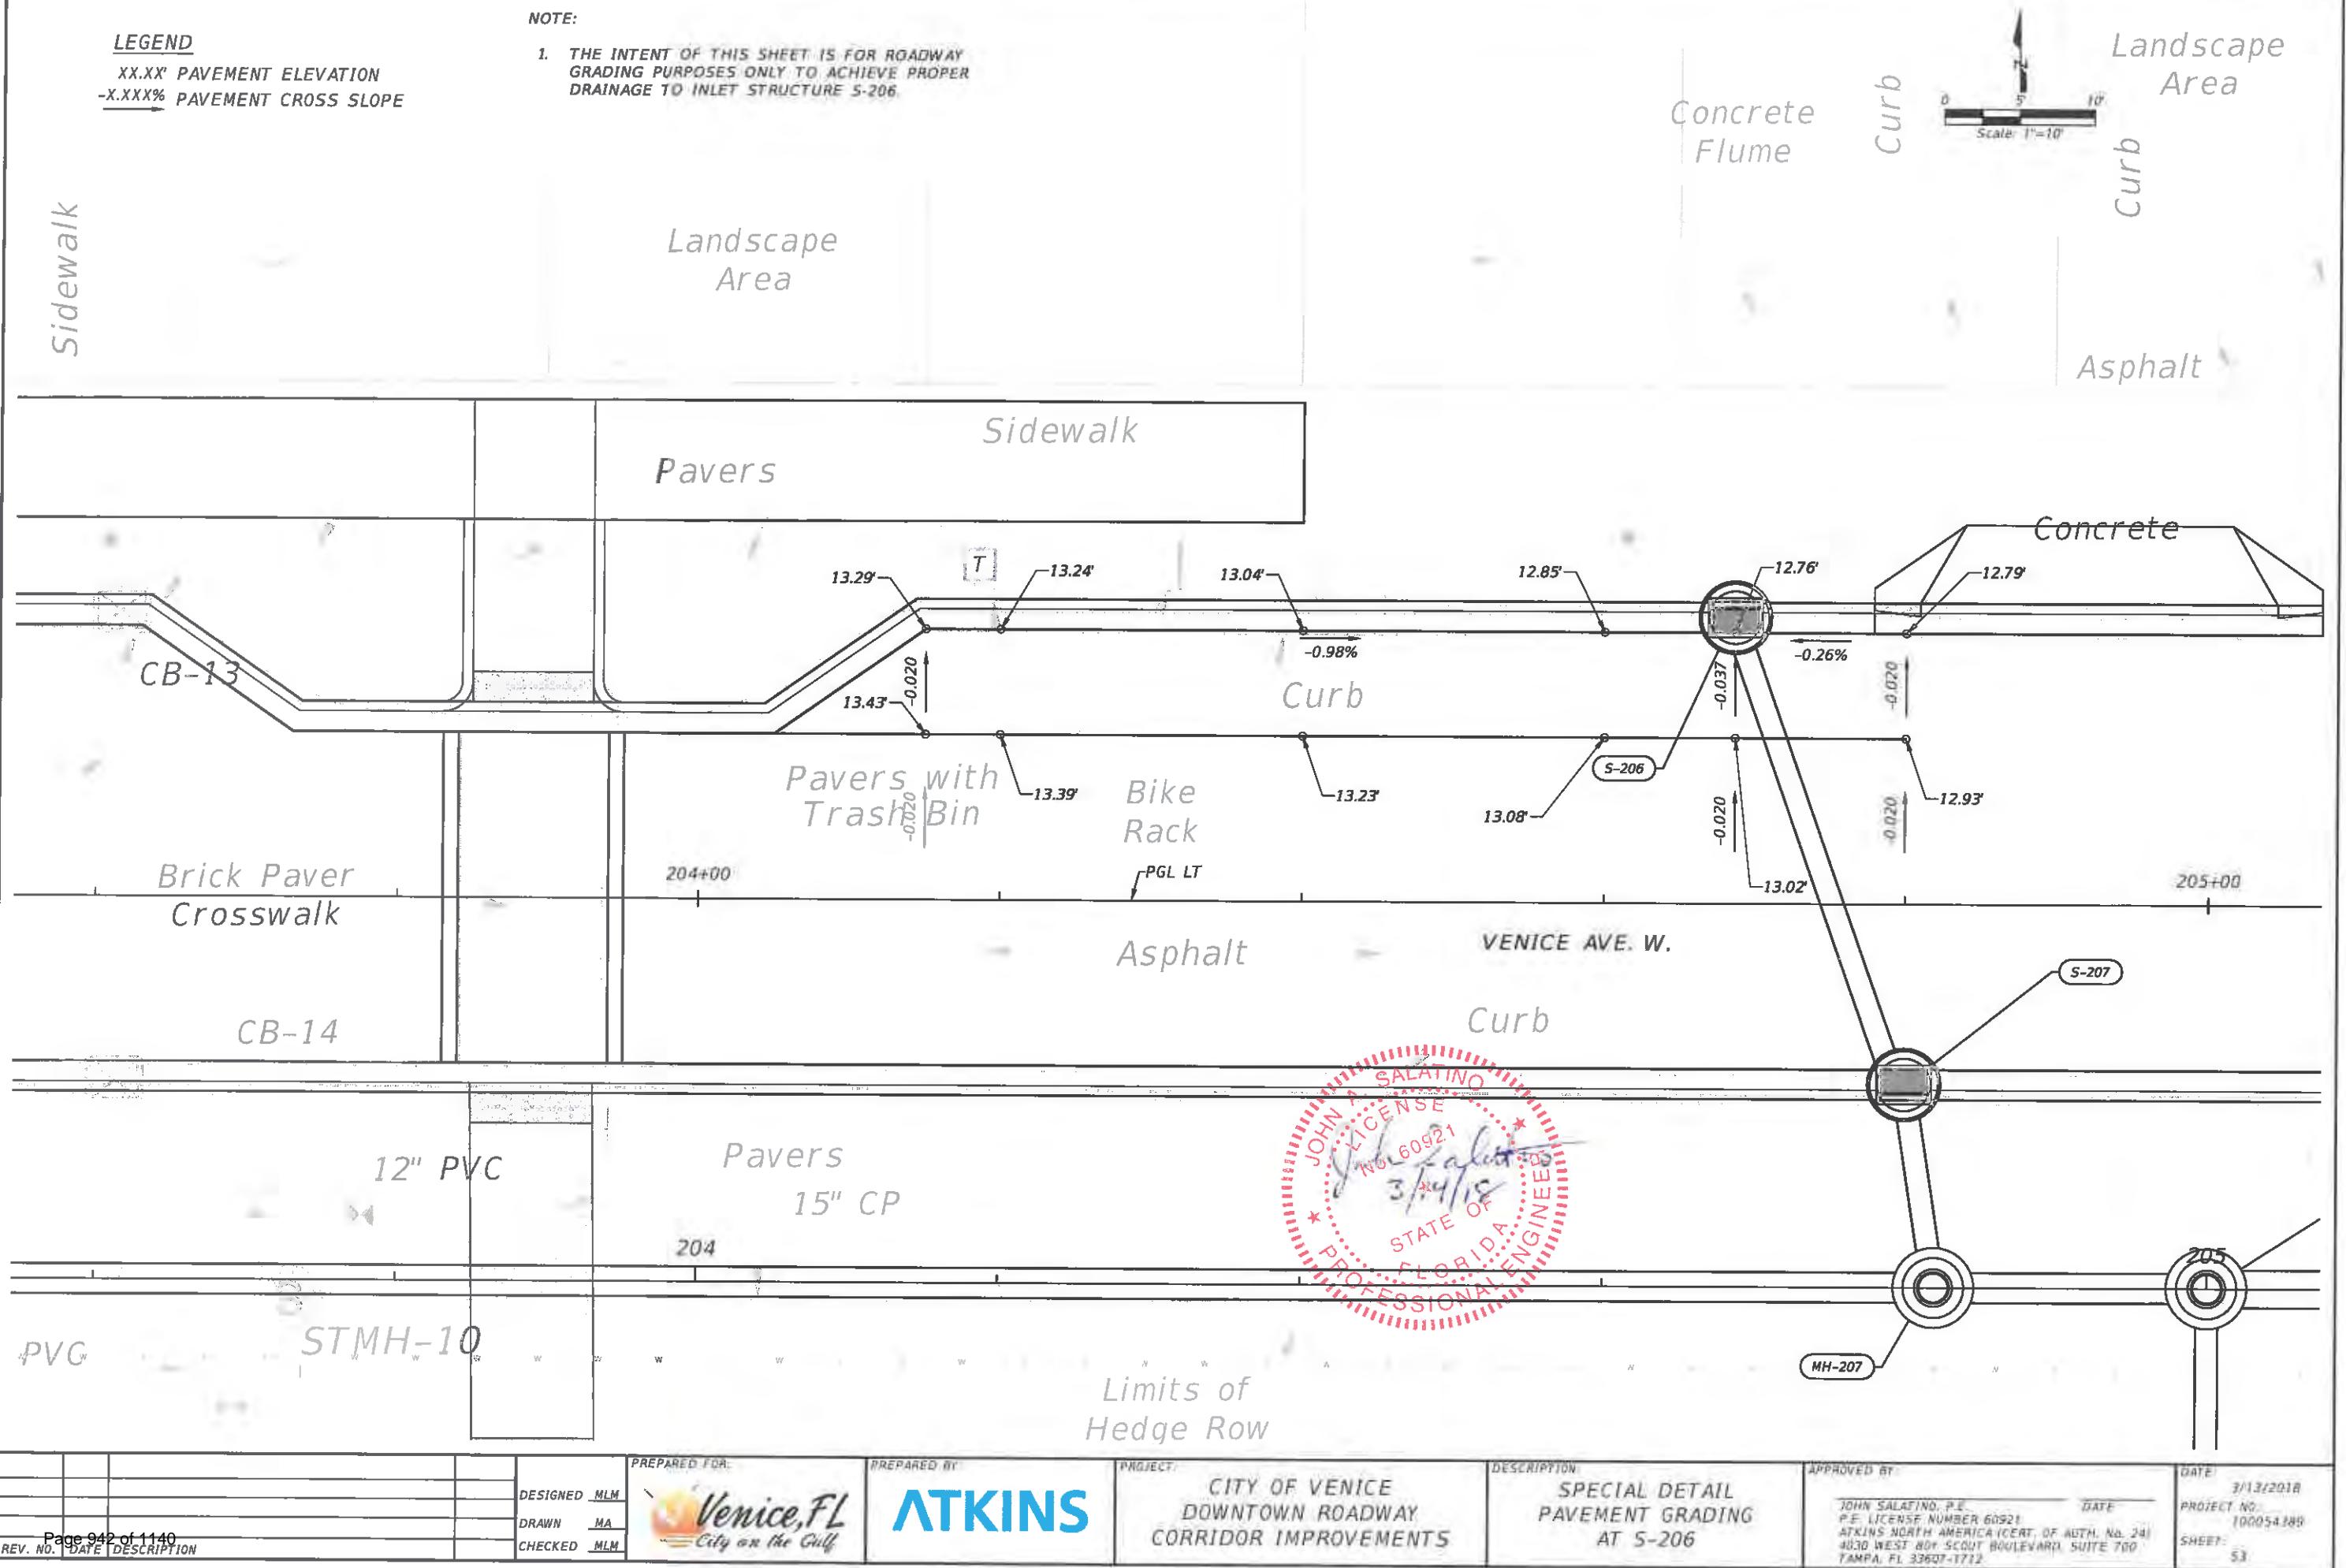


## R-3262-3 DIMENSIONS:

A = 5"  
B = 0.5"  
C = 4"  
C-C = 5.5"  
E = 6"  
E-E = 6.5"  
F = 6.5"  
T = 1"

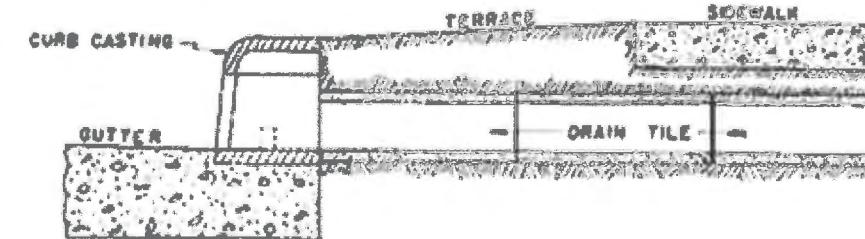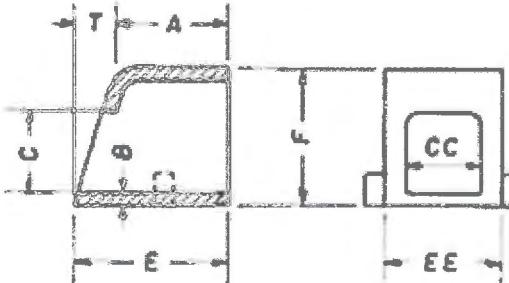

## NOTES:


1. THIS PRODUCT IS A HEAVY DUTY CAST IRON CURB OPENING, PRODUCED BY NEENAH FOUNDRY (NEENAH ENTERPRISES, INC.).
2. ALL EXISTING ROOF DRAINS ARE DENOTED IN THE PLAN SHEETS, AND ARE TO BE CONNECTED TO R-3262-3 CURB OPENINGS, OR EQUIVALENT, WHERE CURB IS TO BE REPLACED.
3. THE COMPLETE SYSTEM (COUPLINGS, PVC PIPE, CAST IRON CURB OPENING, ETC.) AND INSTALLATION NECESSARY TO CONNECT THE EXISTING ROOF DRAINS TO THE PROPOSED CURBS, IS INCLUDED IN PAY ITEM 999-1, ROOF DRAINS PER EACH.

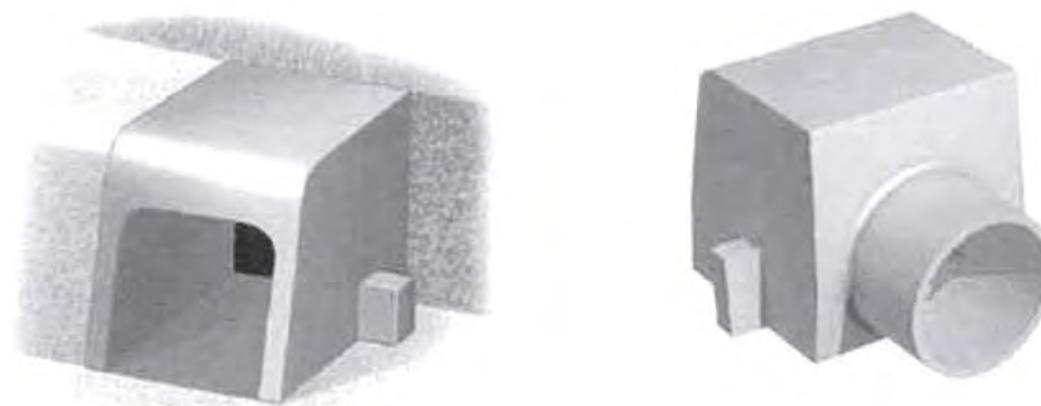

SOURCE: NEENAH ENTERPRISES, INC.

Rear view of R-3262-3 only.  
(optional)


N.T.S

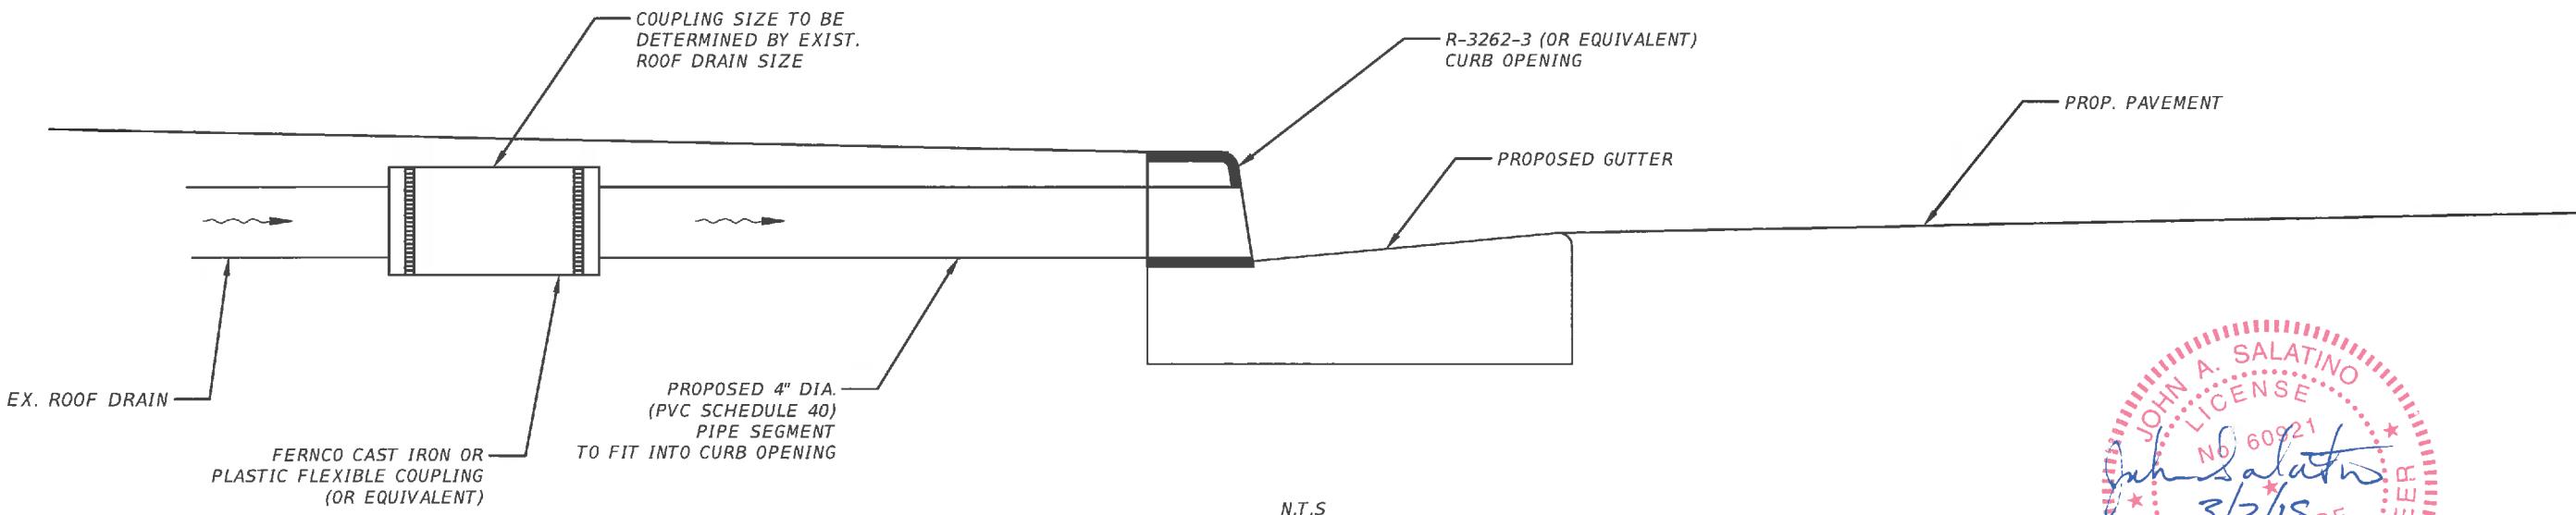


				PREPARED FOR:	PREPARED BY:	PROJECT:	DESCRIPTION:	APPROVED BY:	
				DESIGNED MLM	DRAWN MA	CHECKED MLM	ATKINS	CITY OF VENICE	SPECIAL DETAIL
Page 943	of 1140			Venice, FL City on the Gulf				DOWNTOWN ROADWAY	ROOF DRAIN AND INLET
REV. NO.	DATE	DESCRIPTION						CORRIDOR IMPROVEMENTS	OPENING

JOHN SALATINO, P.E.  
P.E. LICENSE NUMBER 60921  
ATKINS NORTH AMERICA (CERT. OF AUTH. NO. 24)  
4030 WEST BOY SCOUT BOULEVARD, SUITE 700  
TAMPA, FL 33607-1712


DATE: 2/28/2018  
PROJECT NO.: 100054389  
SHEET: 54

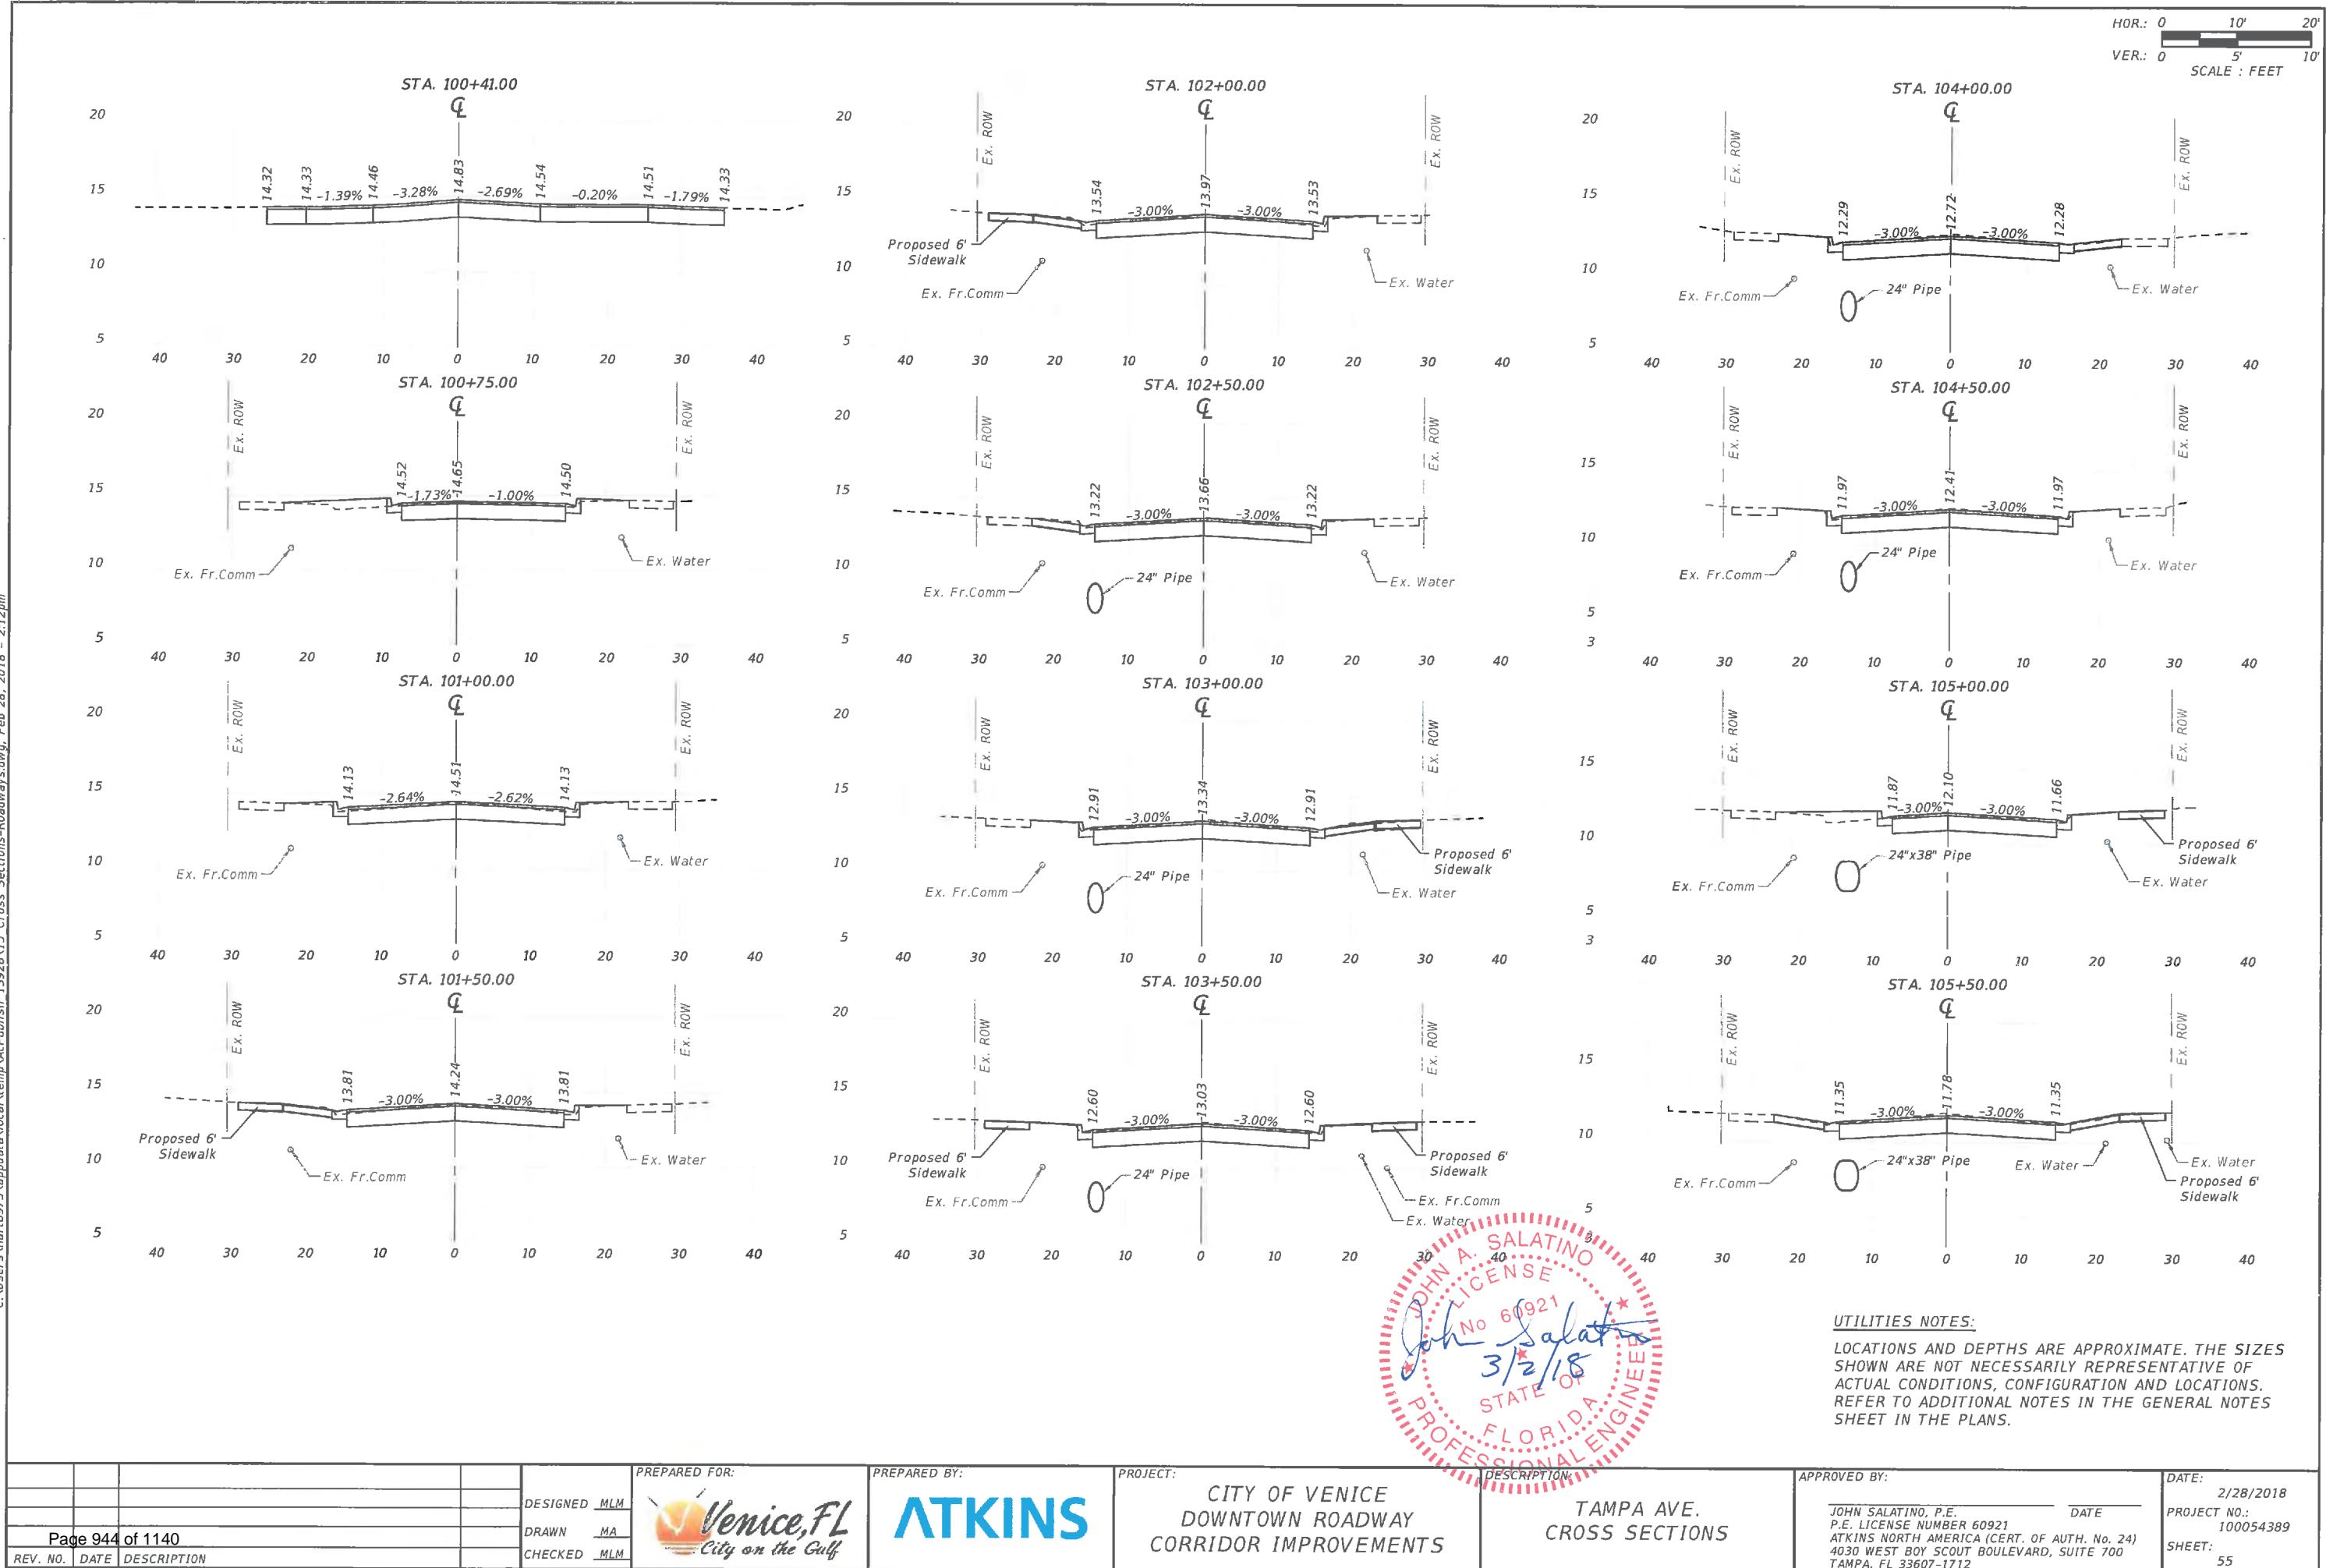

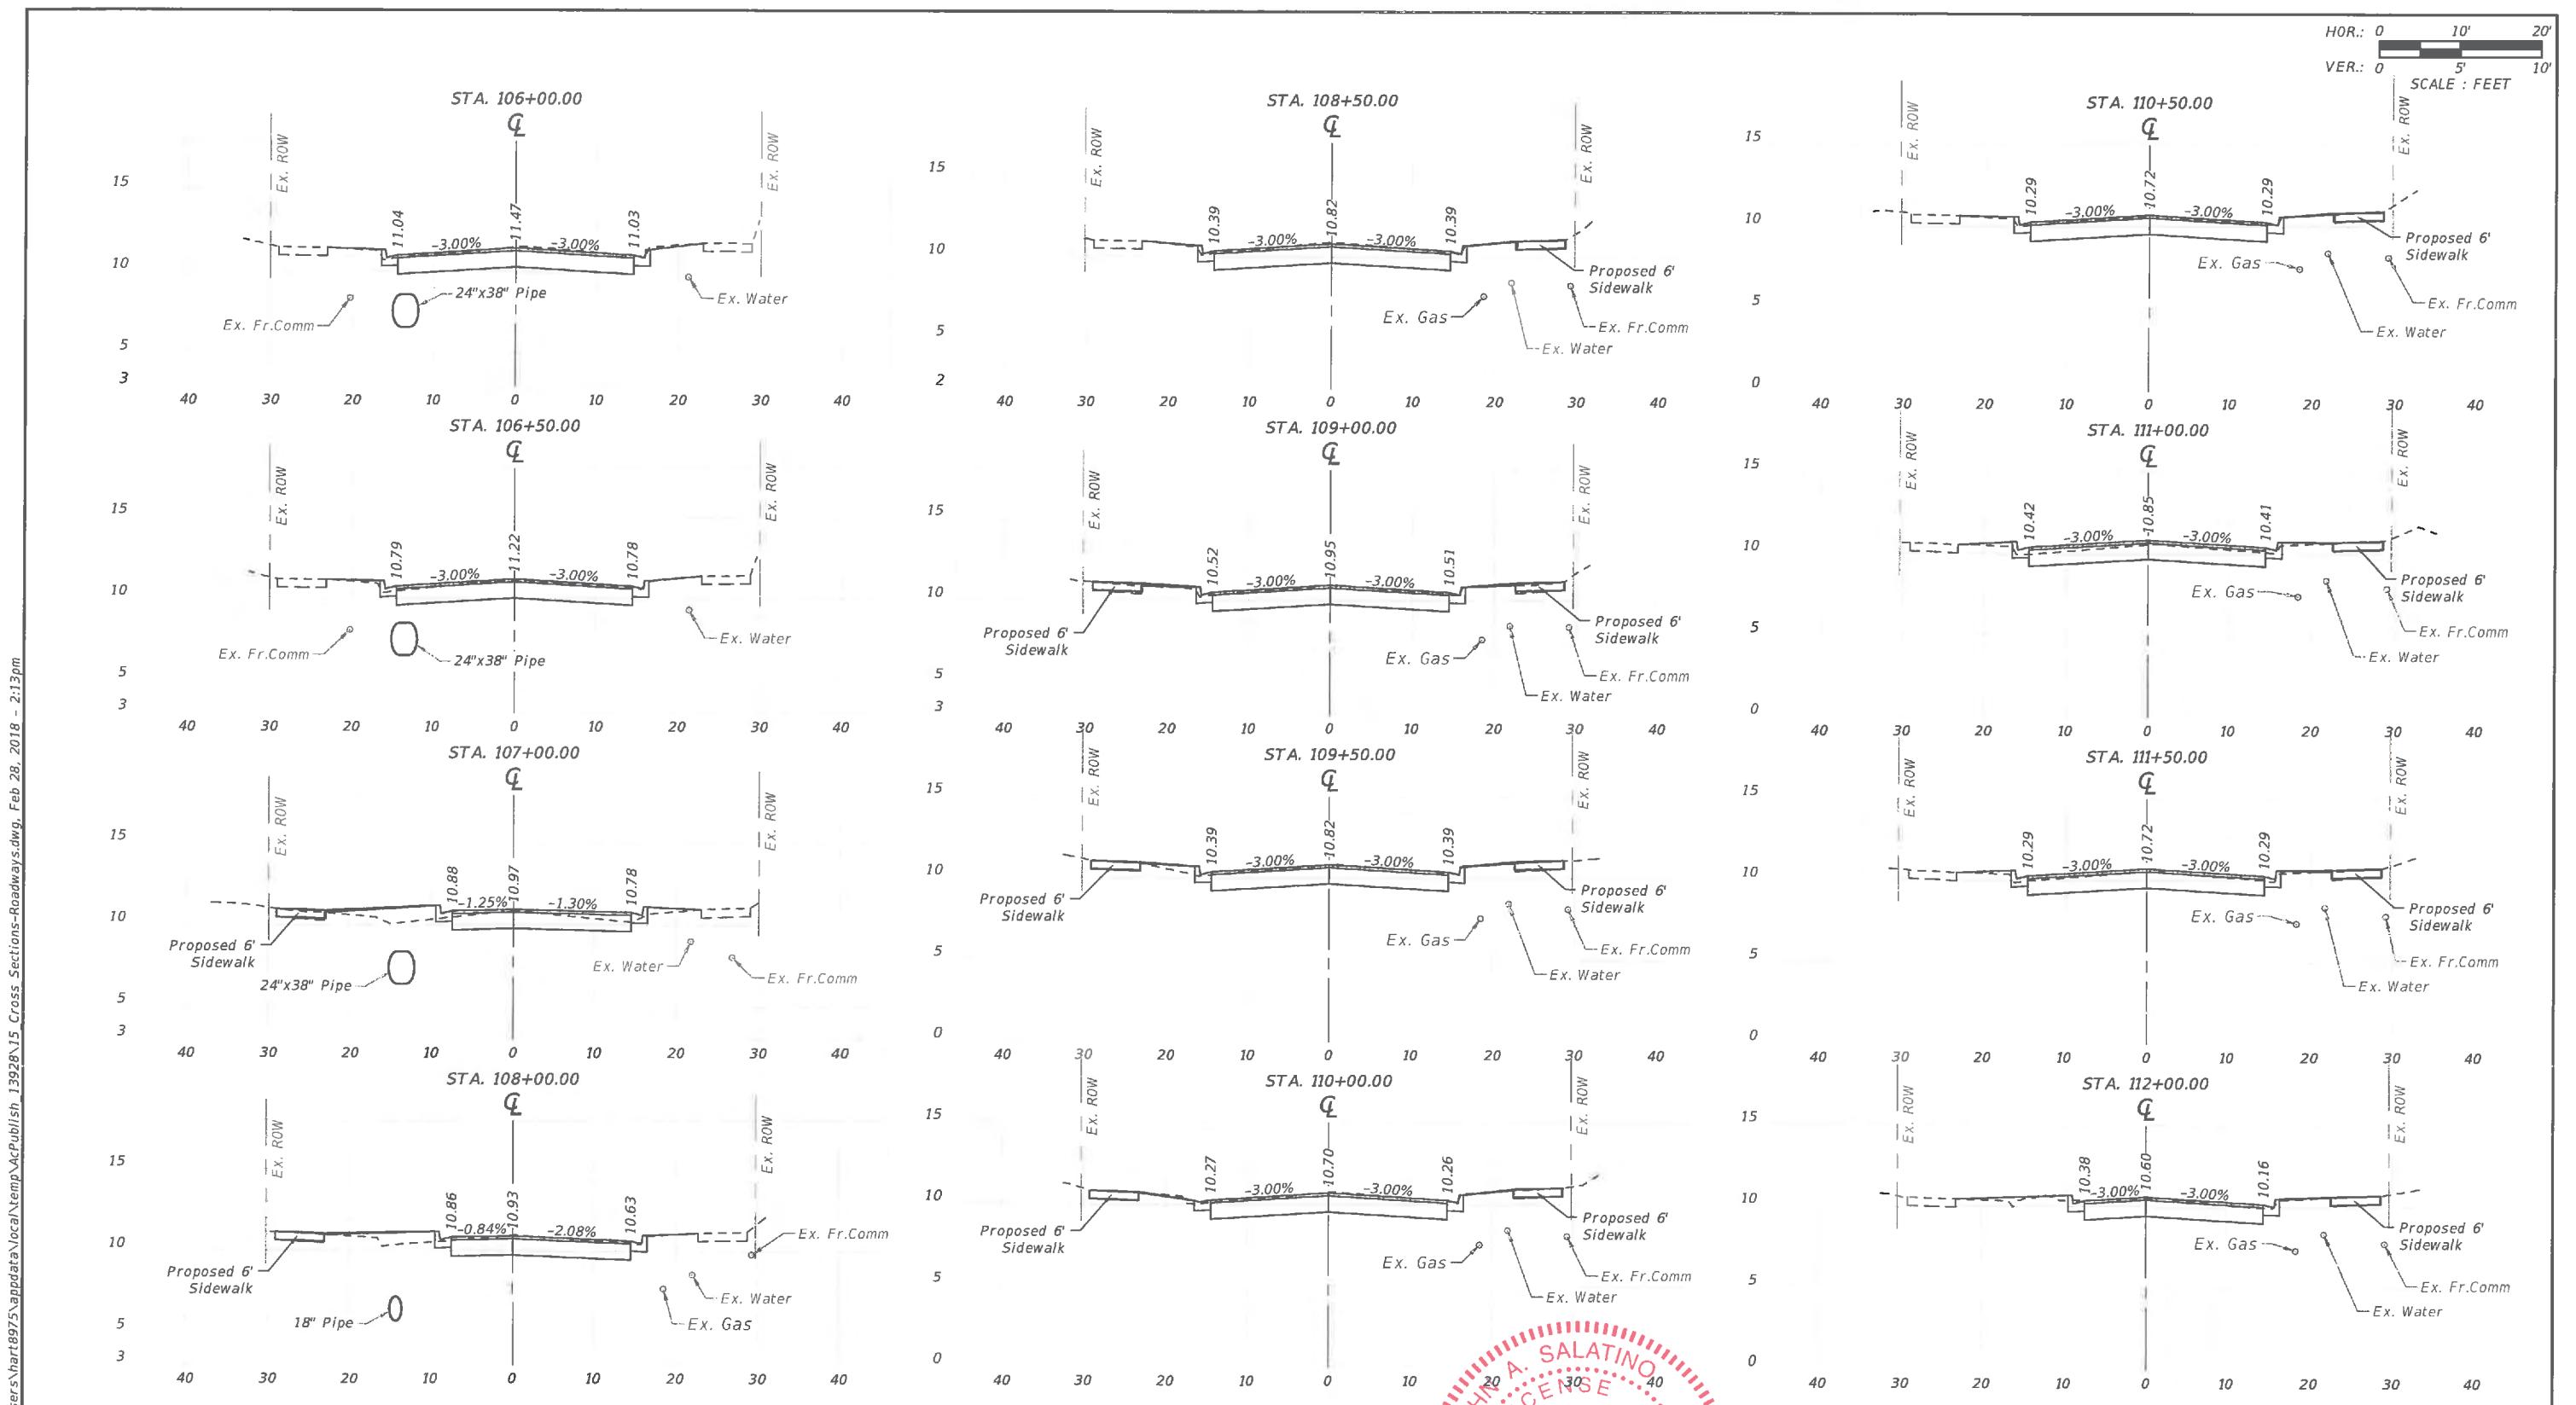


#### UTILITIES NOTES:

LOCATIONS AND DEPTHS ARE APPROXIMATE. THE SIZES SHOWN ARE NOT NECESSARILY REPRESENTATIVE OF ACTUAL CONDITIONS, CONFIGURATION AND LOCATIONS. REFER TO ADDITIONAL NOTES IN THE GENERAL NOTES SHEET IN THE PLANS.

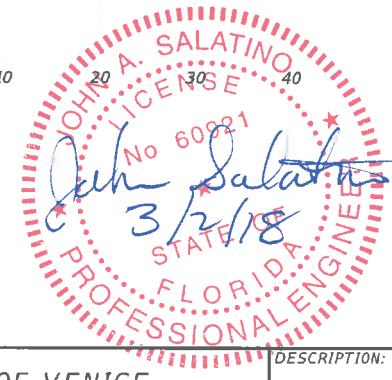



				PREPARED FOR:	PREPARED BY:	PROJECT:	DESCRIPTION:	APPROVED BY:	DATE:
				DESIGNED MLM	DRAWN MA	CITY OF VENICE DOWNTOWN ROADWAY CORRIDOR IMPROVEMENTS	TAMPA AVE. CROSS SECTIONS	JOHN SALATINO, P.E., P.E. LICENSE NUMBER 60921 ATKINS NORTH AMERICA (CERT. OF AUTH. NO. 24) 4030 WEST BOY SCOUT BOULEVARD, SUITE 700 TAMPA, FL 33607-1712	2/28/2018
Page 945 of 1140				ATKINS					PROJECT NO.: 100054389
REV. NO.	DATE	DESCRIPTION	CHECKED MLM					SHEET: 56	

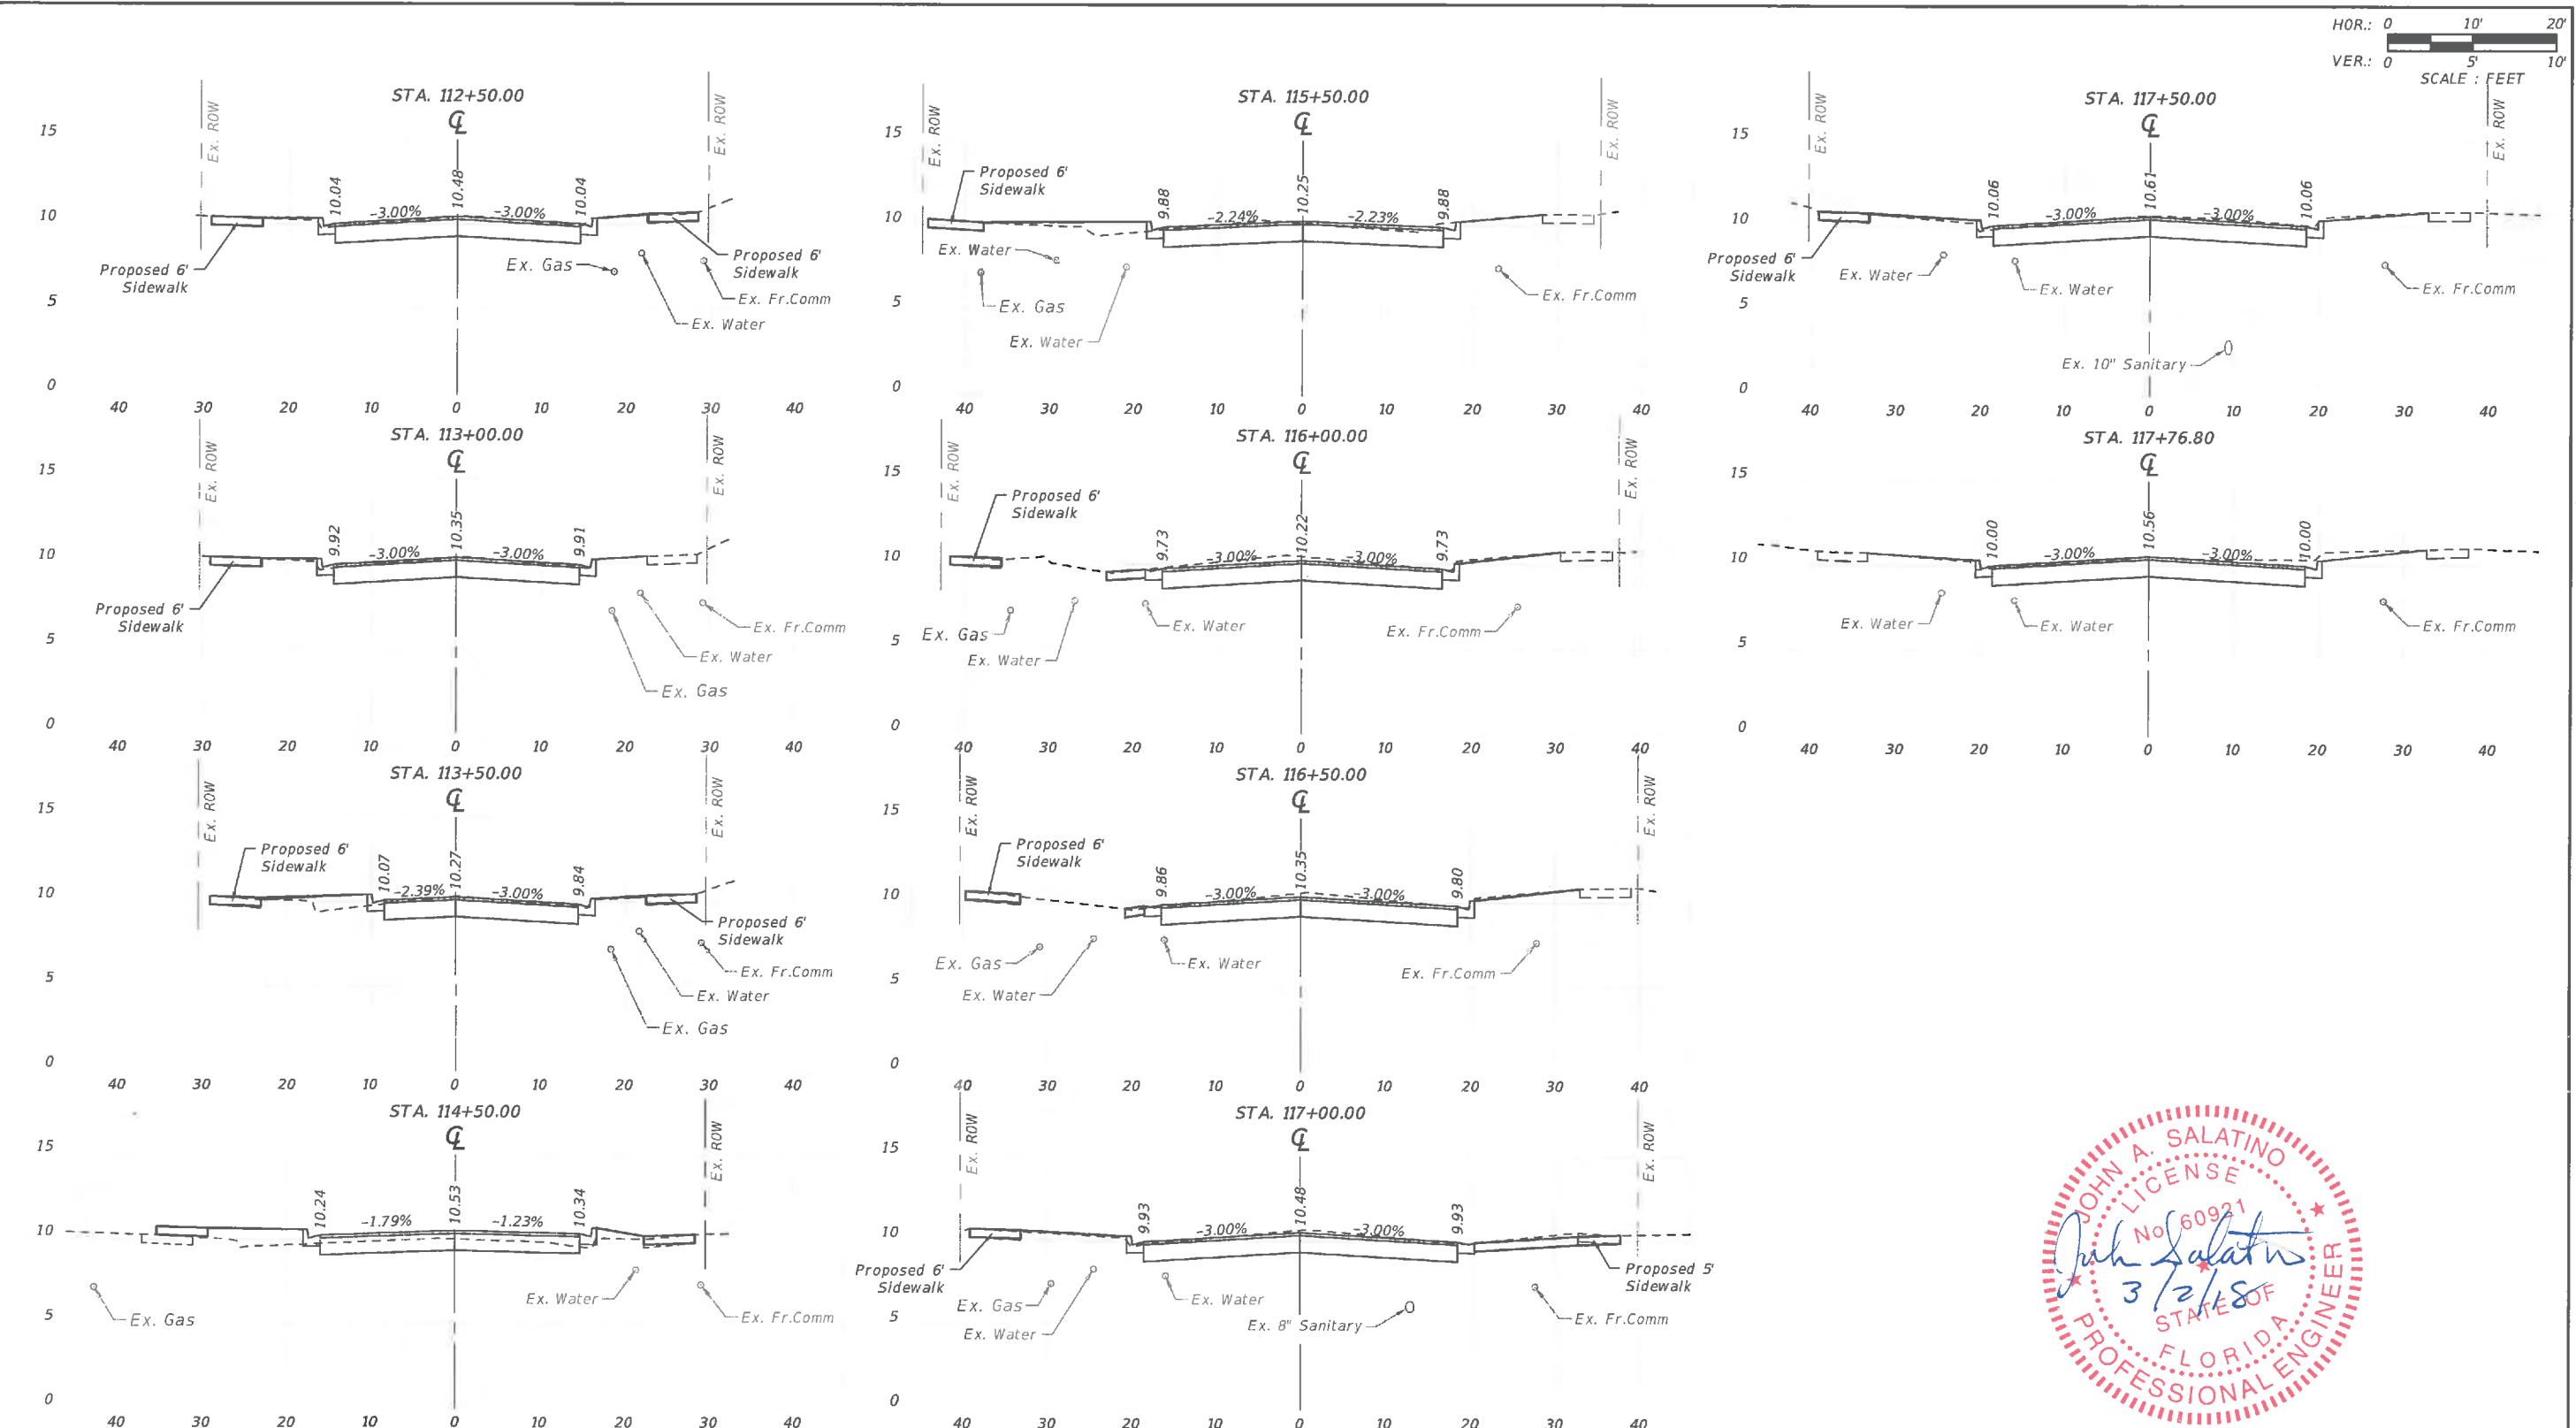
**UTILITIES NOTES:**


LOCATIONS AND DEPTHS ARE APPROXIMATE. THE SIZES SHOWN ARE NOT NECESSARILY REPRESENTATIVE OF ACTUAL CONDITIONS, CONFIGURATION AND LOCATIONS. REFER TO ADDITIONAL NOTES IN THE GENERAL NOTES SHEET IN THE PLANS.

DESIGNED	PREPARED FOR:	PREPARED BY:	PROJECT:	DESCRIPTION:	APPROVED BY:	DATE:
MLM	Venice, FL City on the Gulf	ATKINS	CITY OF VENICE DOWNTOWN ROADWAY CORRIDOR IMPROVEMENTS	TAMPA AVE. CROSS SECTIONS	JOHN SALATINO, P.E. P.E. LICENSE NUMBER 60921 ATKINS NORTH AMERICA (CERT. OF AUTH. NO. 24) 4030 WEST BOY SCOUT BOULEVARD, SUITE 700 TAMPA, FL 33607-1712	2/28/2018
DRAWN	MA					PROJECT NO.: 100054389
CHECKED	MLM					SHEET: 57

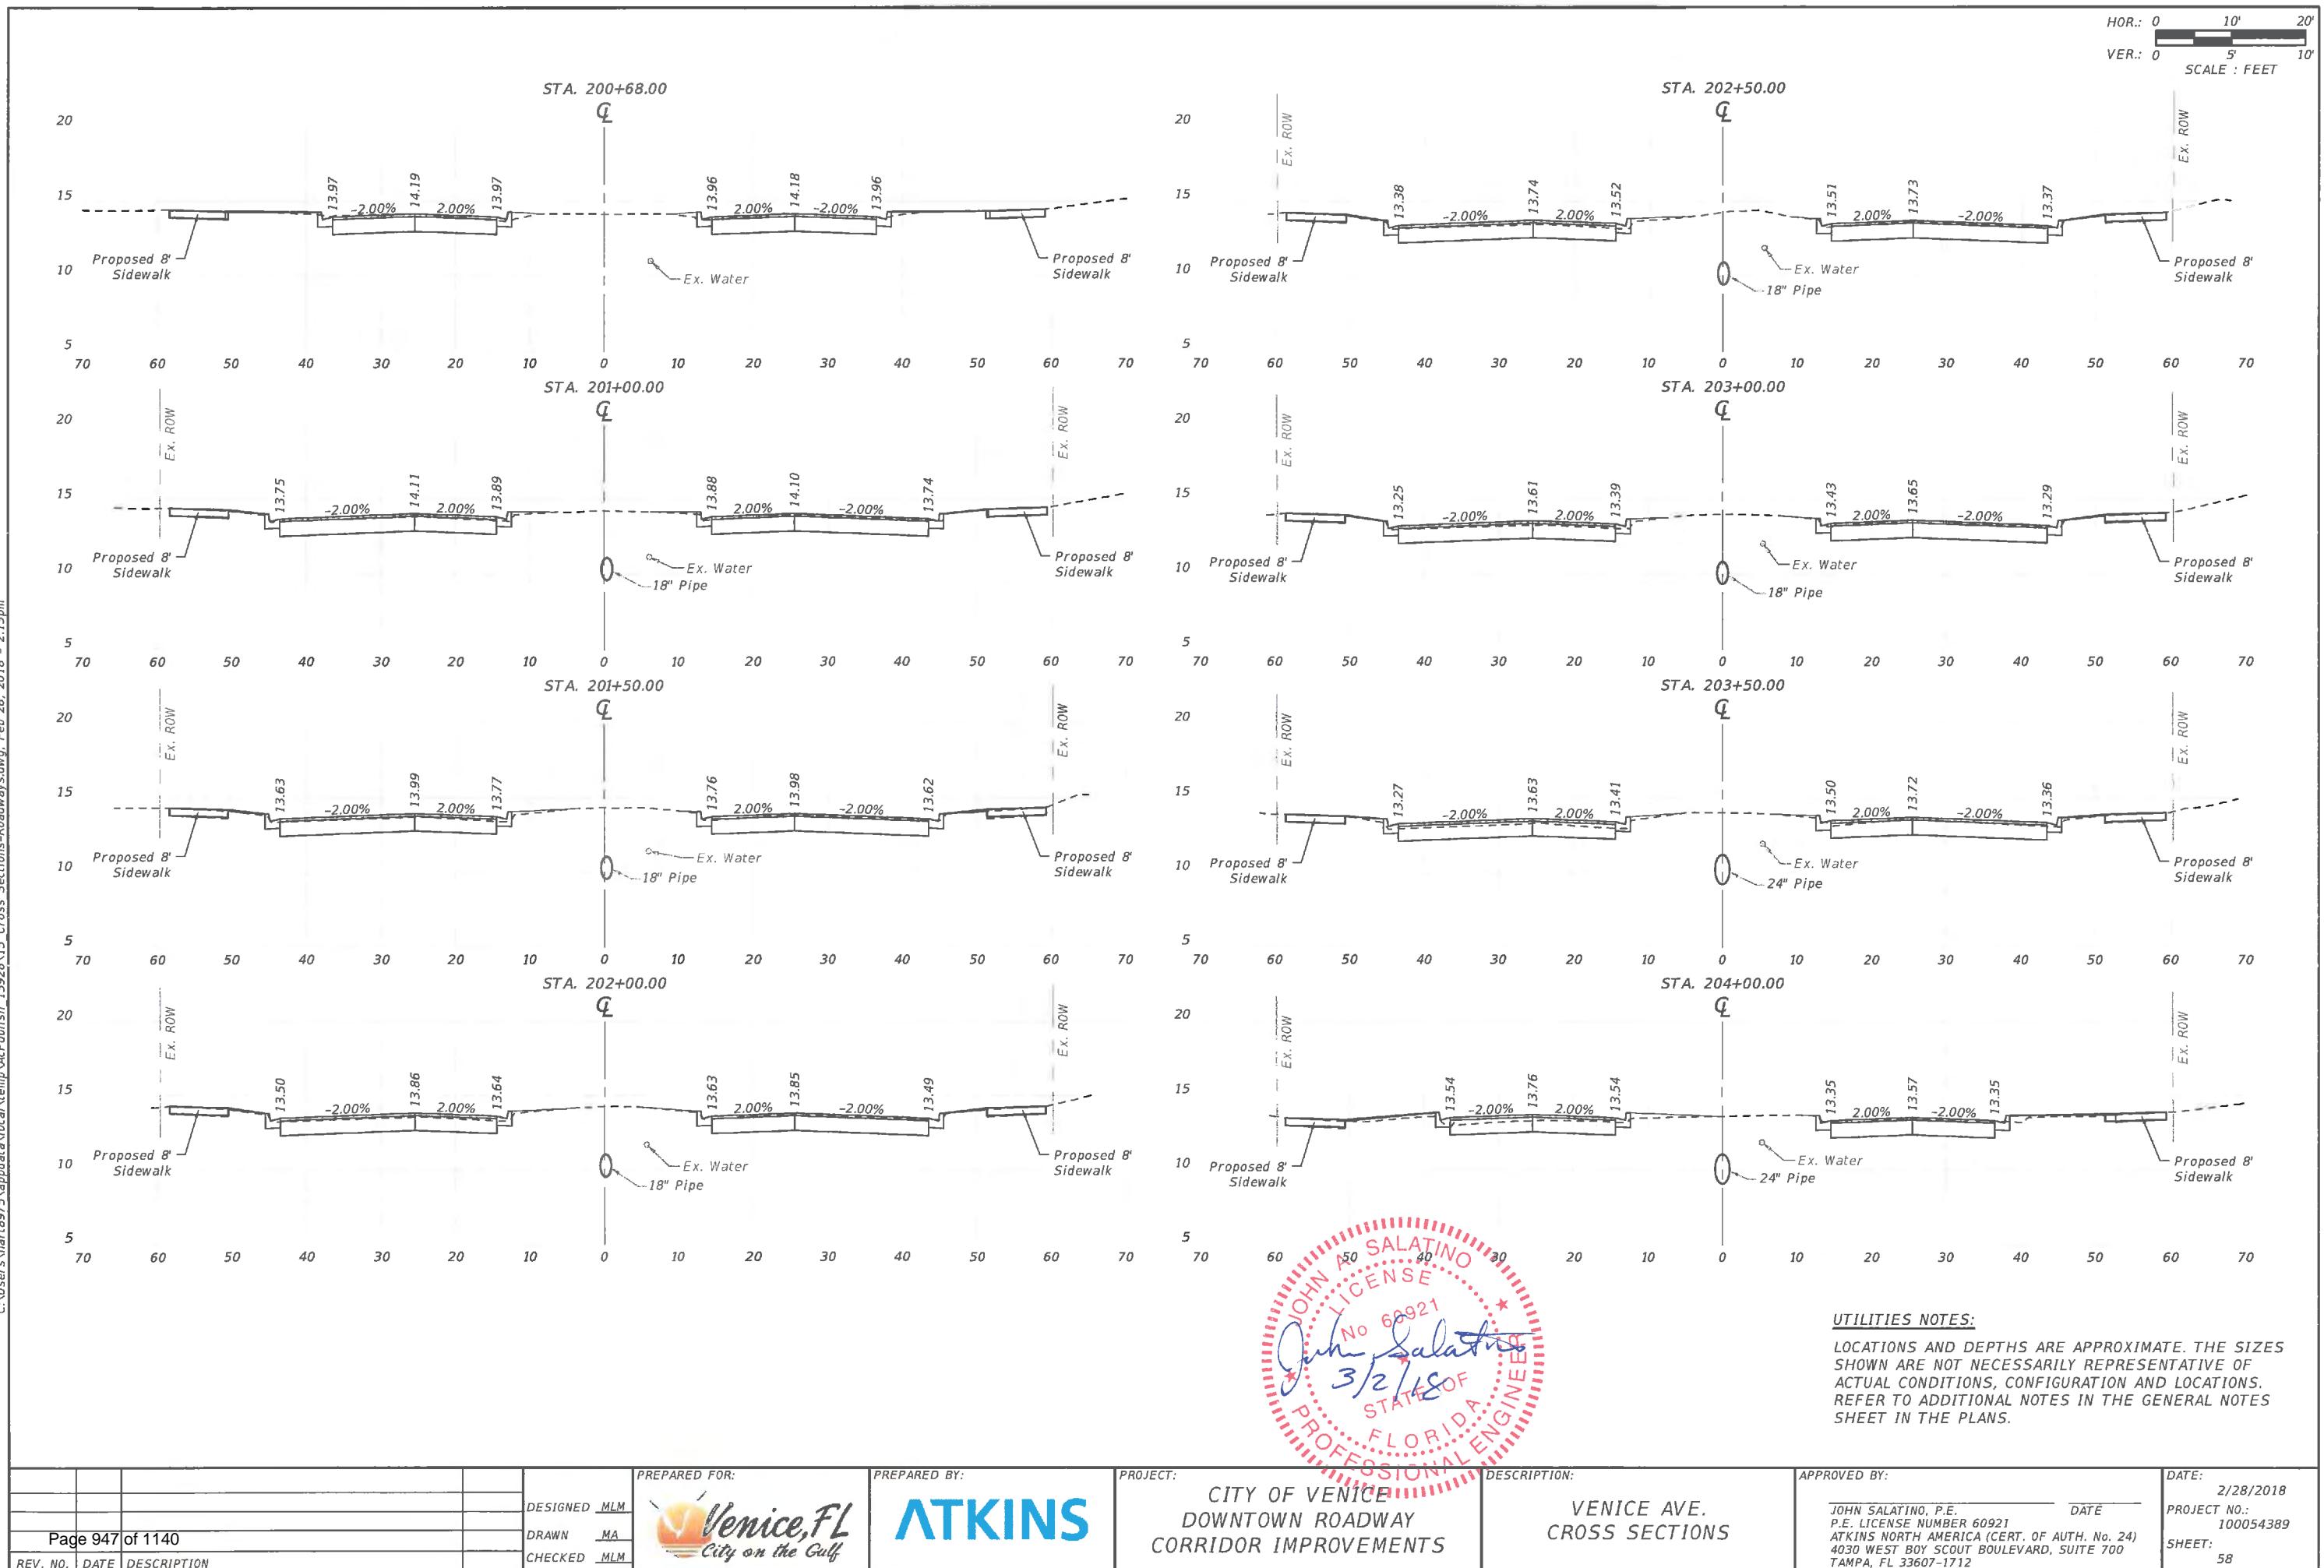


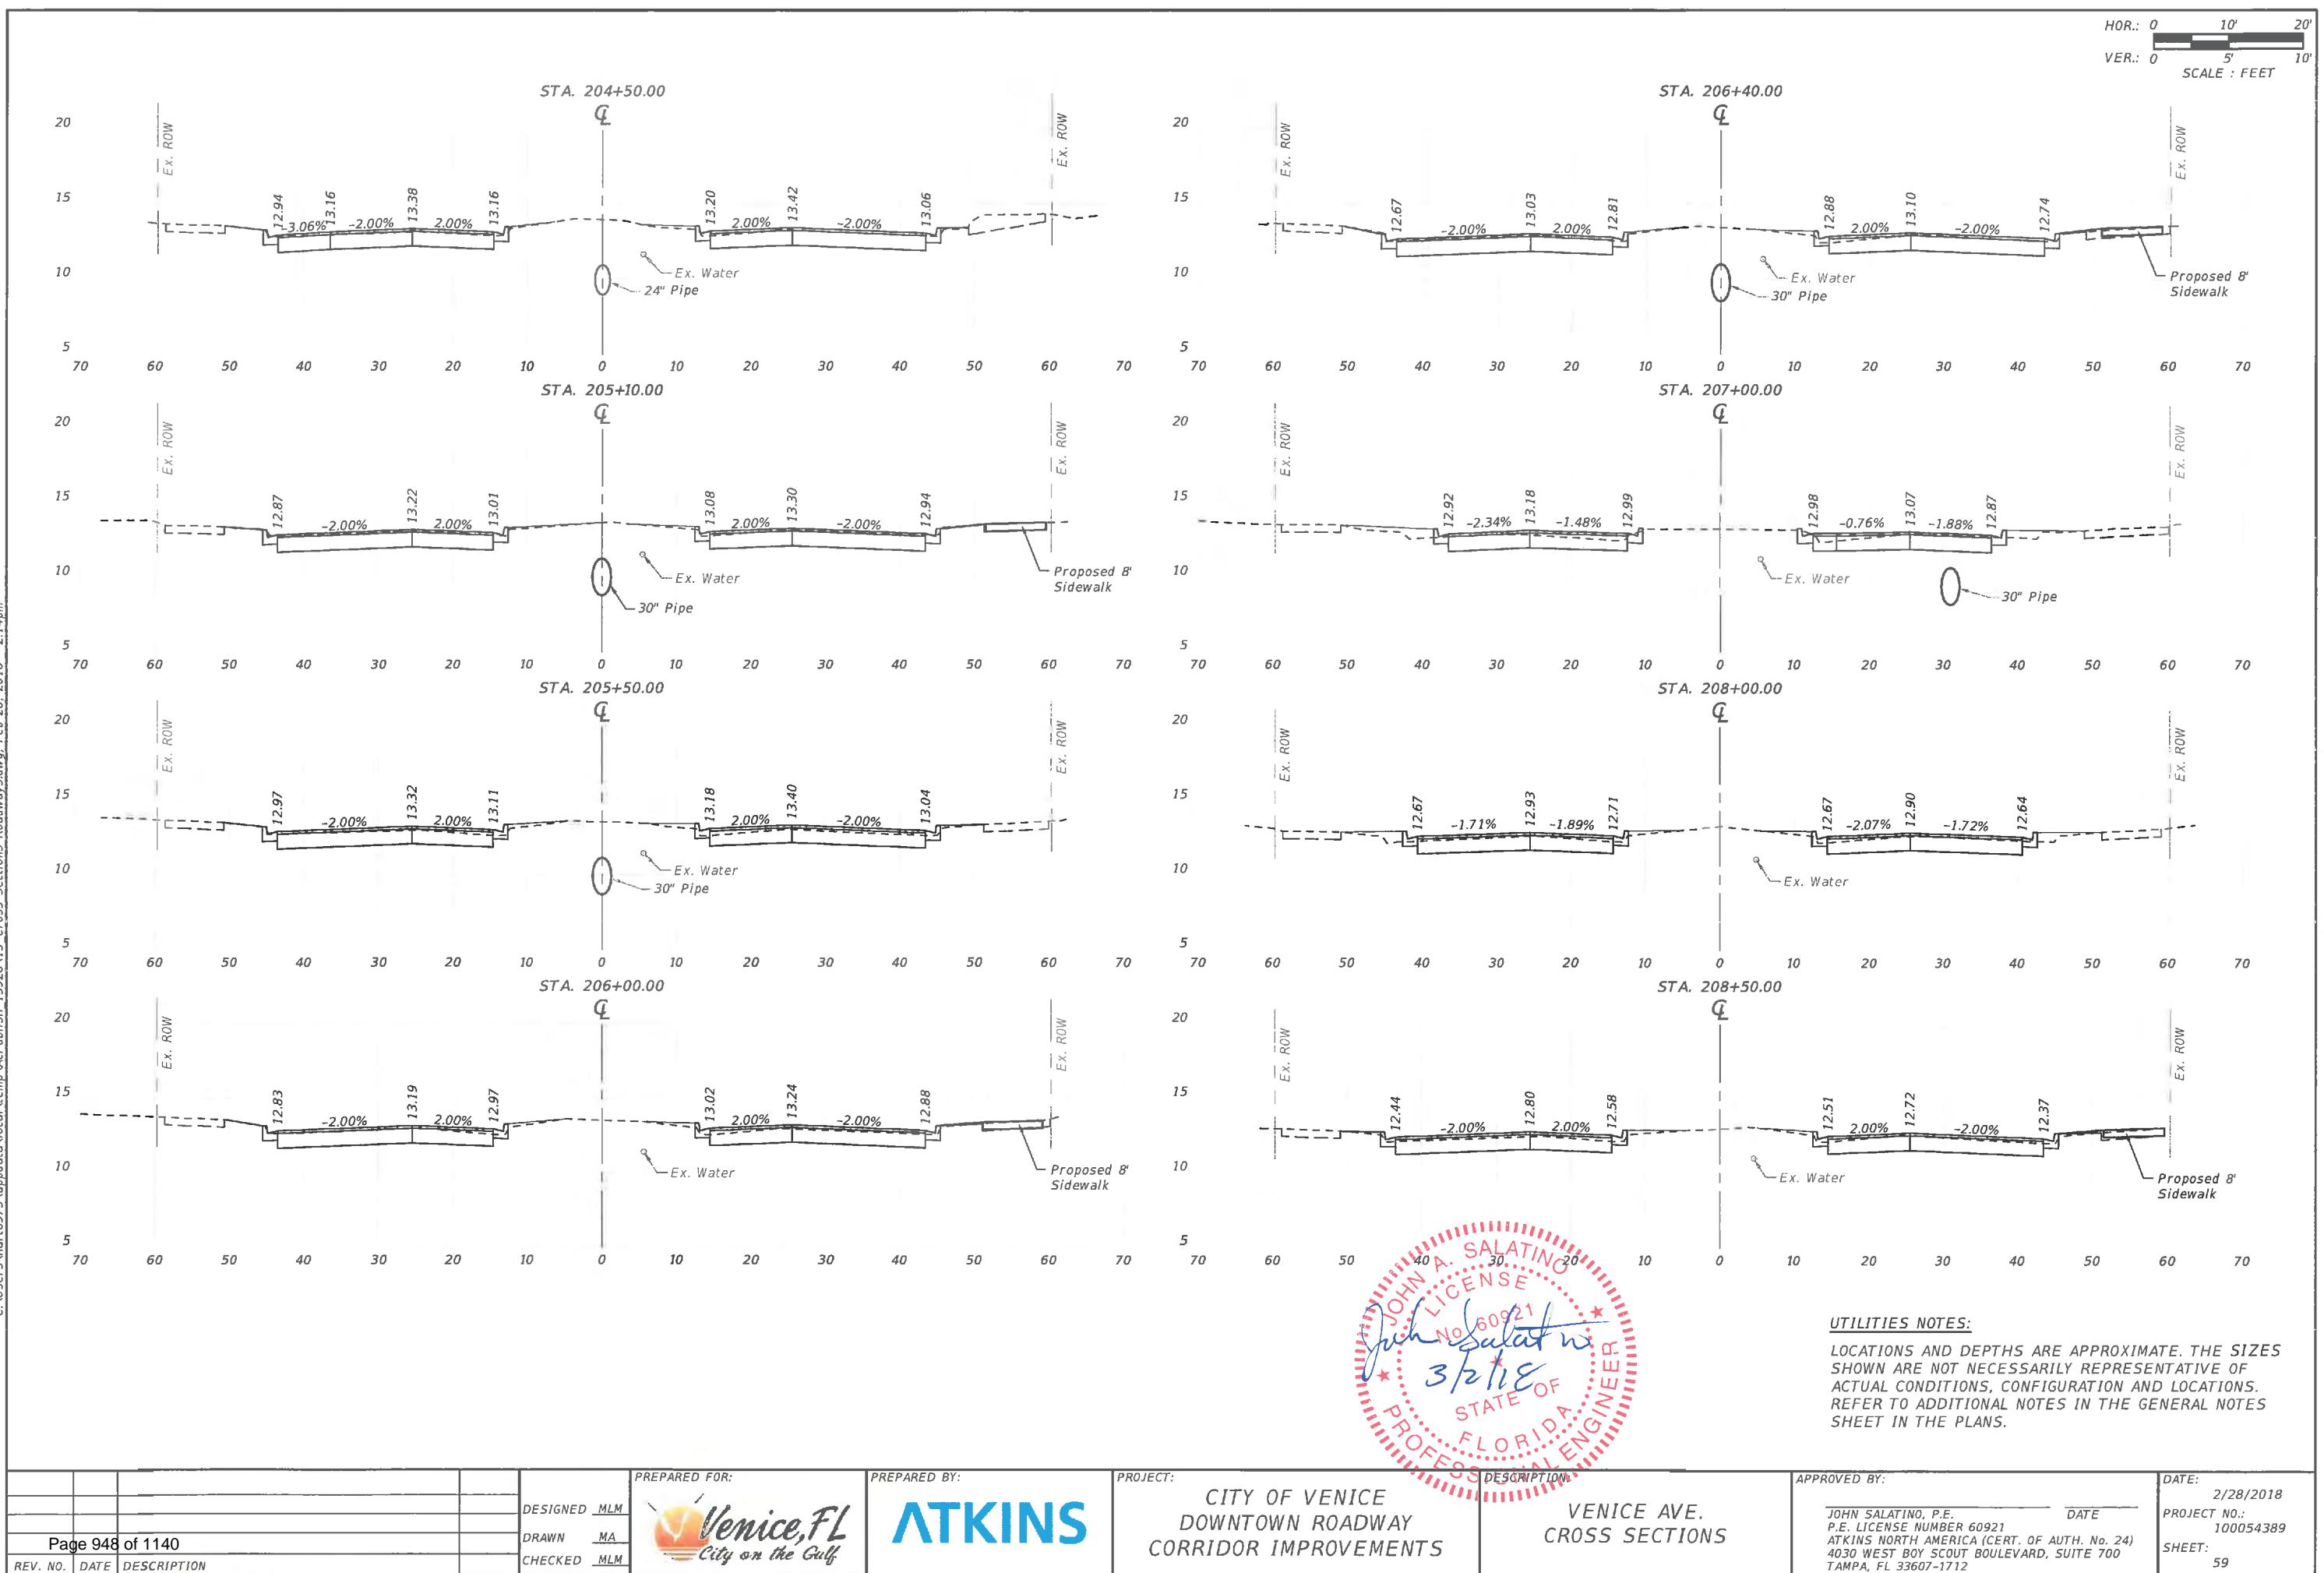

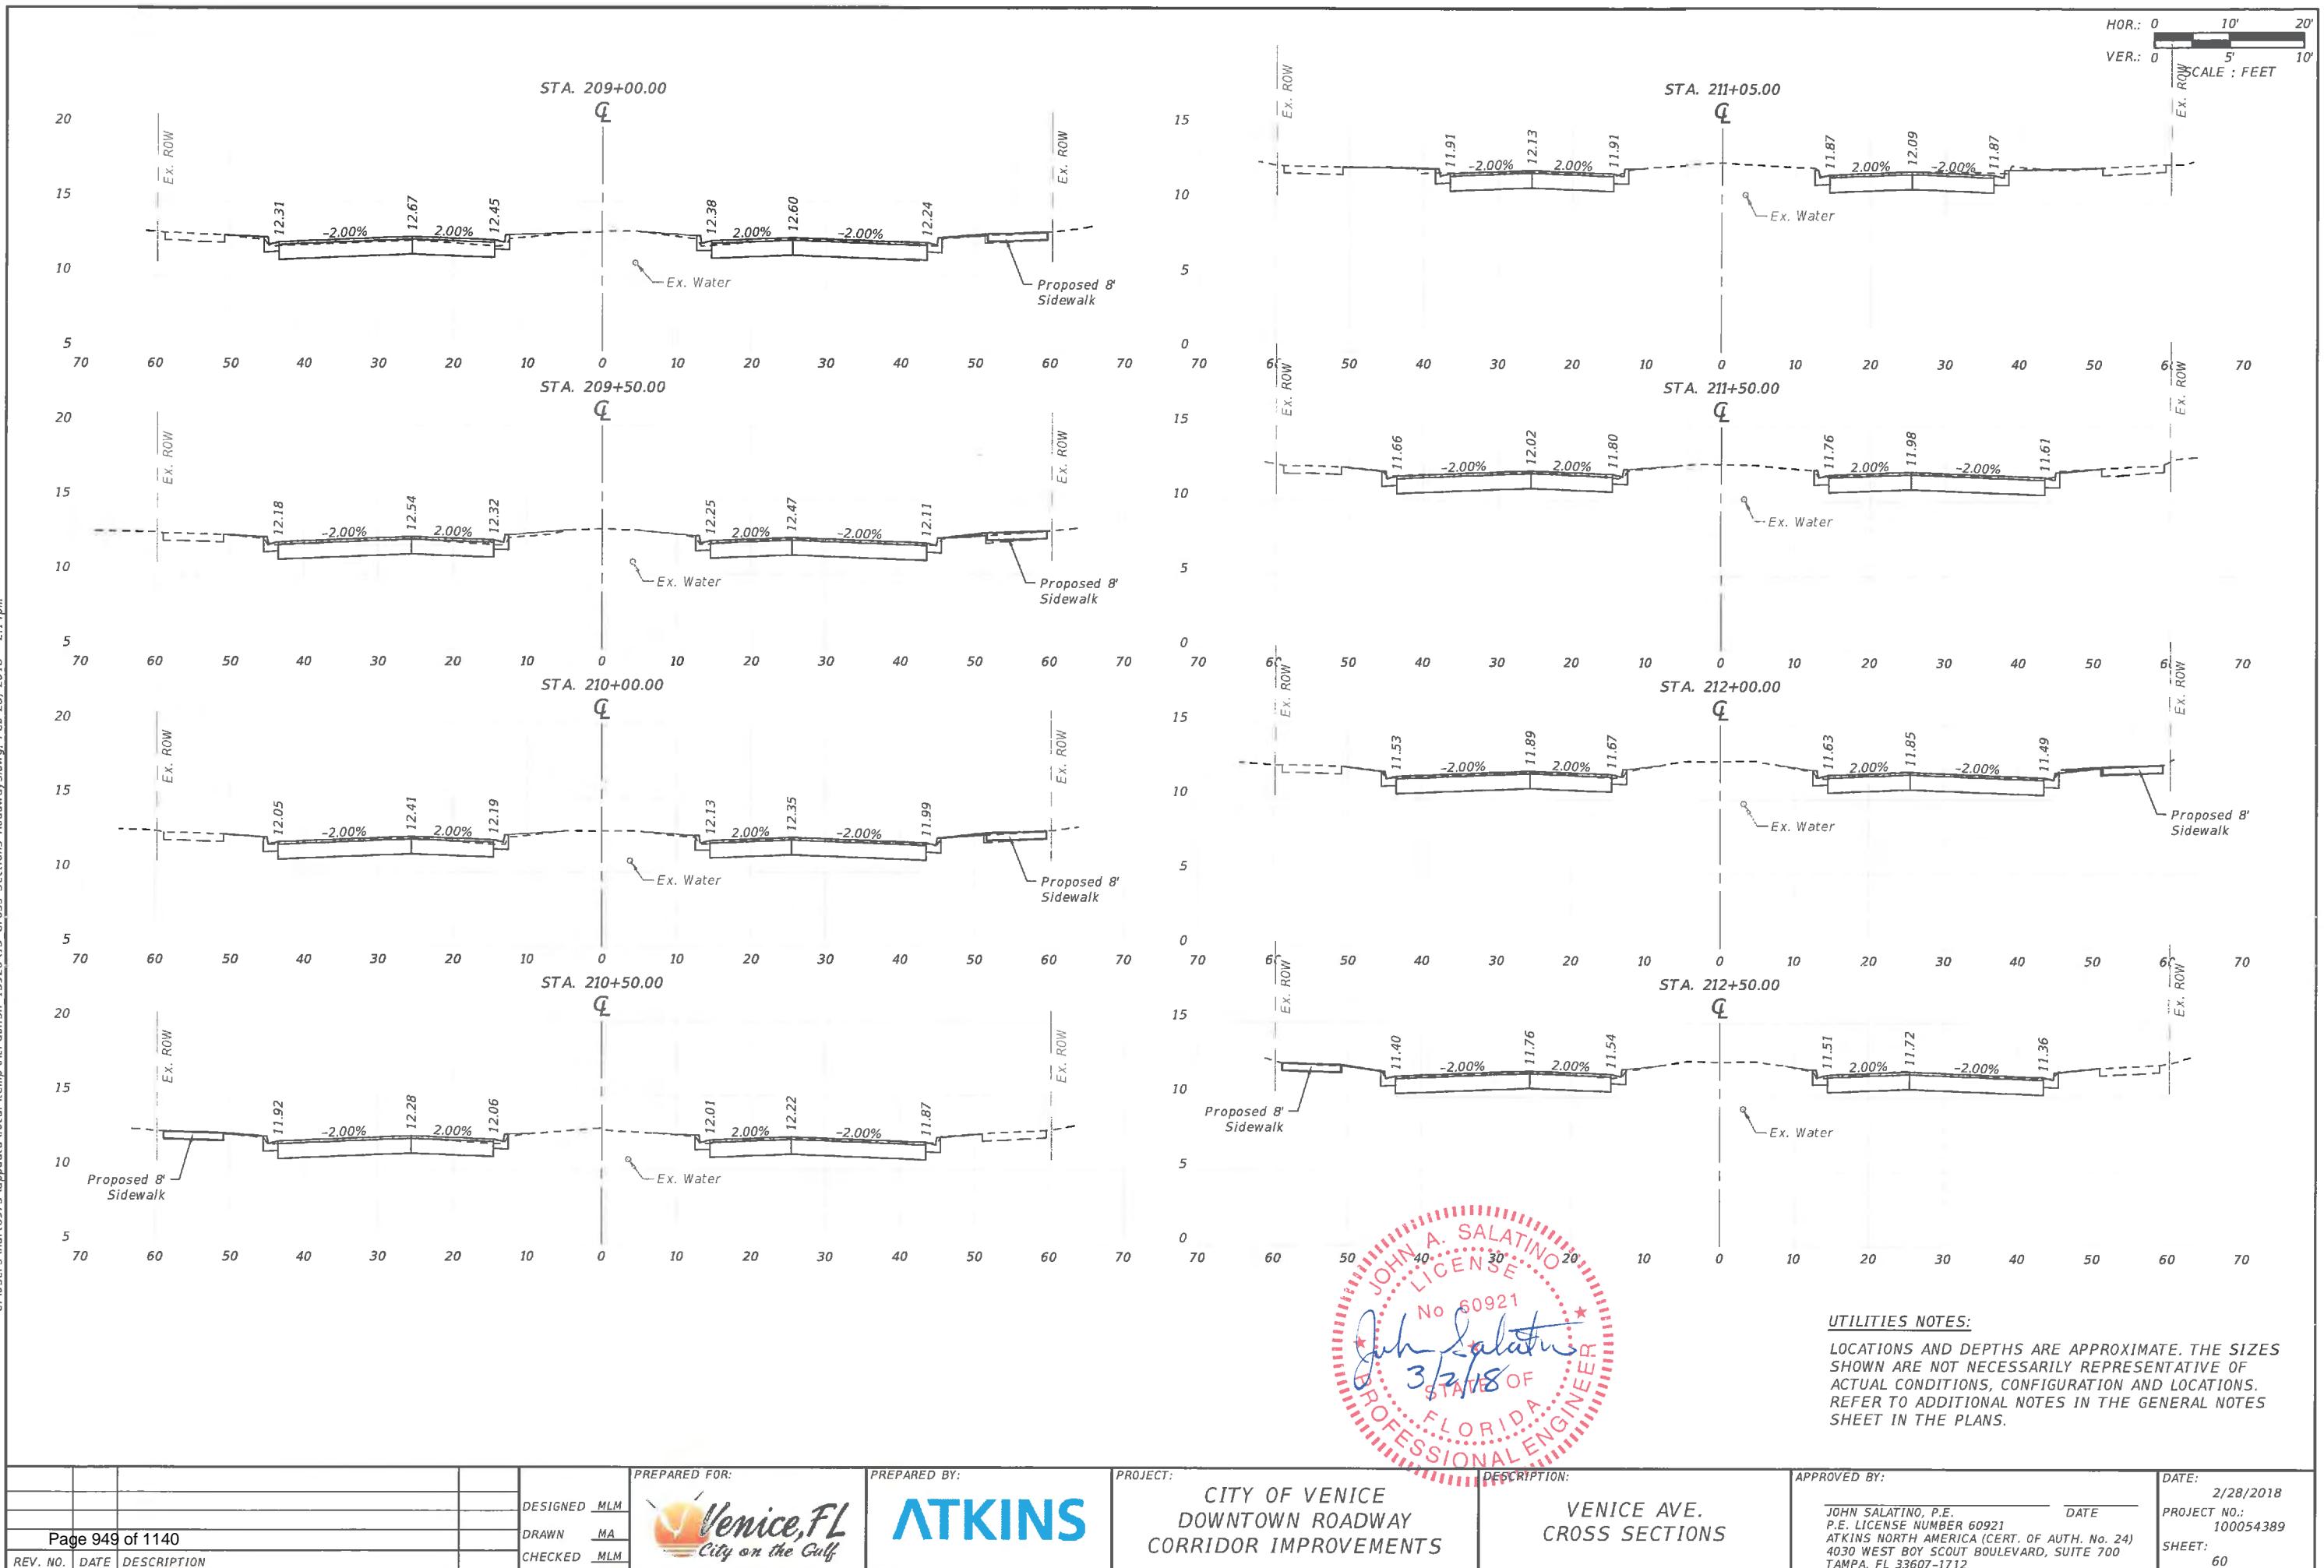

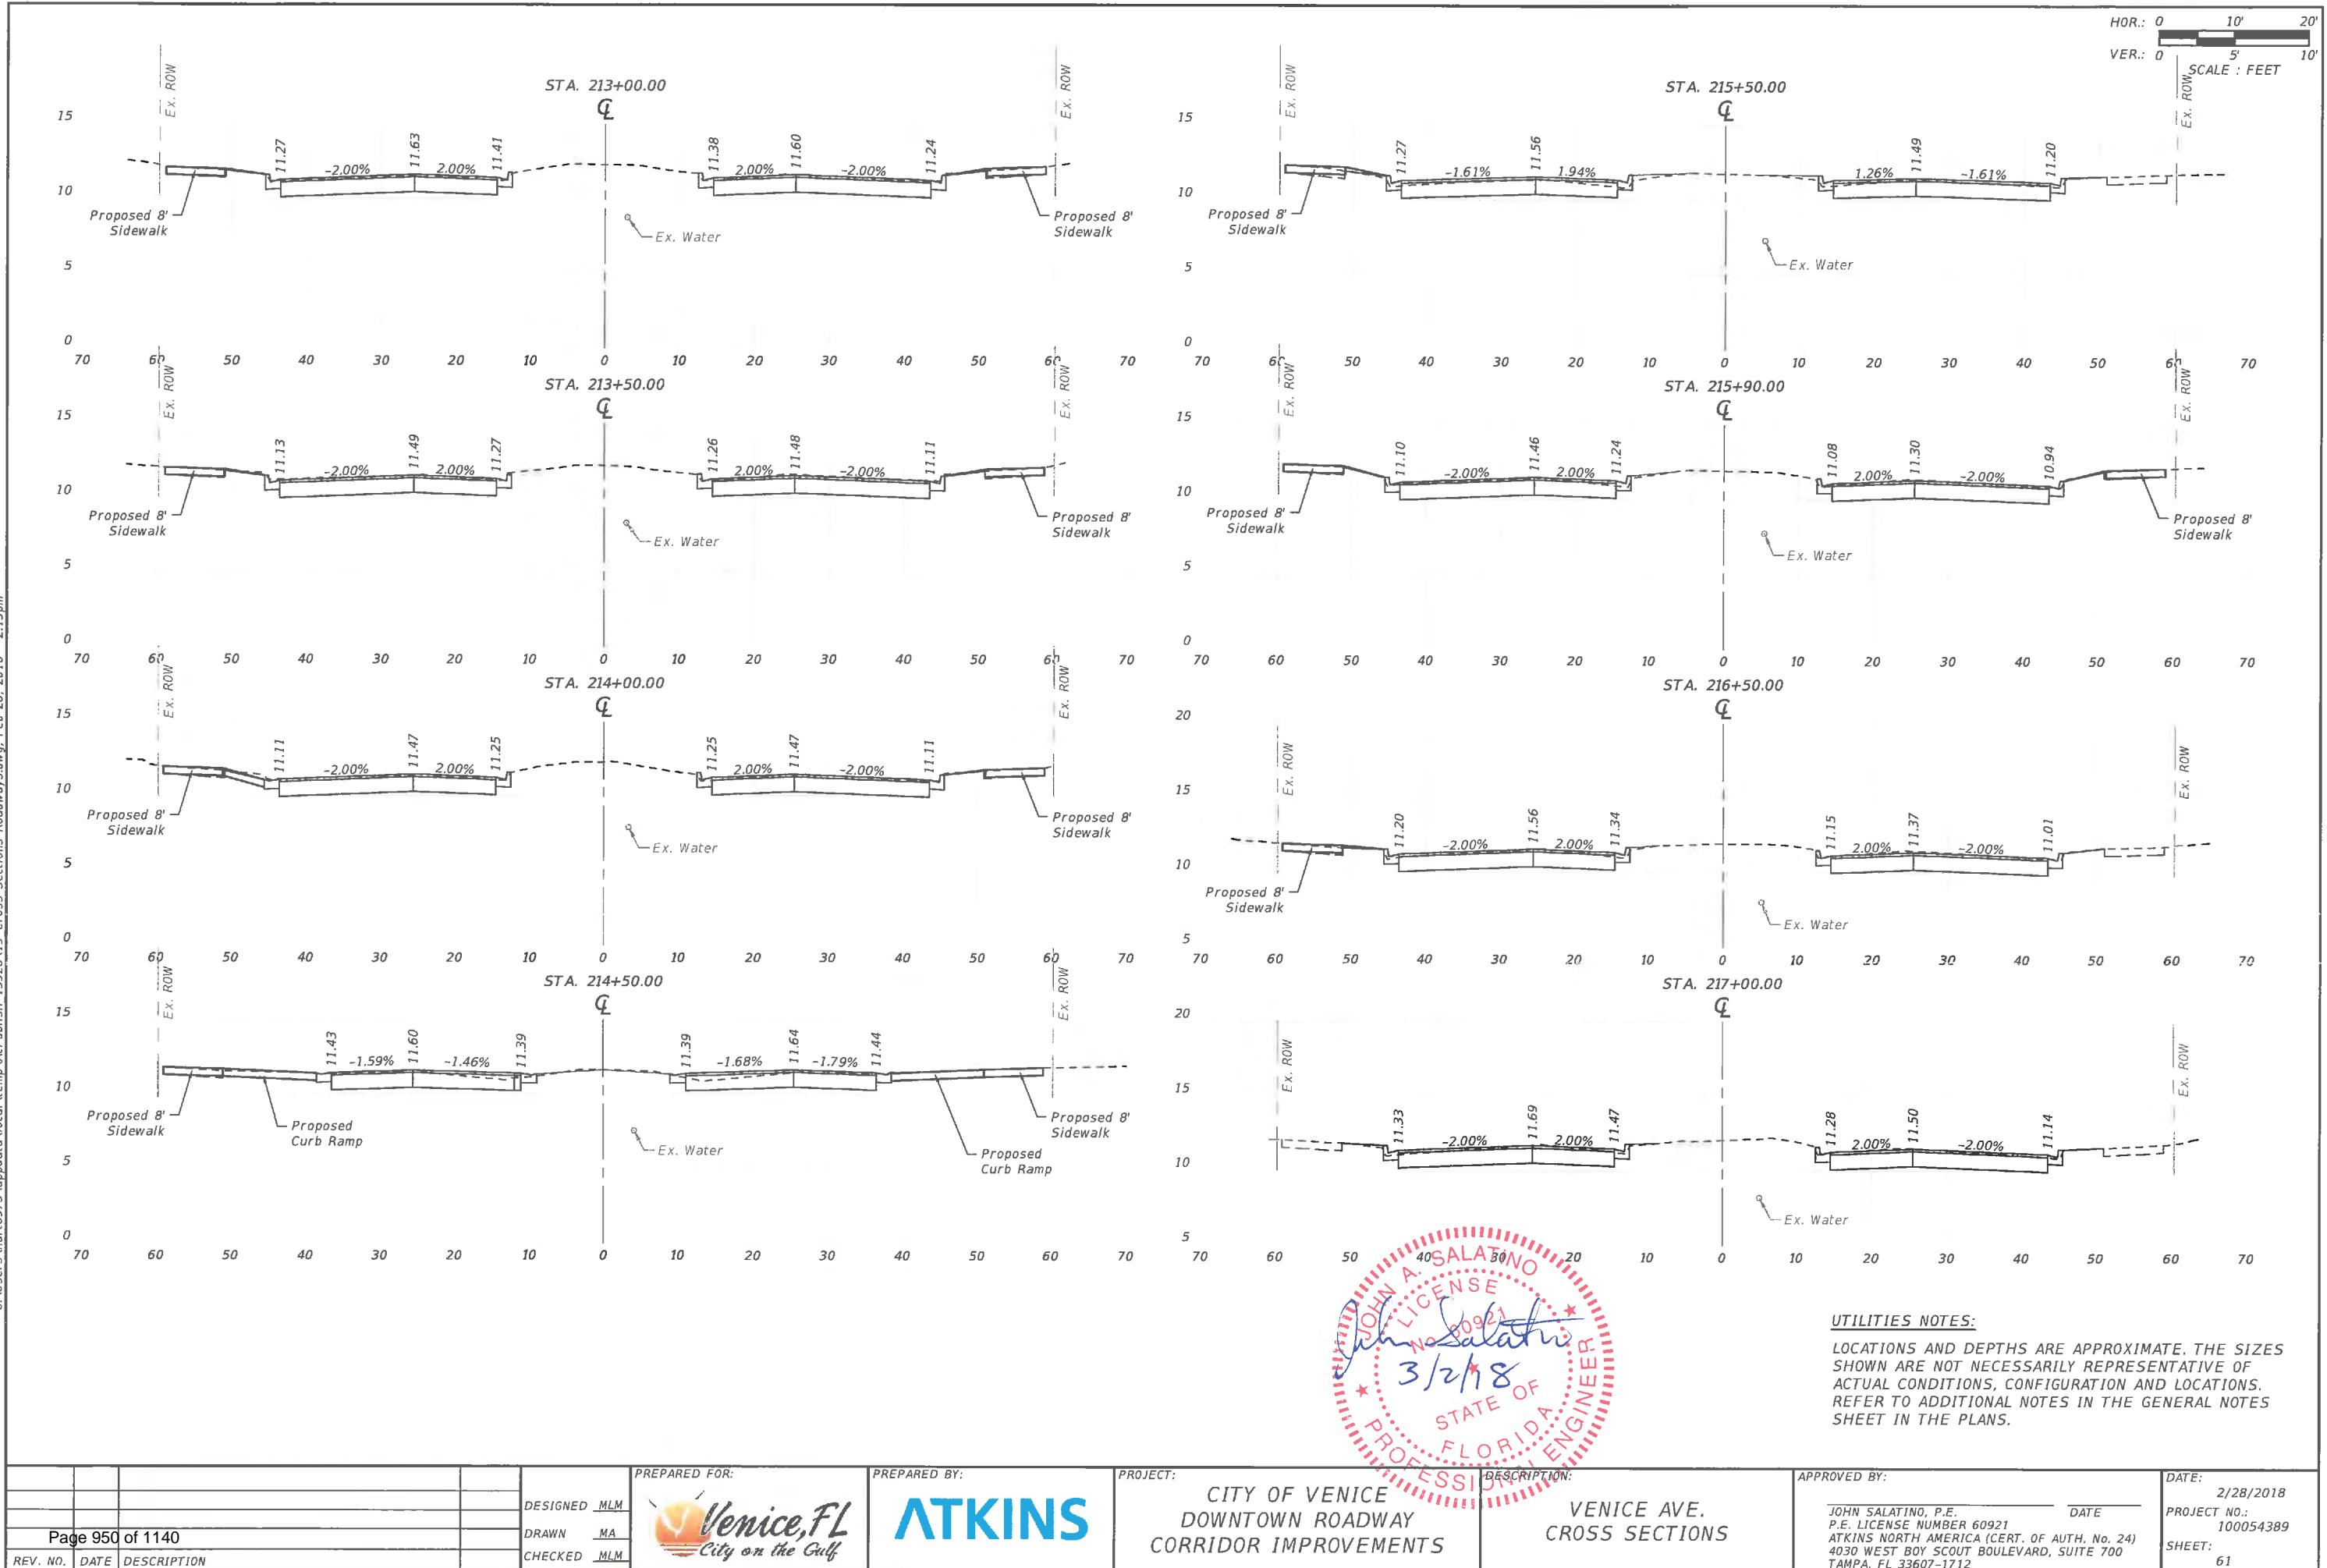

HOR.: 0 10' 20'  
VER.: 0 5' 10'  
SCALE : FEET

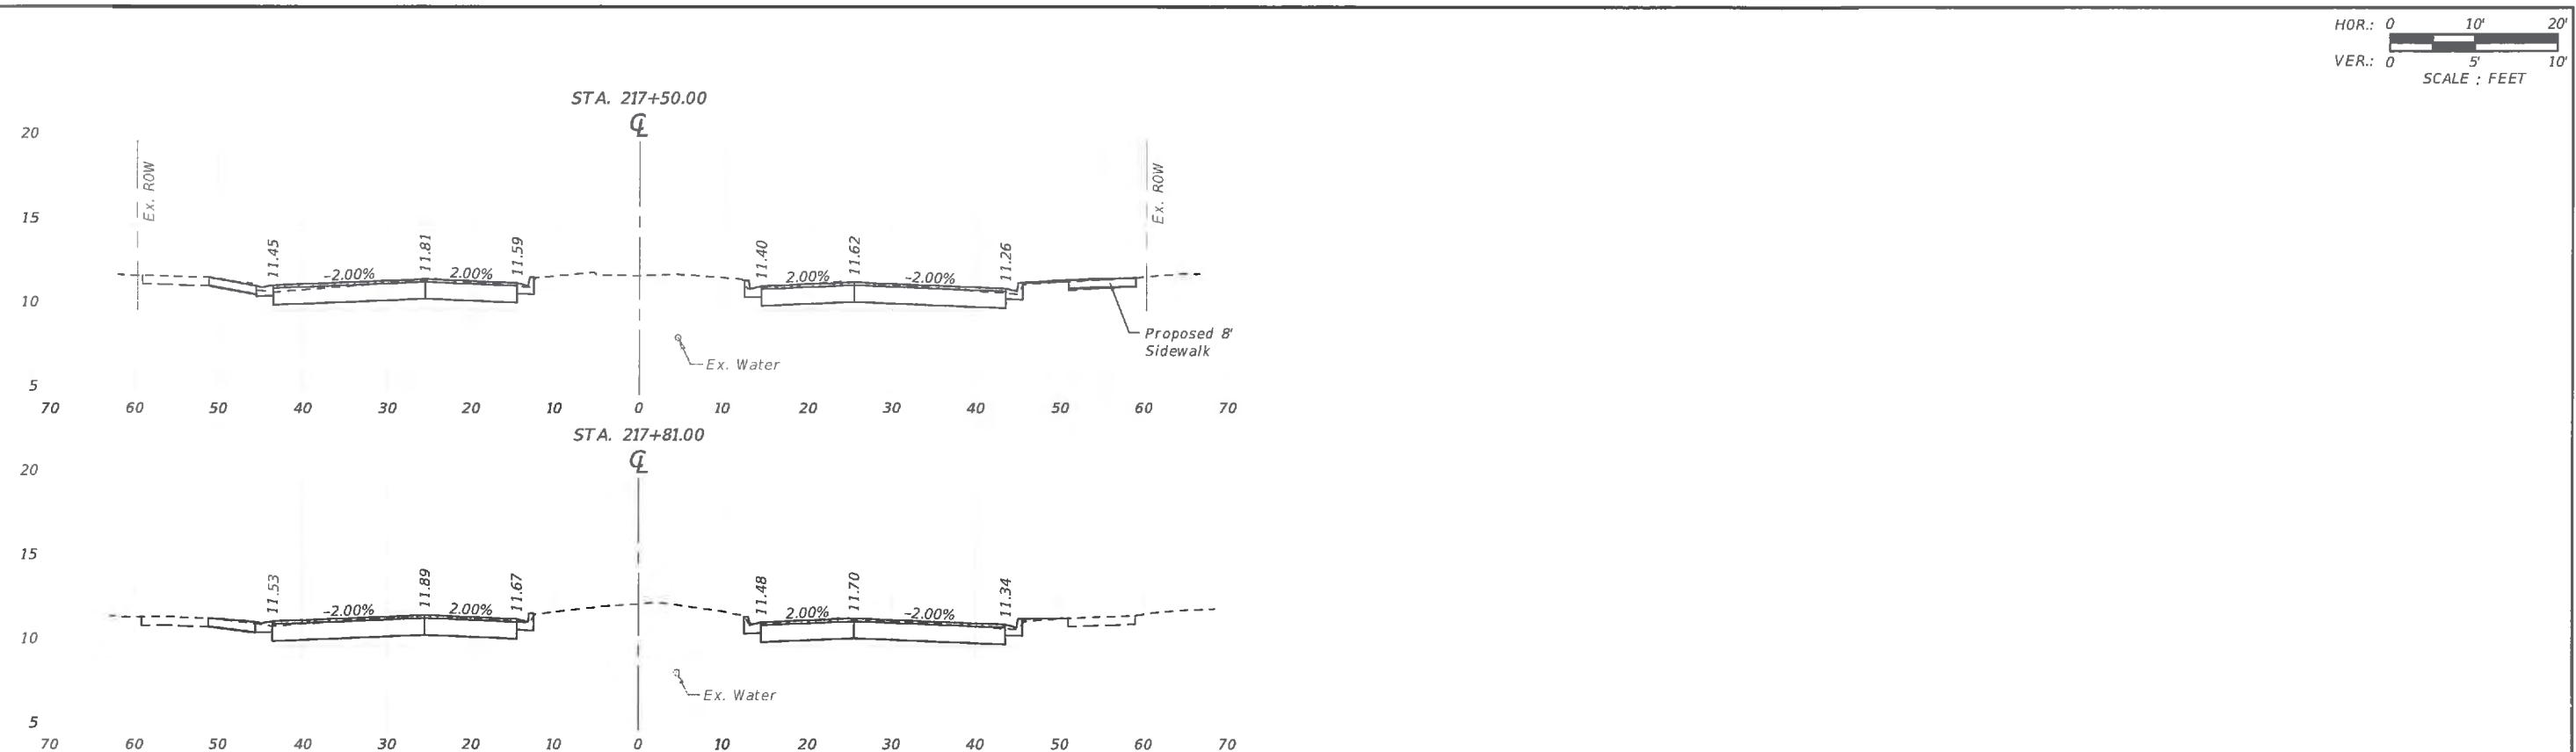



UTILITIES NOTES:


LOCATIONS AND DEPTHS ARE APPROXIMATE. THE SIZES SHOWN ARE NOT NECESSARILY REPRESENTATIVE OF ACTUAL CONDITIONS, CONFIGURATION AND LOCATIONS. REFER TO ADDITIONAL NOTES IN THE GENERAL NOTES SHEET IN THE PLANS.

				PREPARED FOR:	PREPARED BY:	PROJECT:	DESCRIPTION:	APPROVED BY:	DATE:
				DESIGNED MLM	DRAWN MA	ATKINS	CITY OF VENICE DOWNTOWN ROADWAY CORRIDOR IMPROVEMENTS	JOHN SALATINO, P.E. P.E. LICENSE NUMBER 60921 ATKINS NORTH AMERICA (CERT. OF AUTH. NO. 24) 4030 WEST BOY SCOUT BOULEVARD, SUITE 700 TAMPA, FL 33607-1712	2/28/2018
Page 951	of 1140			CHECKED MLM			VENICE AVE. CROSS SECTIONS		PROJECT NO.: 100054389 SHEET: 62
REV. NO.	DATE	DESCRIPTION							



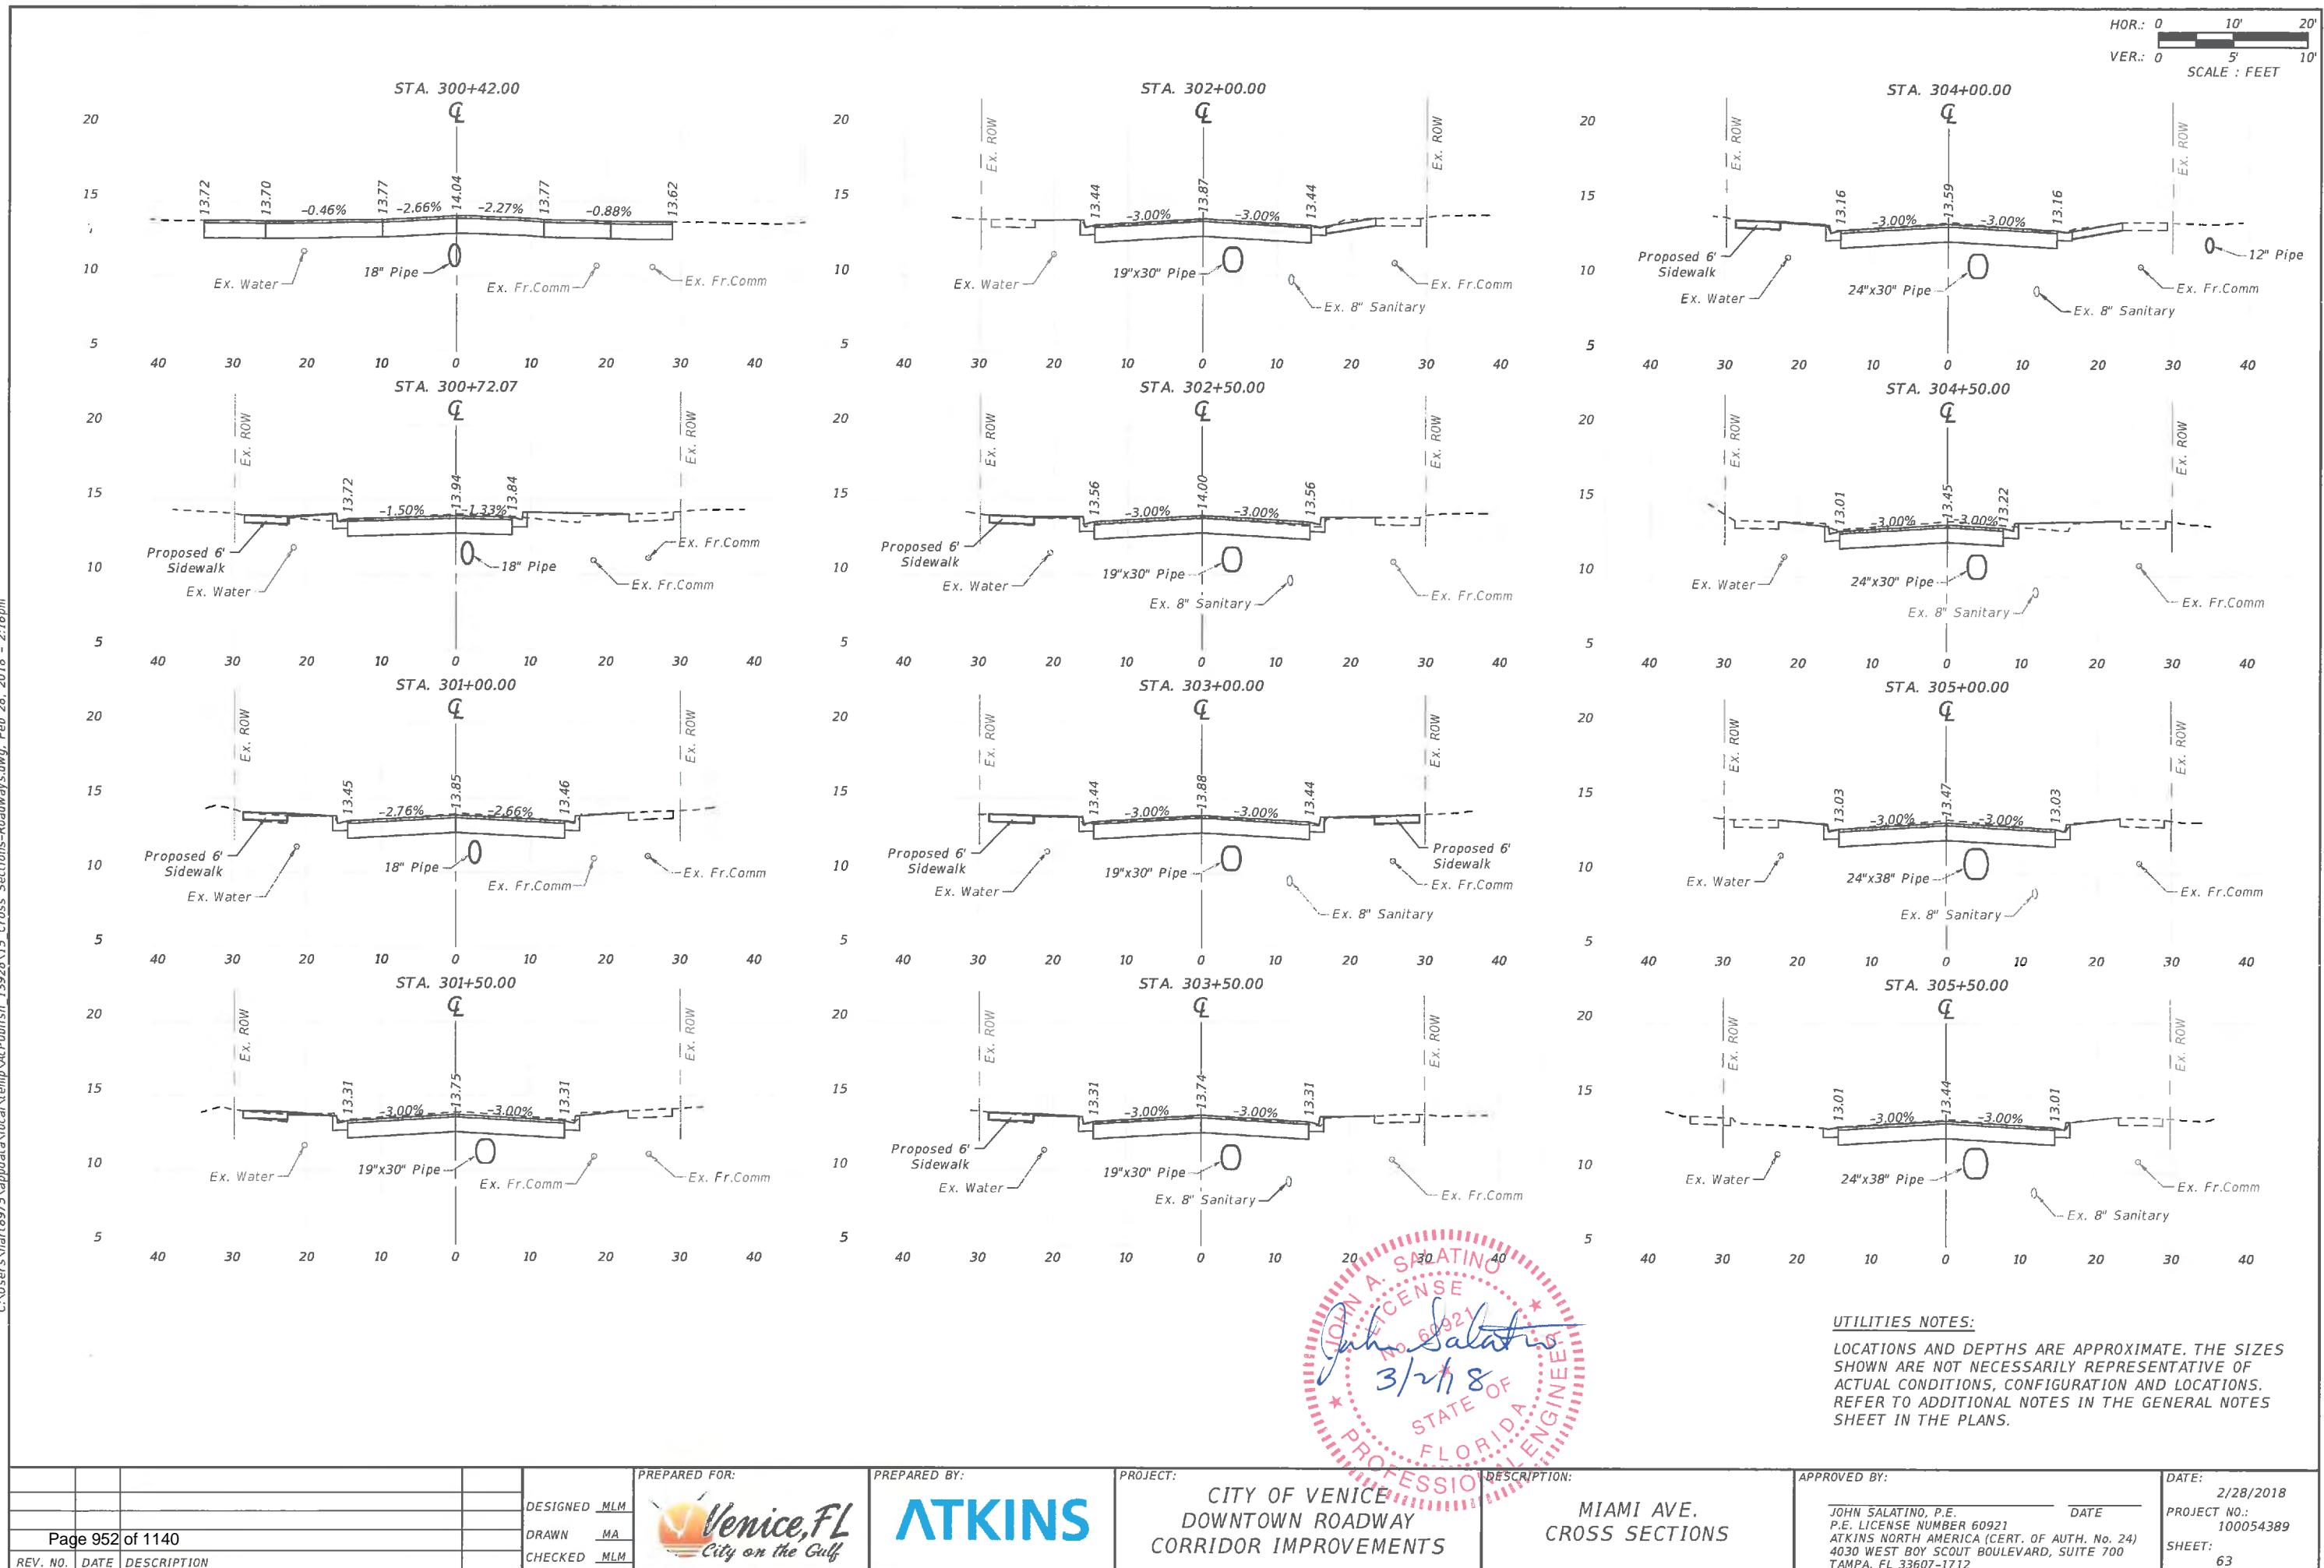

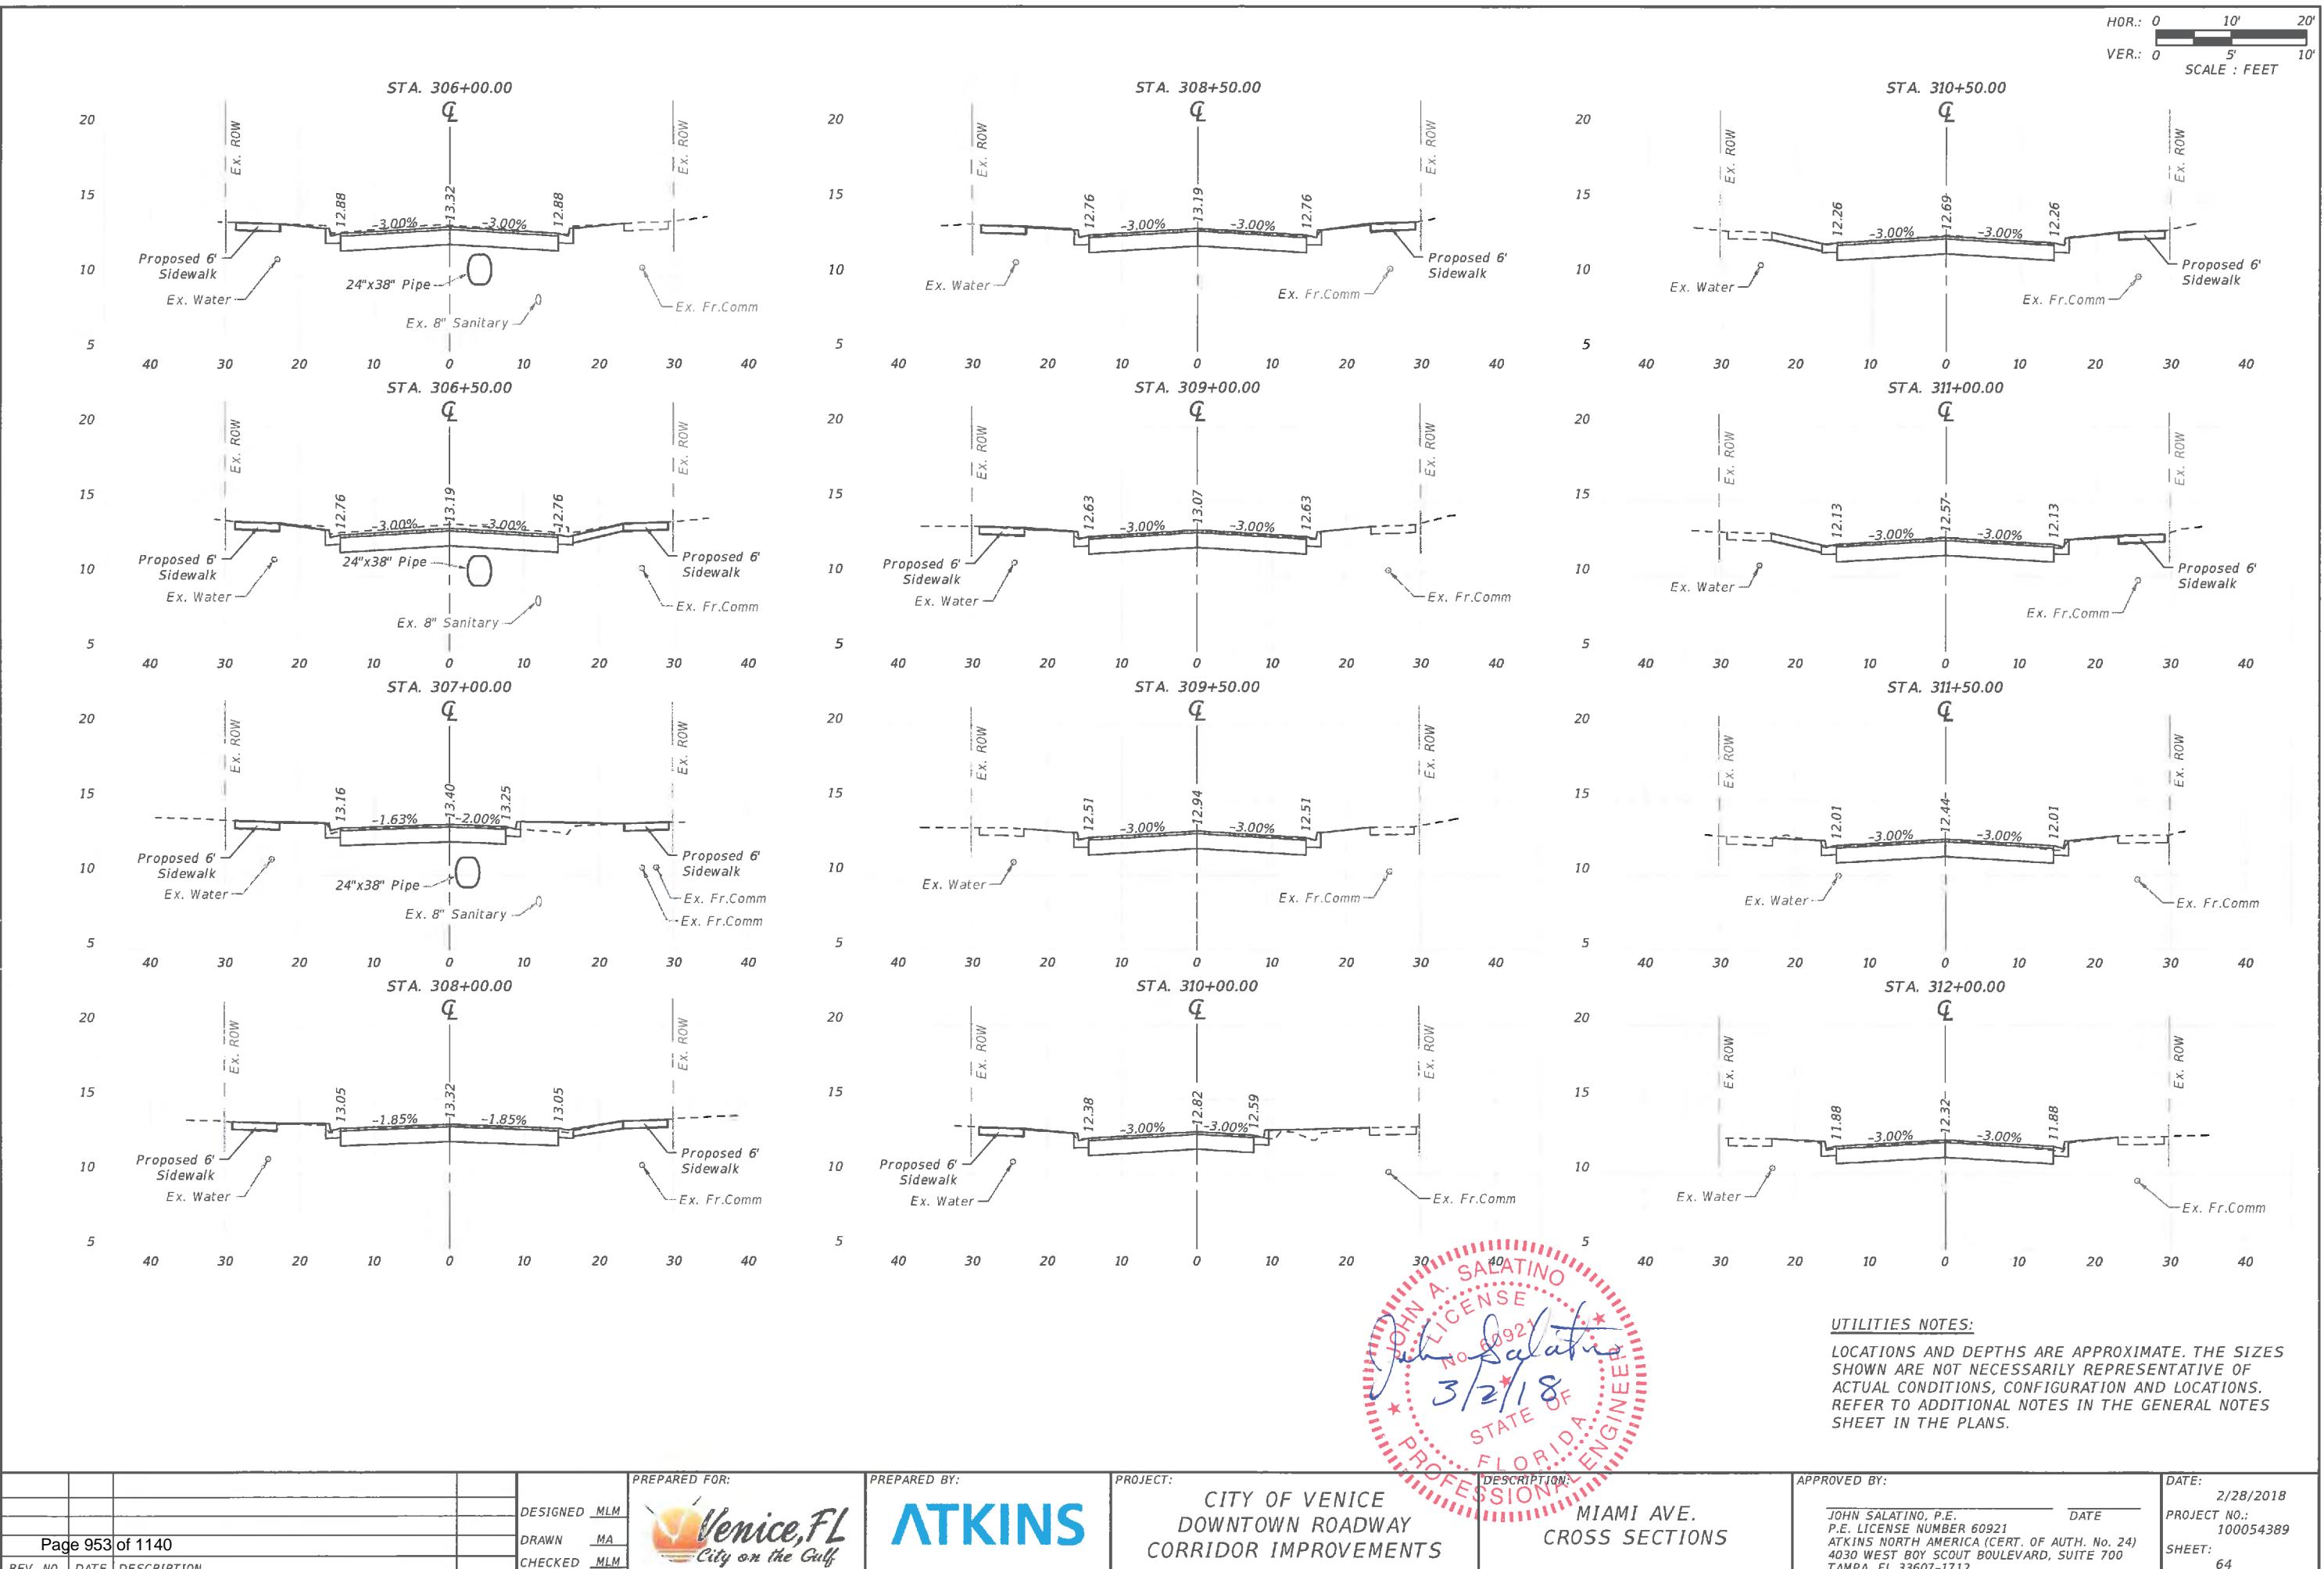


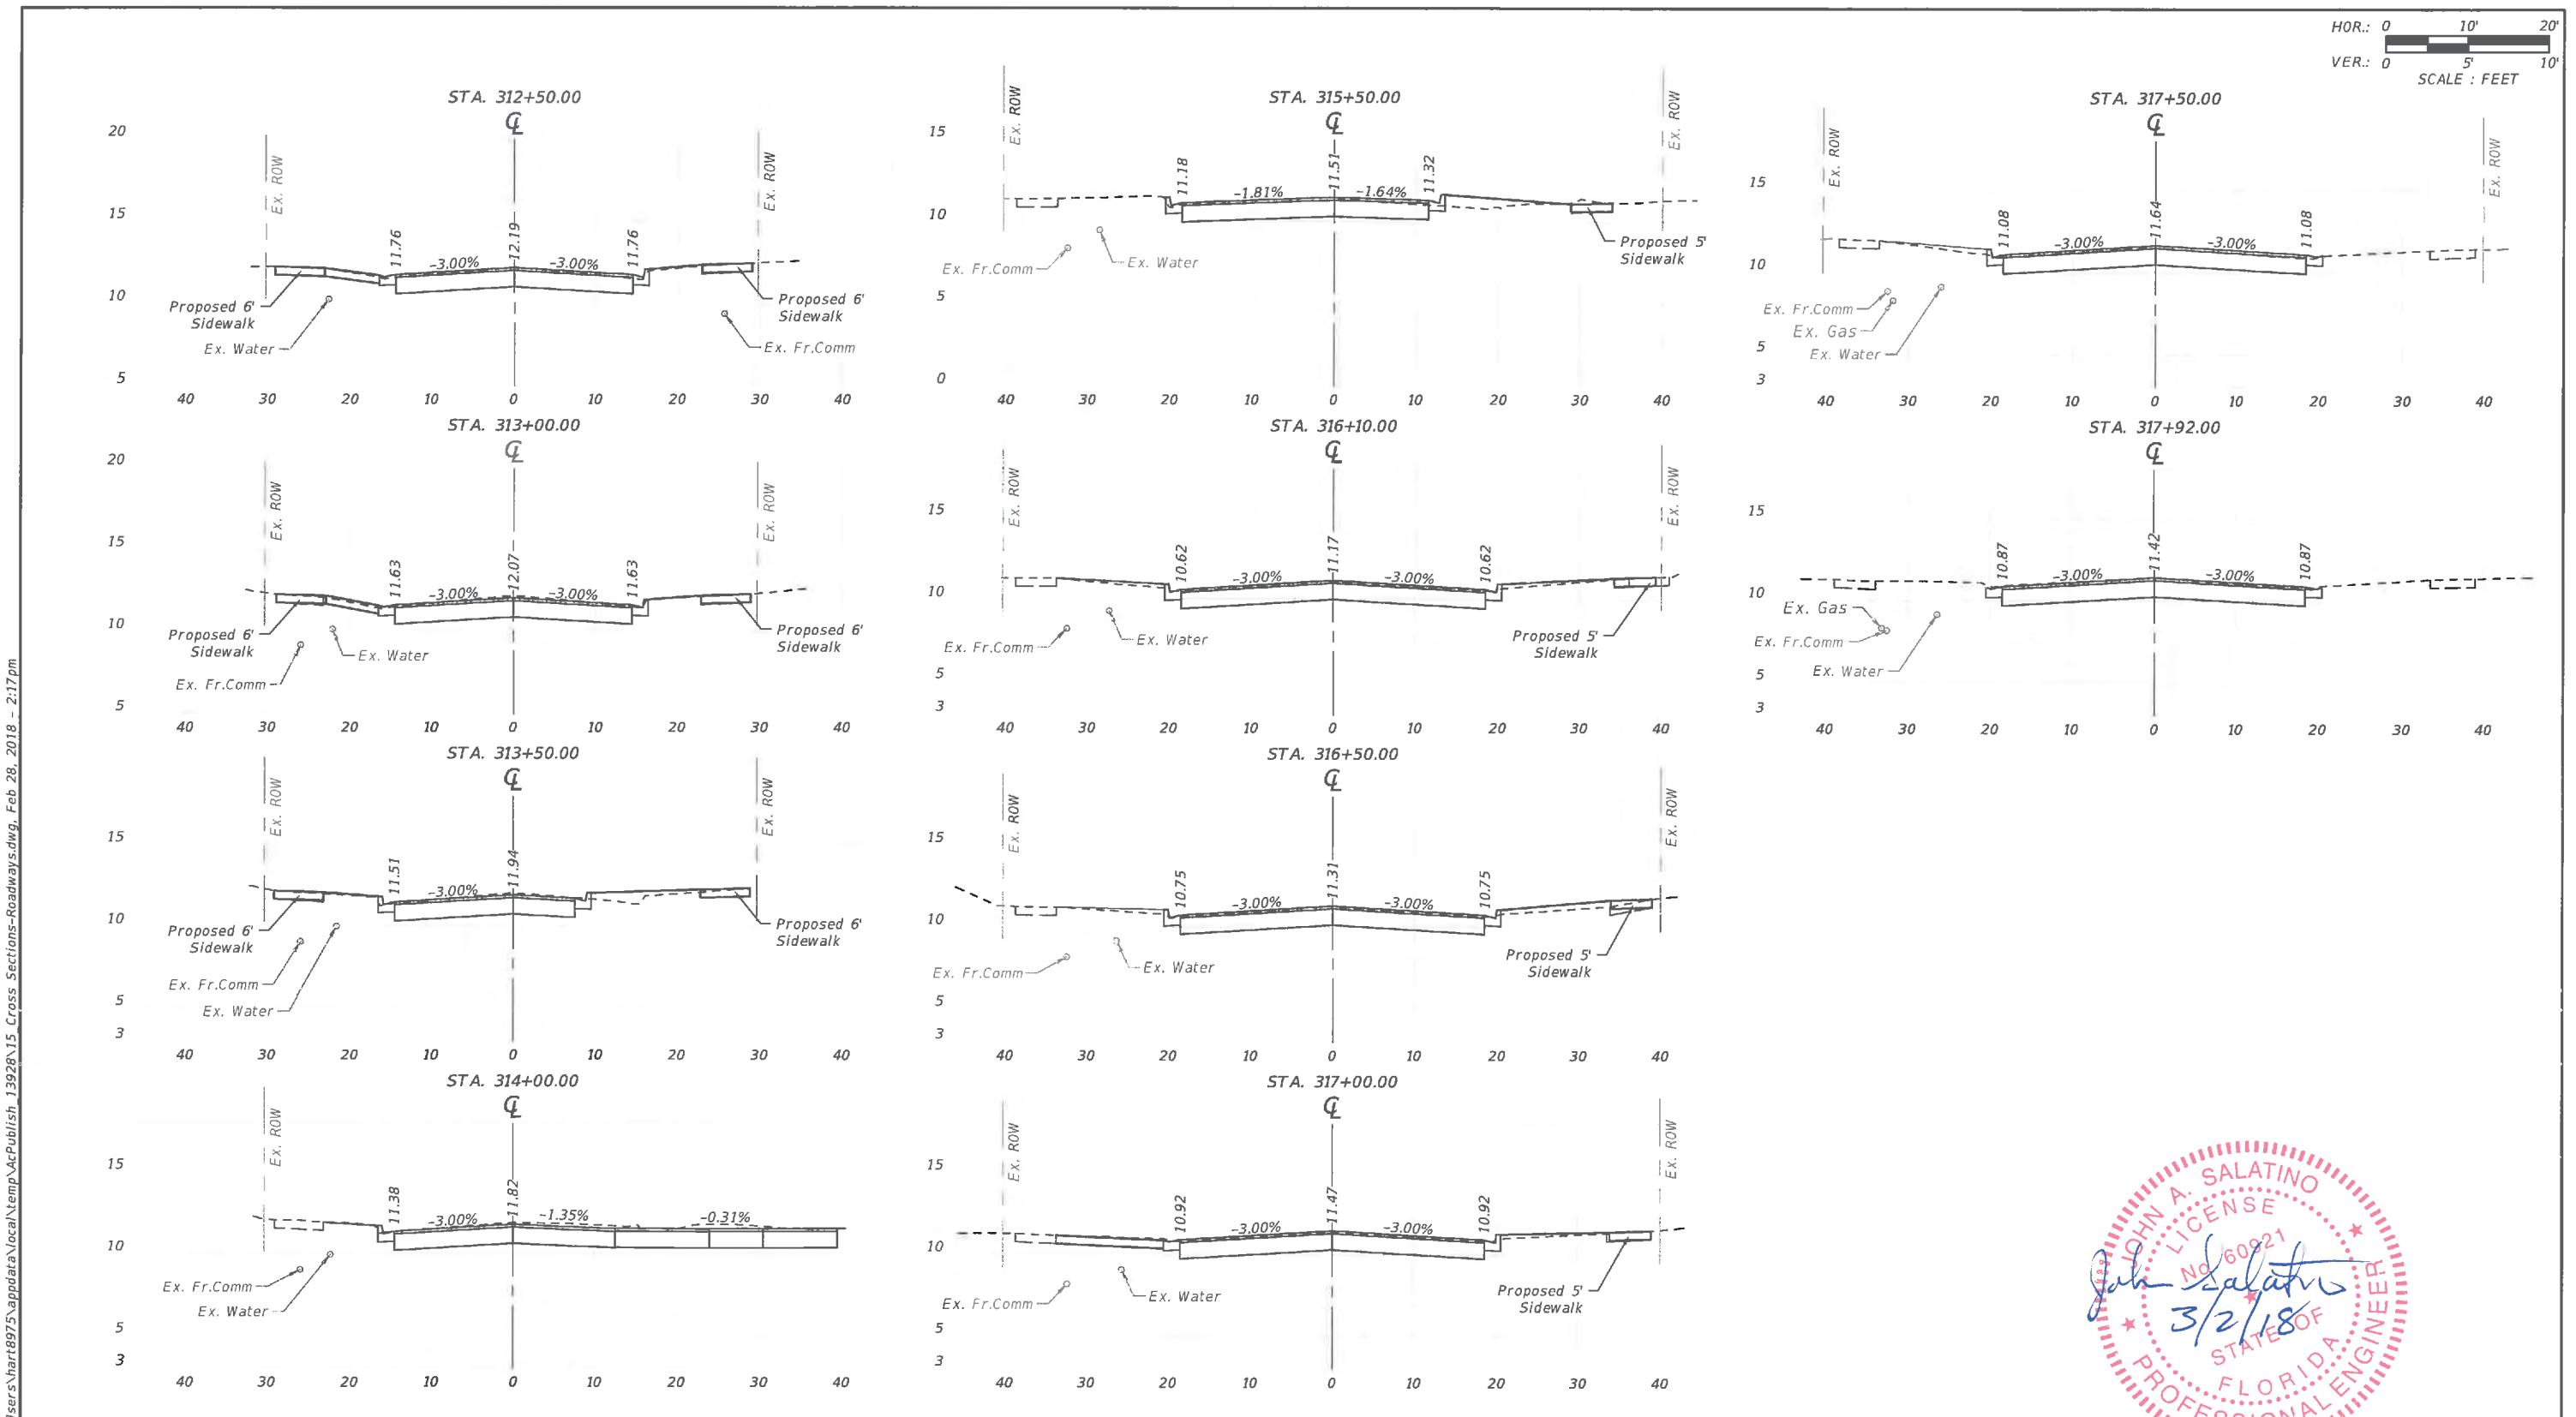



**UTILITIES NOTES:**












LOCATIONS AND DEPTHS ARE APPROXIMATE, THE SIZES  
SHOWN ARE NOT NECESSARILY REPRESENTATIVE OF  
ACTUAL CONDITIONS, CONFIGURATION AND LOCATIONS.  
REFER TO ADDITIONAL NOTES IN THE GENERAL NOTES  
SHEET IN THE PLANS.

				PREPARED FOR:	PREPARED BY:	PROJECT:	DESCRIPTION:	APPROVED BY:	DATE:
				DESIGNED MLM	DRAWN MA	CITY OF VENICE DOWNTOWN ROADWAY CORRIDOR IMPROVEMENTS	MIAMI AVE. CROSS SECTIONS	JOHN SALATINO, P.E. P.E. LICENSE NUMBER 60921	2/28/2018
				DRAWN MA	ATKINS			ATKINS NORTH AMERICA (CERT. OF AUTH. NO. 24) 4030 WEST BOY SCOUT BOULEVARD, SUITE 700 TAMPA, FL 33607-1712	
				CHECKED MLM				SHEET: 65	PROJECT NO.: 100054389
Page 954 of 1140				REV. NO.	DATE	DESCRIPTION			

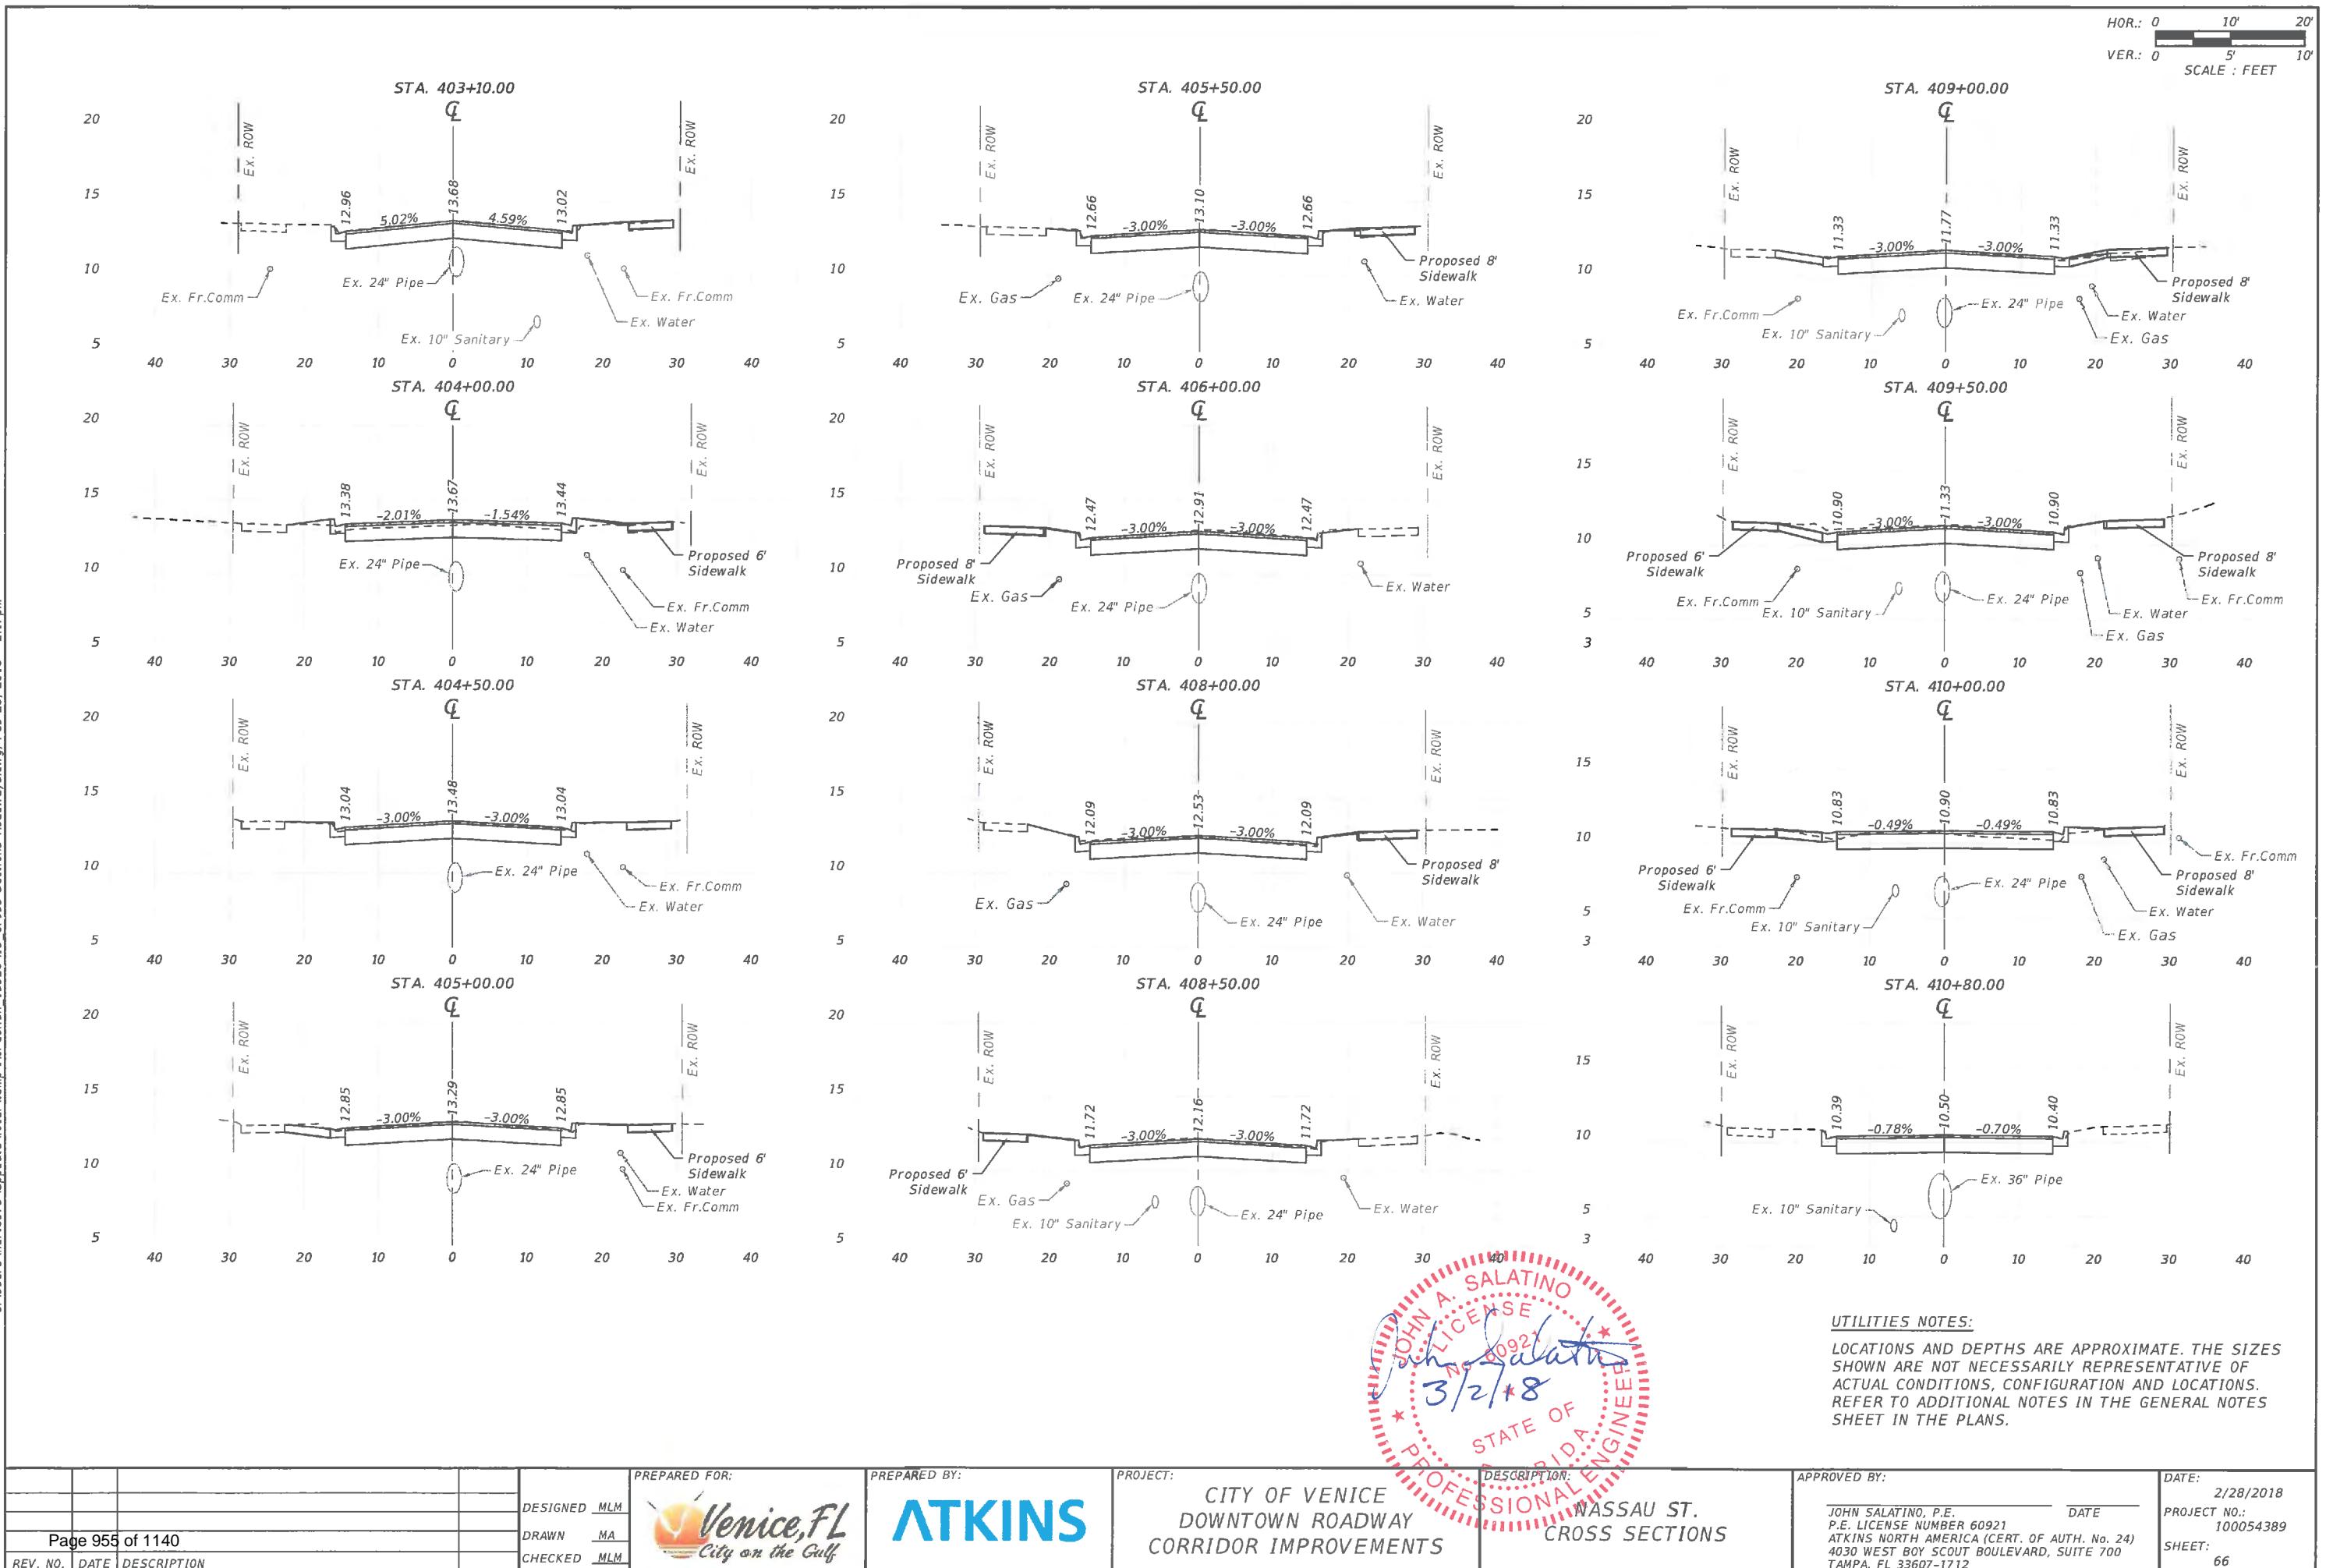






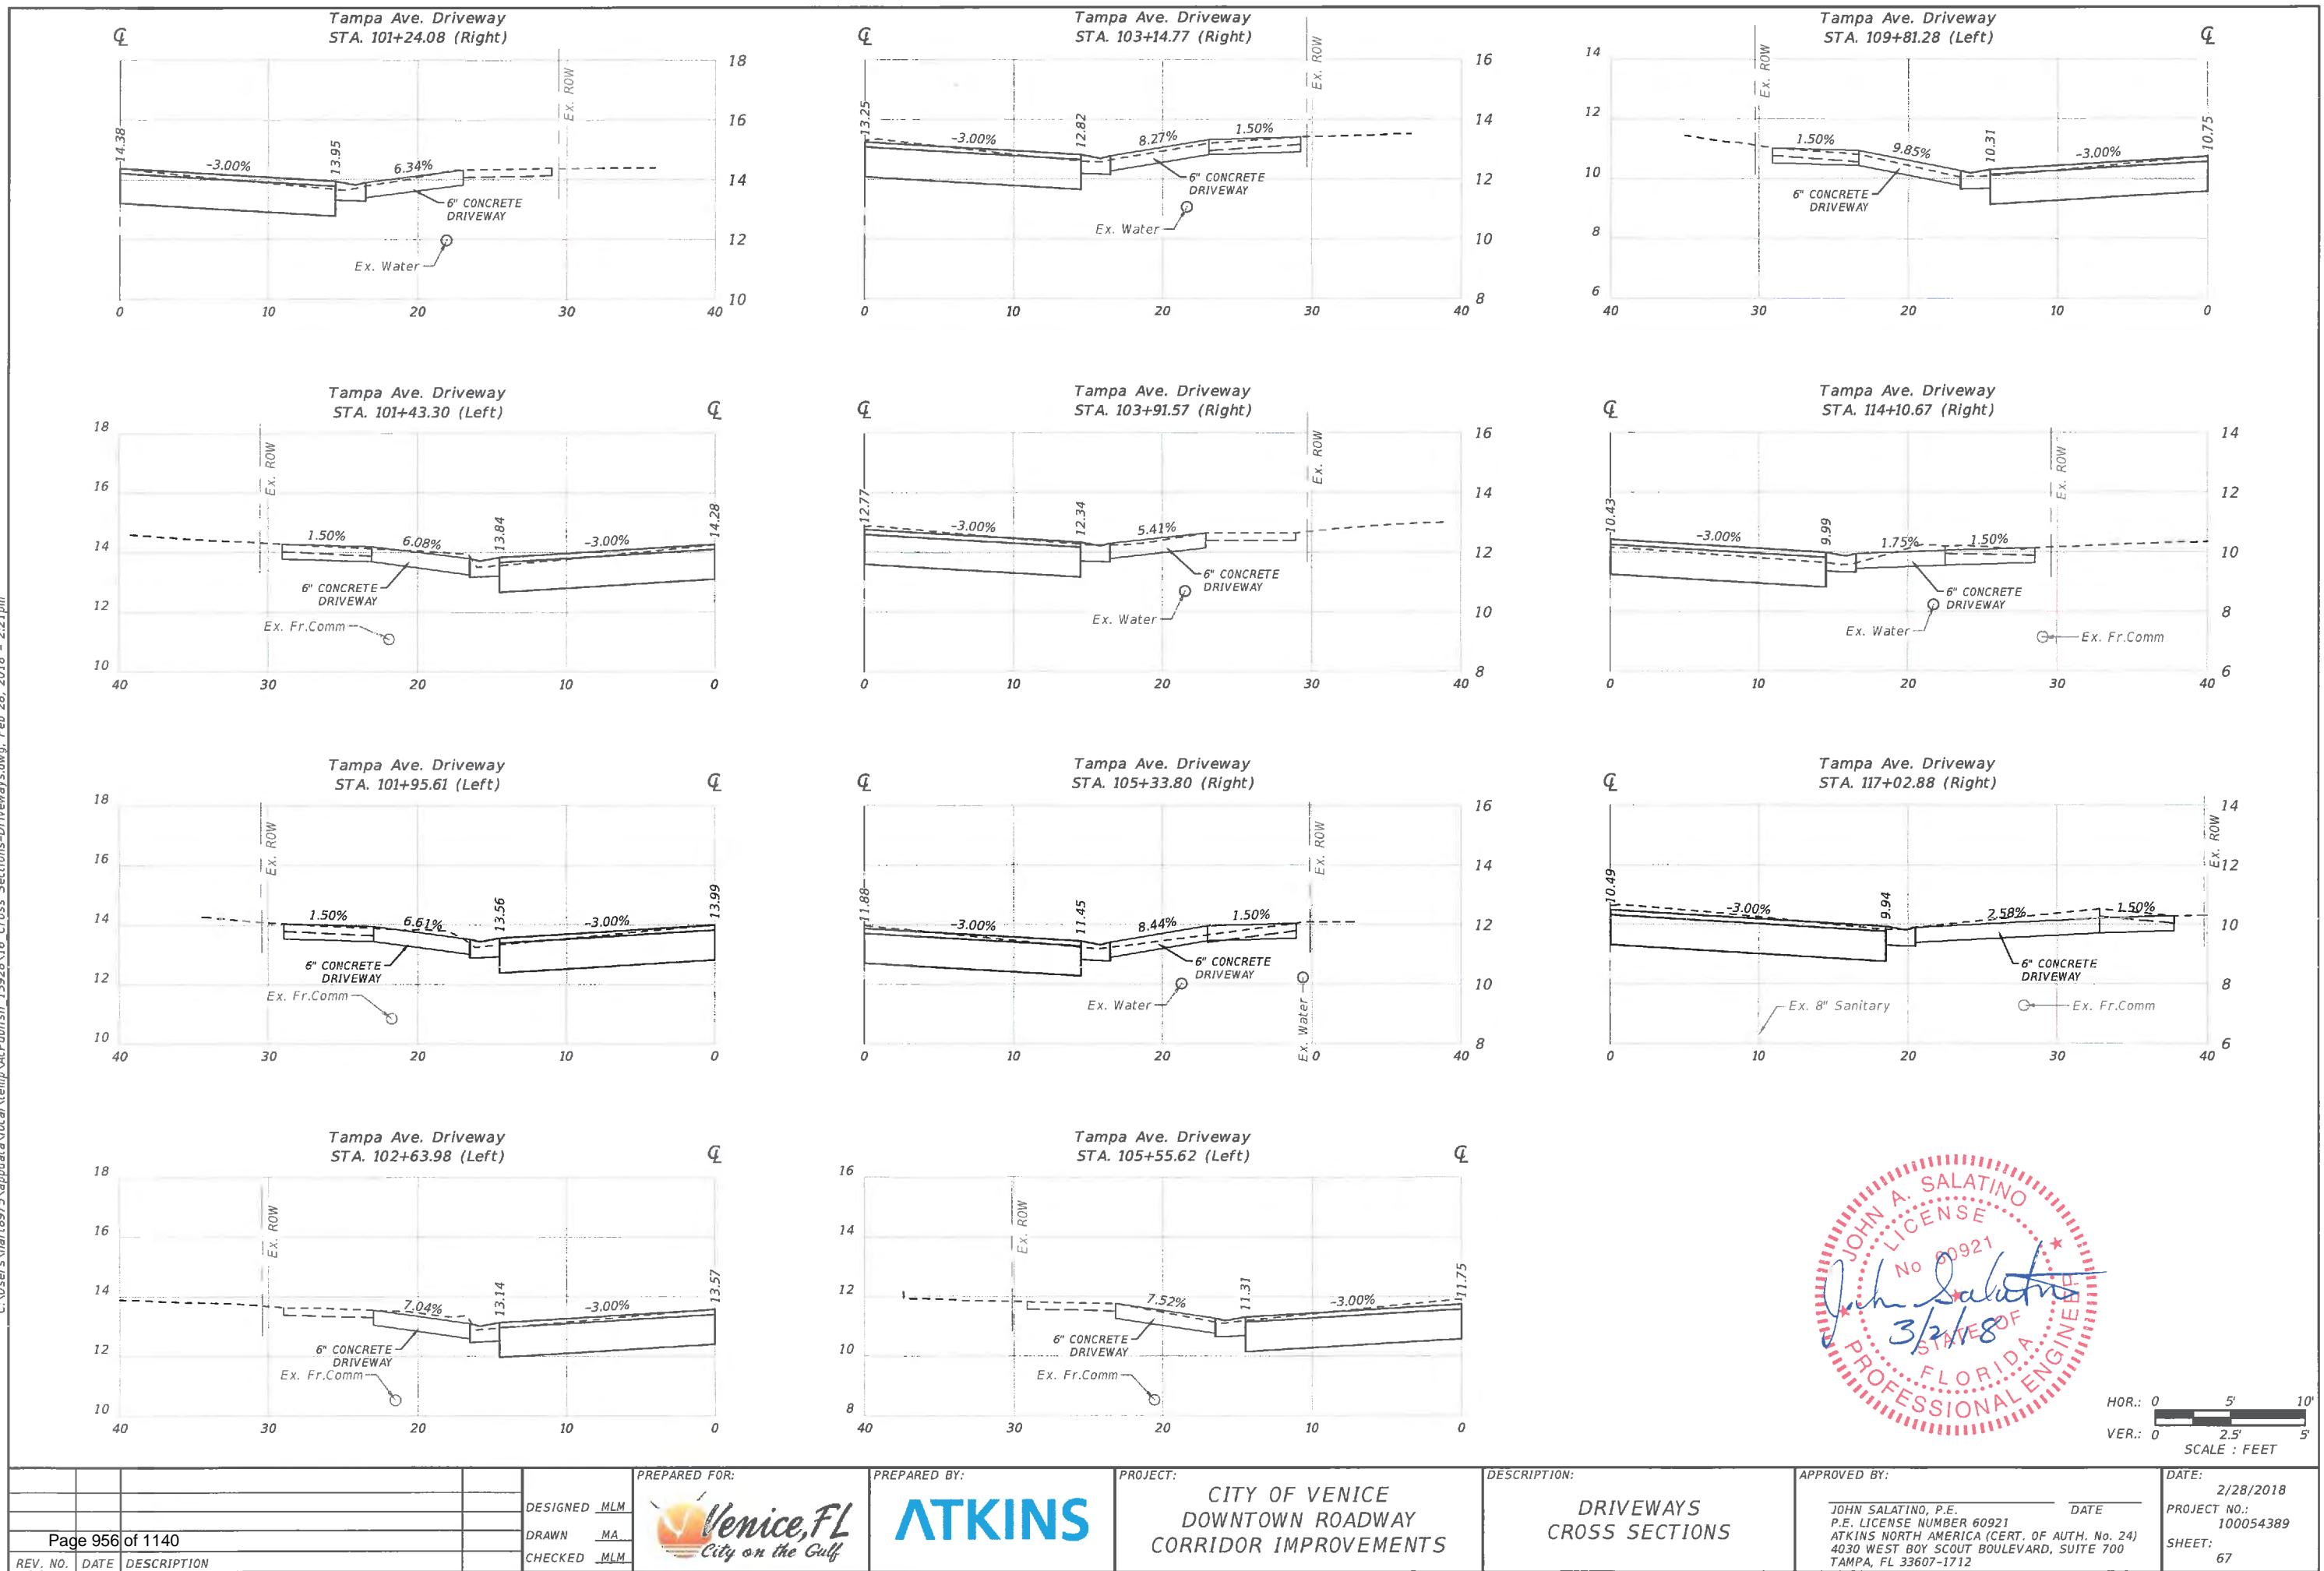


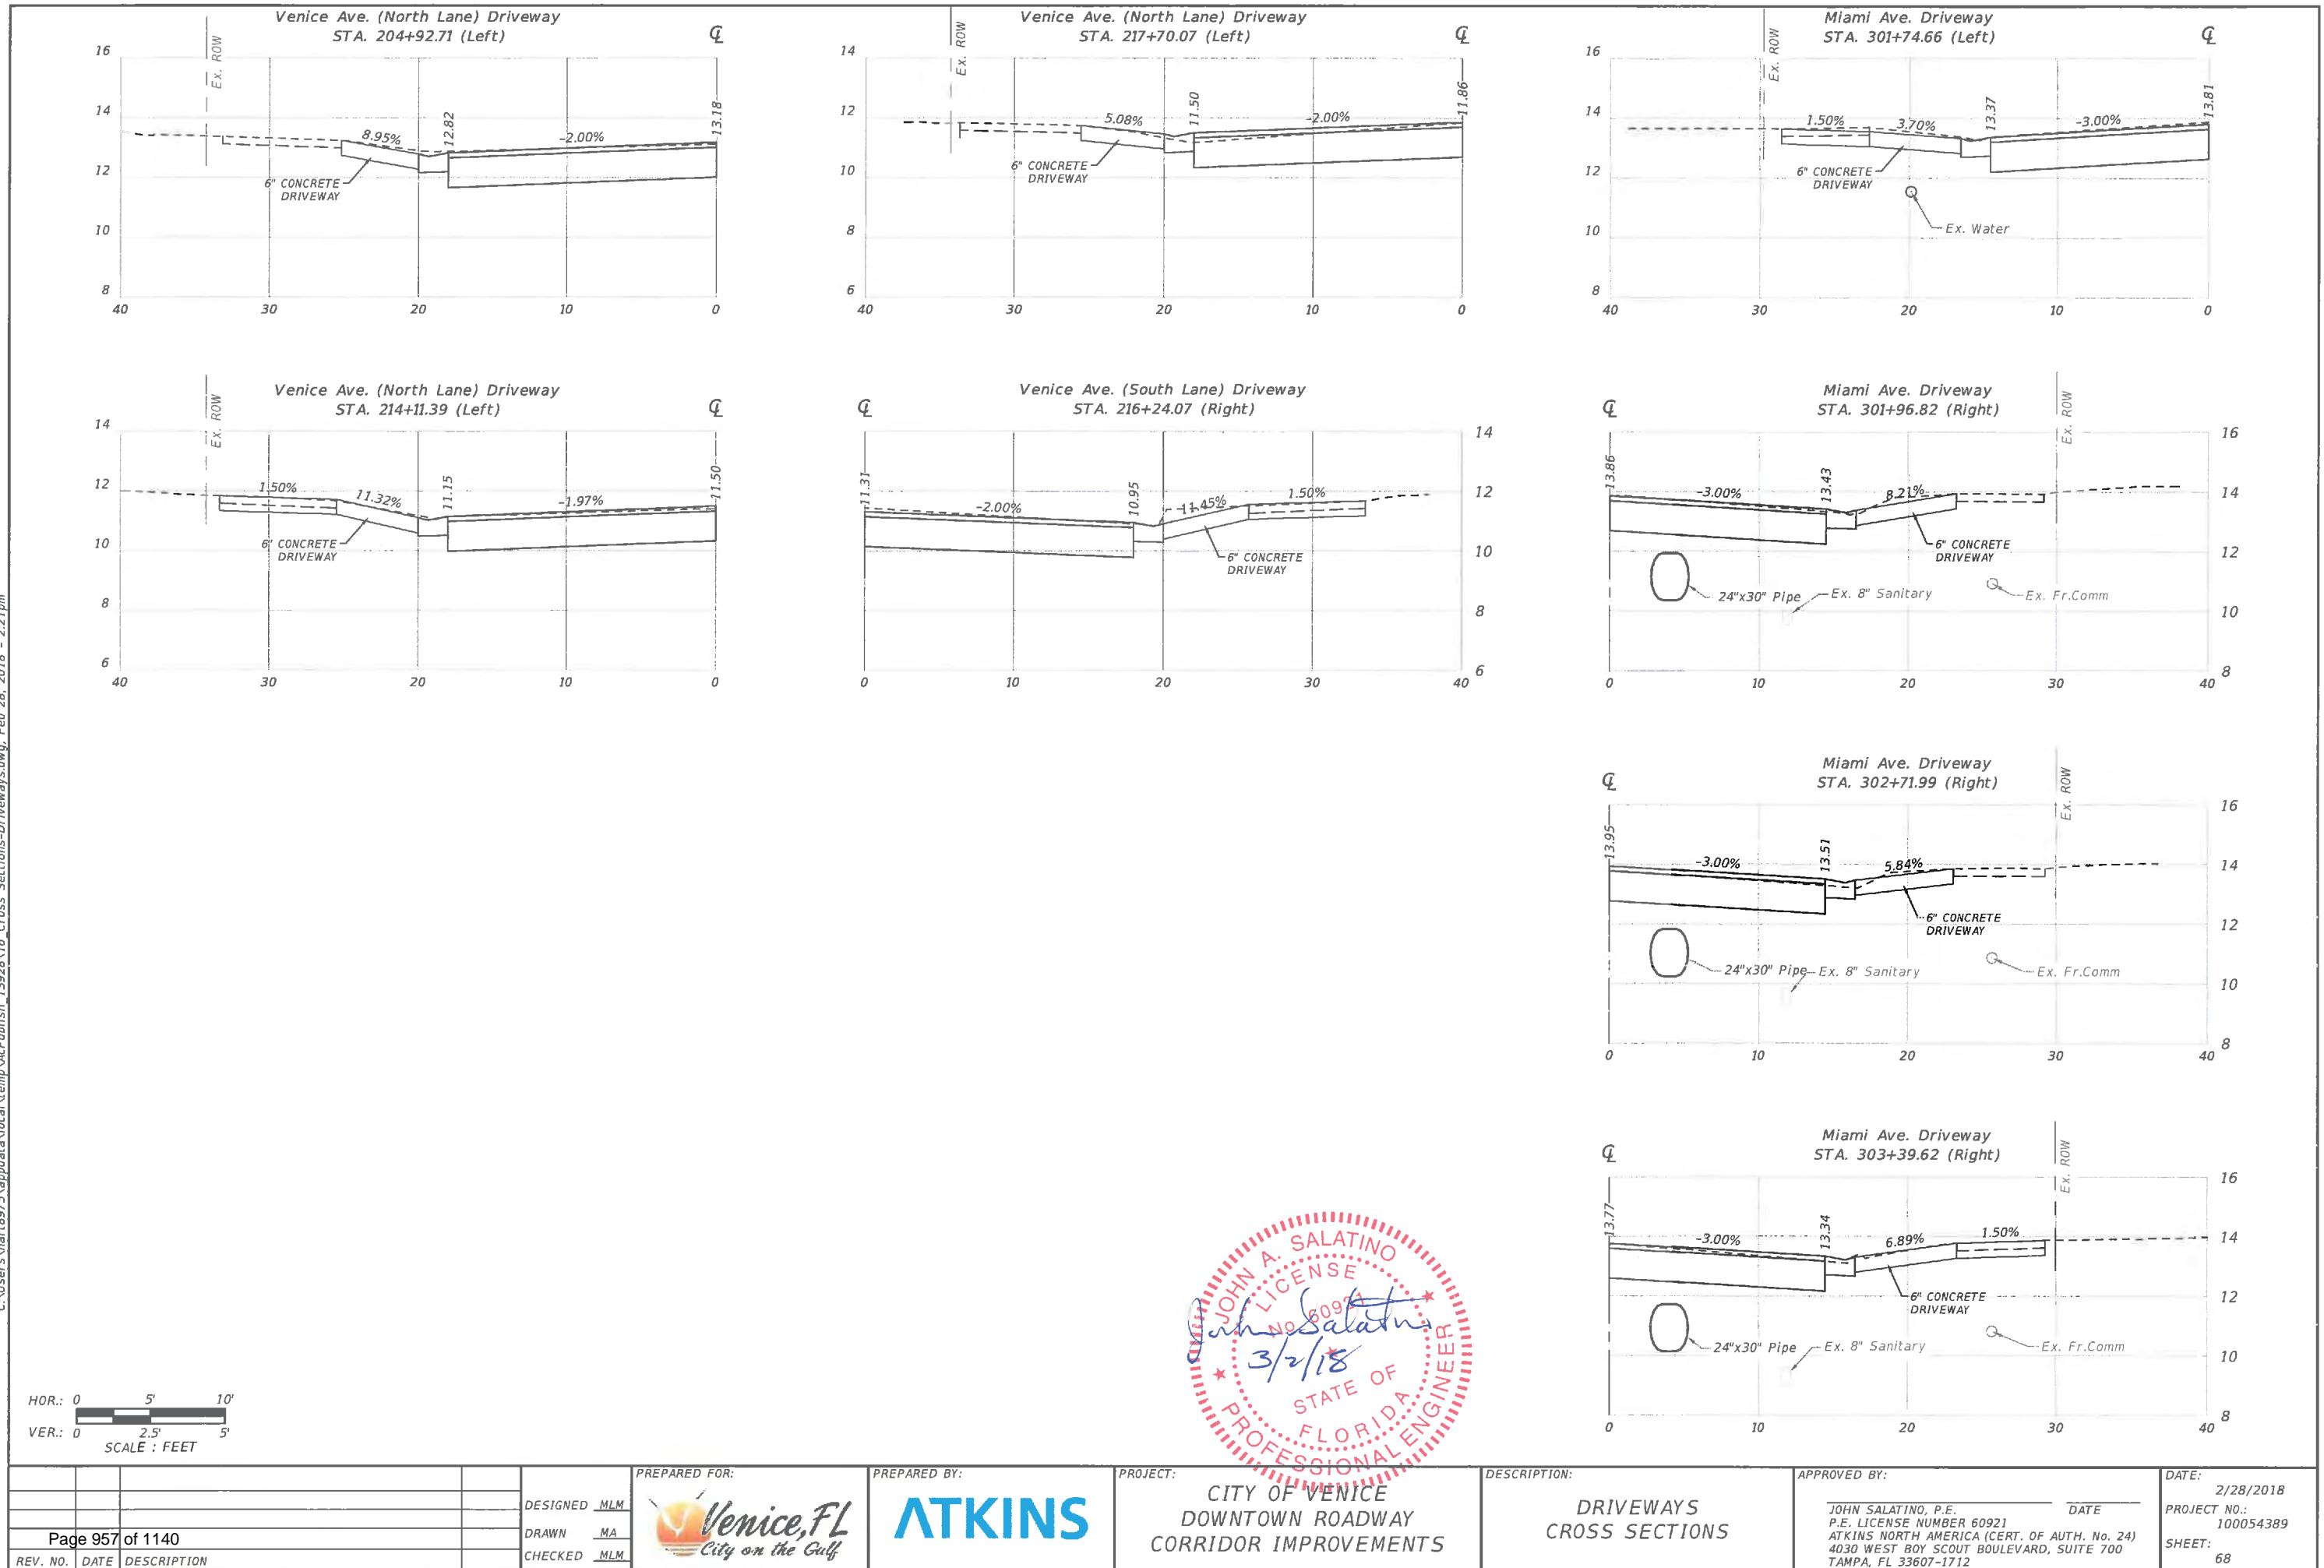

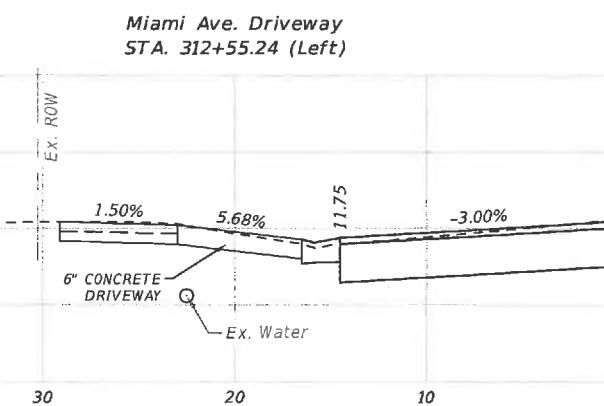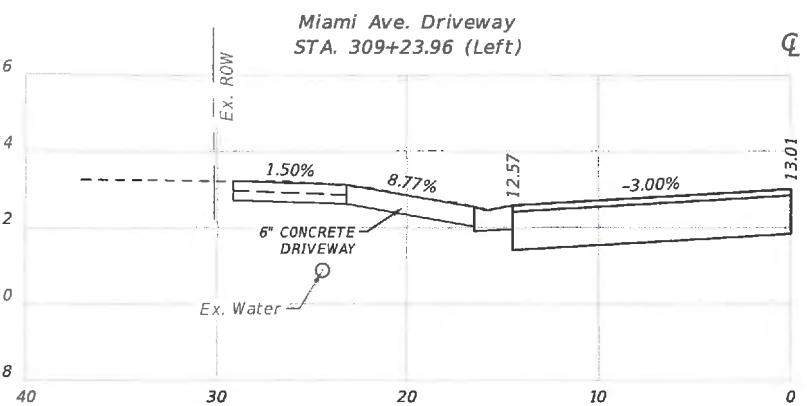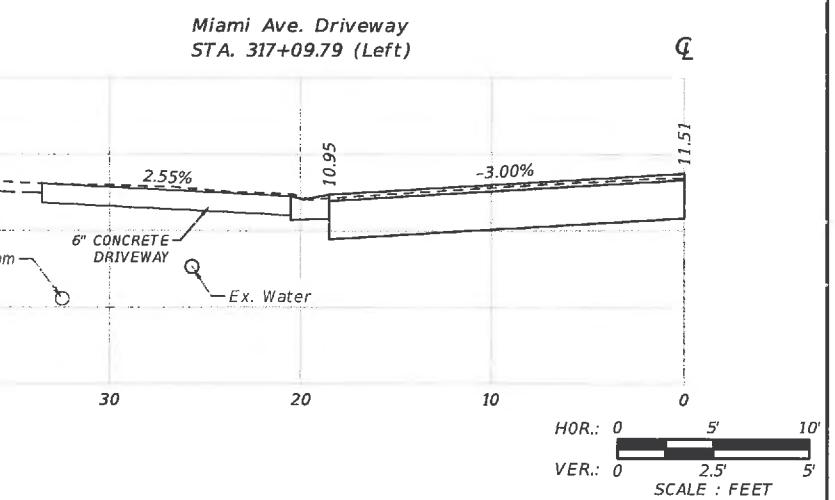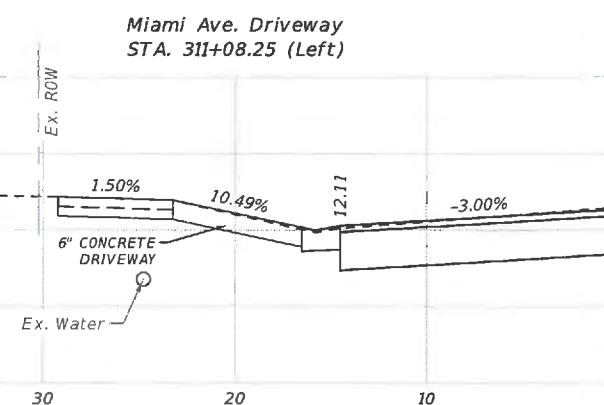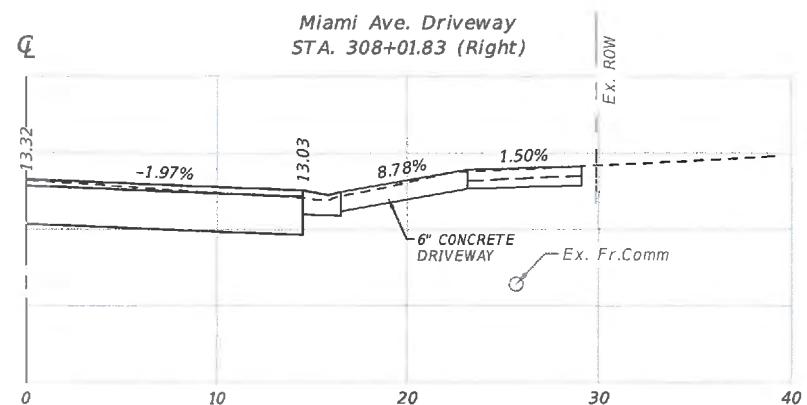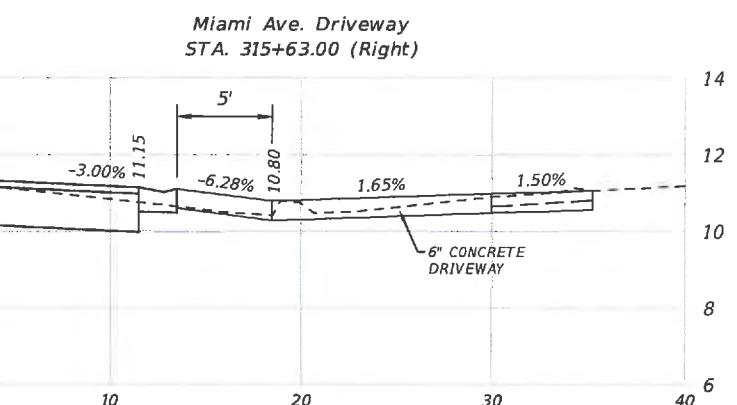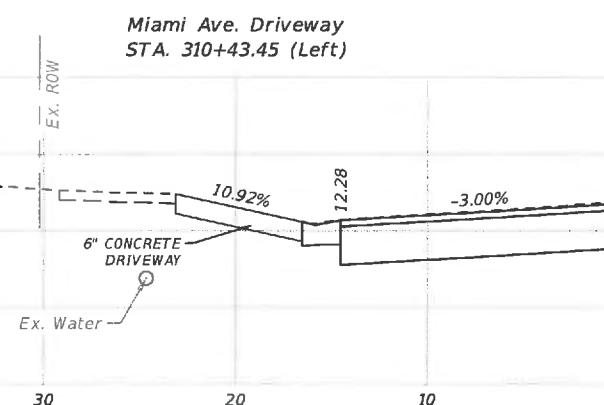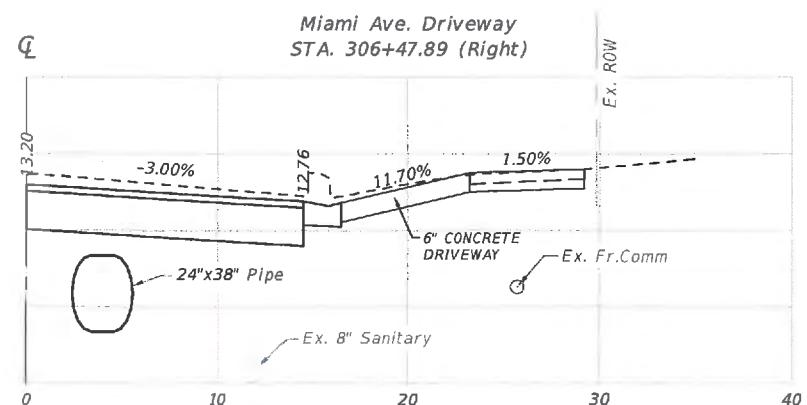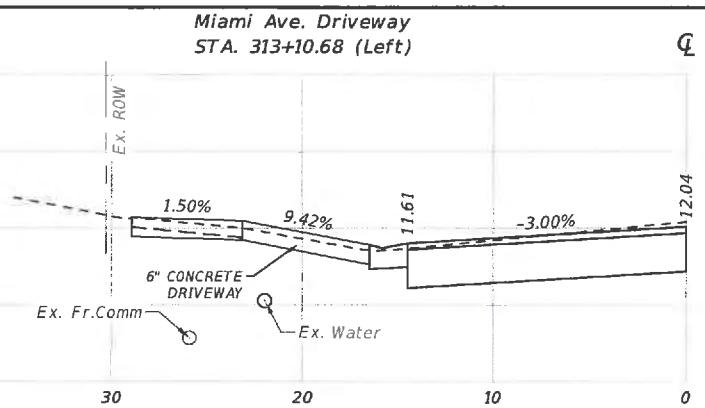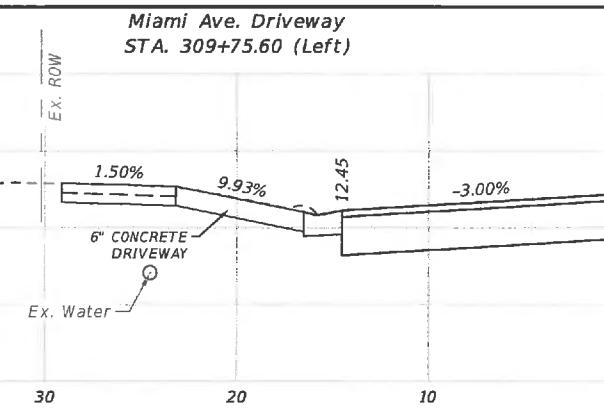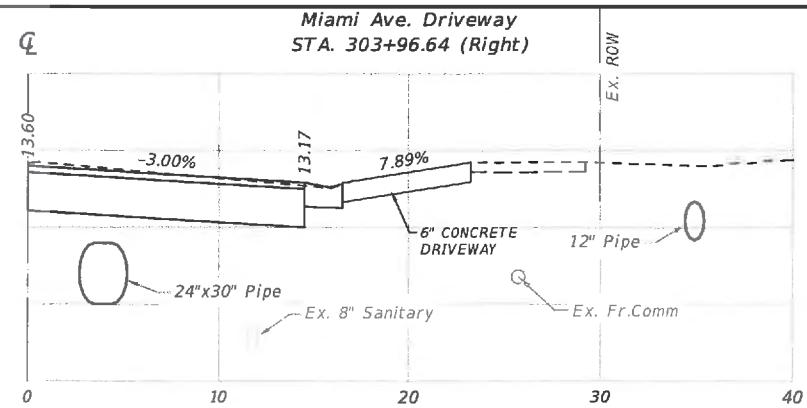

A circular red seal for a Florida driver's license. The outer ring contains the words "JOHN A. SALATINO" at the top and "LICENSE" at the bottom, separated by a dotted line. The inner circle features a signature of "John Salatino" over the date "3/2/18". Below the date, it says "STATE OF FLORIDA". At the bottom, it says "PROFESSIONAL ENGINEER". The entire seal is surrounded by a red border.

				PREPARED FOR:	PREPARED BY:	PROJECT:	DESCRIPTION:	APPROVED BY:	DATE:
				DESIGNED MLM		CITY OF VENICE	DRIVEWAYS	JOHN SALATINO, P.E.	2/28/2018
				DRAWN MA	ATKINS	DOWNTOWN ROADWAY	CROSS SECTIONS	P.E. LICENSE NUMBER 60921	DATE
				CHECKED MLM		CORRIDOR IMPROVEMENTS		ATKINS NORTH AMERICA (CERT. OF AUTH. NO. 24)	PROJECT NO.: 100054389
Page 958 of 1140								4030 WEST BOY SCOUT BOULEVARD, SUITE 700	SHEET: 69
REV. NO.	DATE	DESCRIPTION						TAMPA, FL 33607-1712	

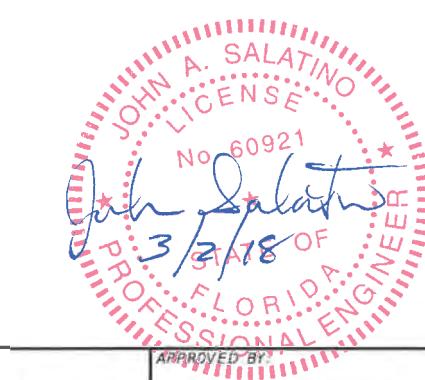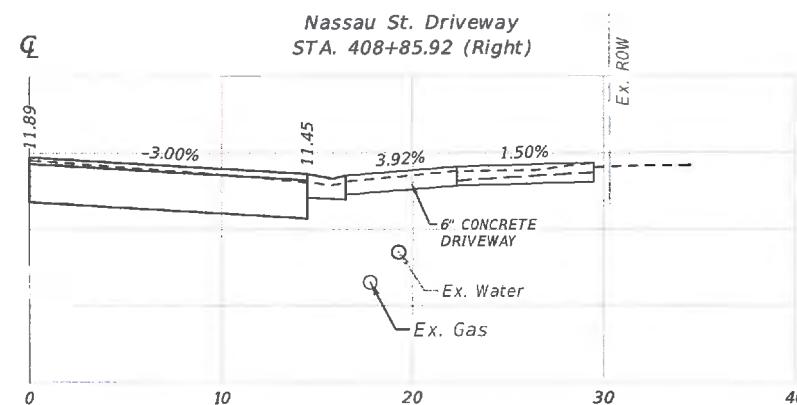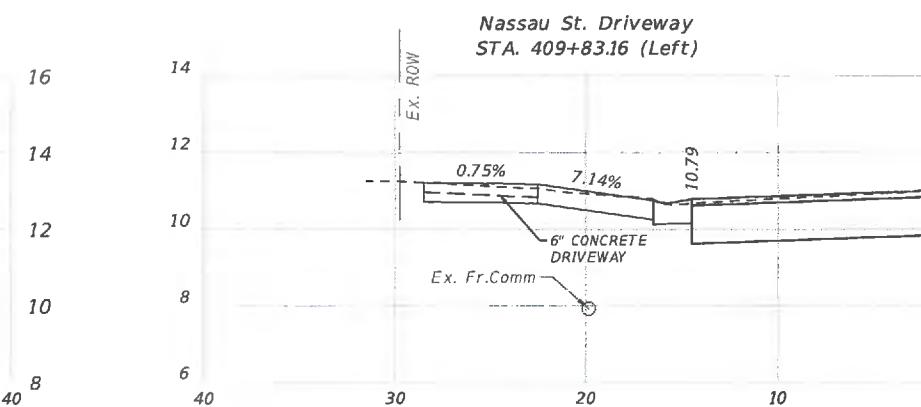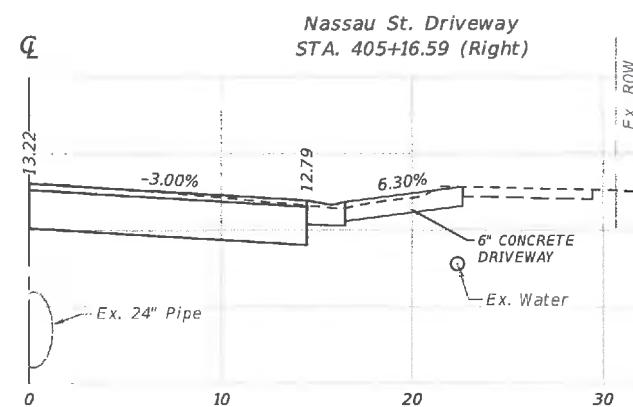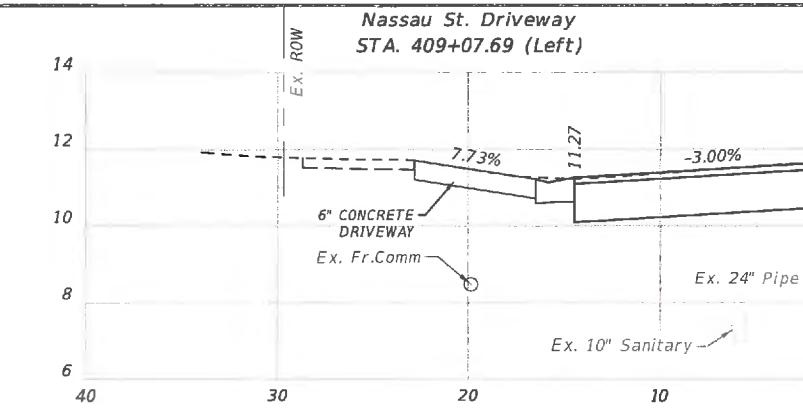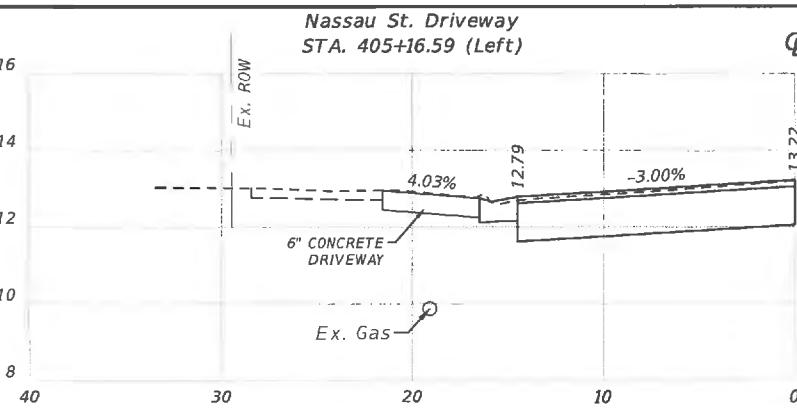


HOR.: 0 5' 10'  
VER.: 0 2.5' 5'  
SCALE: 1 FEET  
DATE: 2/28/2018  
PROJECT NO.: 100054389  
SHEET: 70

PREPARED FOR:	PREPARED BY:	PROJECT:	DESCRIPTION:	APPROVED BY:	DATE:
DESIGNED MLM	DRAWN MA	ATKINS	CITY OF VENICE DOWNTOWN ROADWAY CORRIDOR IMPROVEMENTS	DRIVEWAYS CROSS SECTIONS	JOHN SALATINO, P.E. P.E. LICENSE NUMBER 60921 ATKINS NORTH AMERICA (CERT. OF AUTH. NO. 24) 4030 WEST BOY SCOUT BOULEVARD, SUITE 700 TAMPA, FL 33607-1712
DRAINED MA	MA	Venice, FL City on the Gulf	REV. NO. DATE DESCRIPTION	DATE	2/28/2018
CHECKED MLM	MLM			PROJECT NO.	100054389

## TEMPORARY TRAFFIC CONTROL GENERAL NOTES

1. THE CONTRACTOR SHALL MAINTAIN TRAFFIC IN COMPLIANCE WITH THE FOLLOWING DOCUMENTS:
  - a. FHWA 2009 EDITION "MANUAL ON UNIFORM TRAFFIC CONTROL DEVICES" (AKA MUTCD)
2. THE CONTRACTOR SHALL MAINTAIN SAFE PEDESTRIAN ACCESS TO EXISTING SIDEWALKS UTILIZING FDOT INDEX 660. SIDEWALK ACCESS IS TO BE MAINTAINED ALONG ONE SIDE (MINIMUM) OF EACH STREET THROUGHOUT CONSTRUCTION. PEDESTRIAN ACCESS TO BUSINESS ENTRANCES SHALL BE PROVIDED AND MAINTAINED DURING BUSINESS OPERATING HOURS (MON-FRI AND WEEKENDS) THROUGHOUT CONSTRUCTION. SEE PEDESTRIAN DETOUR DETAIL FOR IMPLEMENTATION OF INDEX 660.
3. USE FDOT DESIGN STANDARDS INDEX 600, 603, 613 AND THE MUTCD FOR TRAVEL LANE CONSTRUCTION AND USE FDOT DESIGN STANDARDS INDEX 604, 605, 606, 615, 616 AND THE MUTCD FOR INTERSECTION CONSTRUCTION.
4. EXISTING REGULATORY AND WARNING SIGNS WITHIN THE PROJECT LIMITS SHALL BE MAINTAINED AT ALL TIMES UNLESS OTHERWISE DIRECTED BY THE ENGINEER.
5. THE EXISTING REGULATORY SPEEDS ALONG THE CITY STREETS SHALL BE MAINTAINED FOR THE WORK ZONE SPEEDS.
6. THE MINIMUM LANE WIDTH FOR TEMPORARY LANES DURING CONSTRUCTION IS 10 FEET UNLESS OTHERWISE SHOWN ON THE PLANS.
7. THE CONTRACTOR SHALL PROVIDE TWO-WAY ACCESS (INGRESS/EGRESS) TO ALL EXISTING PROPERTIES AT ALL TIMES DURING CONSTRUCTION. STAGE CONSTRUCTION MAY BE REQUIRED.
8. MAINTAIN ALL DRIVEWAY AND PARKING LOT ACCESS AT ALL TIMES. IF A DRIVEWAY CLOSURE AT NIGHT CANNOT BE ACCOMPLISHED WITH OWNER APPROVAL, AN ALTERNATIVE ACCESS MUST BE PROVIDED AND MAINTAINED AT ALL TIMES. SIDE ROAD ACCESS SHALL BE COORDINATED WITH SIDE ROAD CONSTRUCTION.
9. THE CONTRACTOR SHALL RESTORE SAFE ROADSIDE CONDITIONS AT THE END OF EACH WORK PERIOD IN ACCORDANCE WITH FDOT INDEX 600 (ALL DROPOFF CONDITIONS SHALL BE ADDRESSED).
10. CONTRACTOR SHALL ONLY UTILIZE PROPOSED TEMPORARY WATER-FILLED BARRIER WALL THAT ARE LISTED ON THE CURRENT FDOT APPROVED PRODUCTS LIST (APL). THIS LIST CAN BE FOUND AT <https://fdotwp1.dot.state.fl.us/ApprovedProductList/ProductTypes/Index/100> CONTRACTOR SHALL COMPLY WITH THE MANUFACTURER'S INSTRUCTIONS SHOWN ON THE FDOT APPROVED DRAWINGS.
11. ANY CONFLICTING EXISTING PAVEMENT MARKINGS AND SIGNS OUTSIDE THE CONSTRUCTION AREA SHALL BE REMOVED OR COVERED. THE COST FOR REMOVING, COVERING, RESTORING OR REPLACING THESE MARKINGS AND SIGNS SHALL BE INCLUDED IN PAY ITEM 102-1 MAINTENANCE OF TRAFFIC (LS).
12. ALL TRAFFIC CONTROL DEVICES NECESSARY FOR ANY ACTIVITY SHALL BE PLACED BEFORE REDIRECTING TRAFFIC.
13. NIGHT-TIME WORK IS ANTICIPATED ON THE PROJECT TO MINIMIZE DISRUPTIONS TO EXISTING BUSINESSES AND TRAFFIC. CONTRACTOR SHALL PREPARE A PROPER LIGHTING PLAN FOR FLAGGER OPERATIONS DURING NIGHT-TIME HOURS AND OBTAIN CITY APPROVAL PRIOR TO IMPLEMENTATION.
14. THE SEQUENCE OF CONSTRUCTION AND METHODS IN THIS TRAFFIC CONTROL PLAN (TCP) IS A SUGGESTED MAINTENANCE OF TRAFFIC SCHEME. THE CONTRACTOR MAY SUBMIT, AT HIS EXPENSE, AN ALTERNATIVE TRAFFIC CONTROL PLAN FOR CONSIDERATION OF APPROVAL. AN ALTERNATIVE TCP MUST BE SUBMITTED PRIOR TO CONSTRUCTION AND BE SIGNED/SEALED FOR A FLORIDA REGISTERED PROFESSIONAL ENGINEER WHO HAS A CURRENT CERTIFICATION WITH THE FLORIDA DEPARTMENT OF TRANSPORTATION AND HAS PASSED THE ADVANCED MAINTENANCE-OF-TRAFFIC PLAN DESIGN COURSE. ALTERNATIVE TCP MUST BE EQUIVALENT IN PROVIDING SAFE TRAVEL BY ALL MODES OF TRAVEL AND MUST COMPLY WITH DOCUMENTS IN NOTE 1.
15. CLOSE THE NB AND SB TRAVEL LANES ON NASSAU ST. N AND NOKOMIS AVE. S. FOR THROUGH TRAFFIC WHILE MAINTAINING THE ROADWAYS AS DRIVEWAY, PARKING LOT AND ALLEY WAY ACCESS WITH TYPE III BARRICADES. SIGNS WITH THE WORDING "ROAD CLOSED TO THRU TRAFFIC" SHALL BE PLACED ON THE BARRICADES PER FDOT DESIGN STANDARDS 600 SERIES AND THE MUTCD.
16. ADDITIONAL LANE CLOSURES NOT SHOWN IN THE TTC PLANS SHALL ONLY OCCUR DURING THE HOURS OF 8:30 P.M. TO 6:00 A.M.
17. BULBOUT CONSTRUCTION TO BE CONSTRUCTED AFTER ALL DRAINAGE STRUCTURES HAVE BEEN COMPLETED USING FDOT DESIGN STANDARD INDEX 603 OR INDEX 613.


MINIMUM ADVANCED SIDE STREET SIGNAGE TO BE USED ON US41 OR HARBOR DRIVE. PCMS SIGNS TO SUPPLEMENT ADVANCE SIGNAGE (POSTED SPEED ON US41 IS 35 MPH AND HARBOR DRIVE IS 30 MPH)

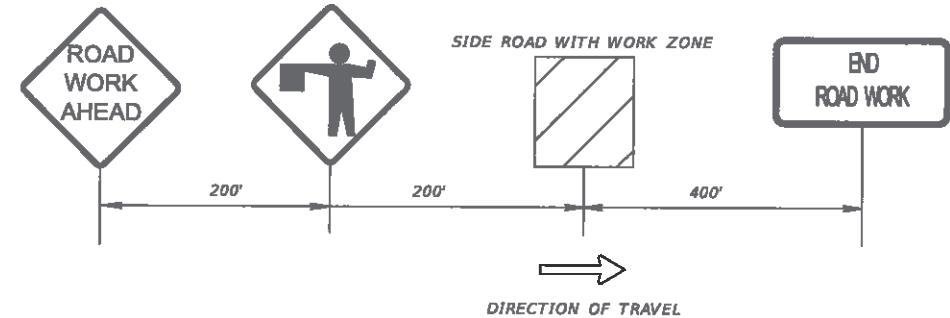

NOTE: FLAGGER SIGN TO BE COVERED ON US 41 OR HARBOR DRIVE WHEN WORK ZONE IS NOT ACTIVE.

PHASE PCMS SIGN MESSAGES TO BE PLACED 14 CALENDAR DAYS IN ADVANCE OF DETOURS PER INDEX 600 AND TTC PLANS

①	NASSAU ST CLOSED FOLLOW DETOUR	②	NOKOMIS ST CLOSED FOLLOW DETOUR	③	TAMPA AVE CLOSED FOLLOW DETOUR	④	MIAMI AVE CLOSED FOLLOW DETOUR	⑤	CONST. TAMPA AVE WB (EB) LANE CLOSURES AHEAD
⑥	CONST. VENICE AVE WB (EB) LANE CLOSURES AHEAD	⑦	CONST. MIAMI AVE WB (EB) LANE CLOSURES AHEAD	⑧	NOKOMIS AVE CLOSED AT MIAMI AVE USE MIAMI DETOUR	⑨	NASSAU AVE CLOSED AT MIAMI AVE USE MIAMI DETOUR		
⑩	NOKOMIS AVE CLOSED AT TAMPA AVE HARBOR DR SOUTH TO VENICE	⑪	NASSAU ST CLOSED AT TAMPA AVE HARBOR DR SOUTH TO VENICE	⑫	WB VENICE CLOSED FOLLOW DETOUR	⑬	EB VENICE CLOSED FOLLOW DETOUR		

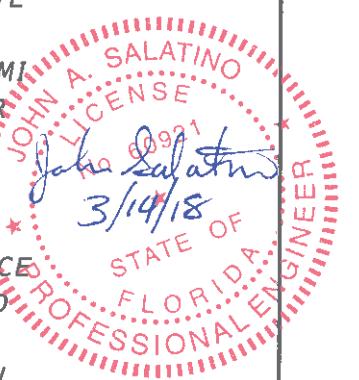


			PREPARED FOR:	PREPARED BY:	PROJECT:	DESCRIPTION:	APPROVED BY:	DATE:
			DESIGNED MLM	Venice, FL City on the Gulf	ATKINS	CITY OF VENICE DOWNTOWN ROADWAY CORRIDOR IMPROVEMENTS	TTCP General Notes	3/13/2018
DRAWN MA								PROJECT NO.: 100054389
CHECKED MLM								SHEET: 71


NOTE:

1. DISTANCES ON THE SCHEMATICS SHOWN BELOW ARE MINIMUMS, AND CONDITIONAL NOTES FOR THE INDEX STILL APPLY TO THE ADVANCED SIGNAGE.
2. EXISTING POSTED SPEEDS FOR VENICE AVENUE IS 20 MPH AND ALL OTHER STREETS EXCEPT US 41 ARE 25 MPH. US 41 IS POSTED 35 MPH.

ADVANCED WARNING SCHEMATIC FOR FDOT DESIGN STANDARDS INDEX 613  
VENICE AVE. ONLY  
(WITH DISTANCES PER PROJECT POSTED SPEEDS)

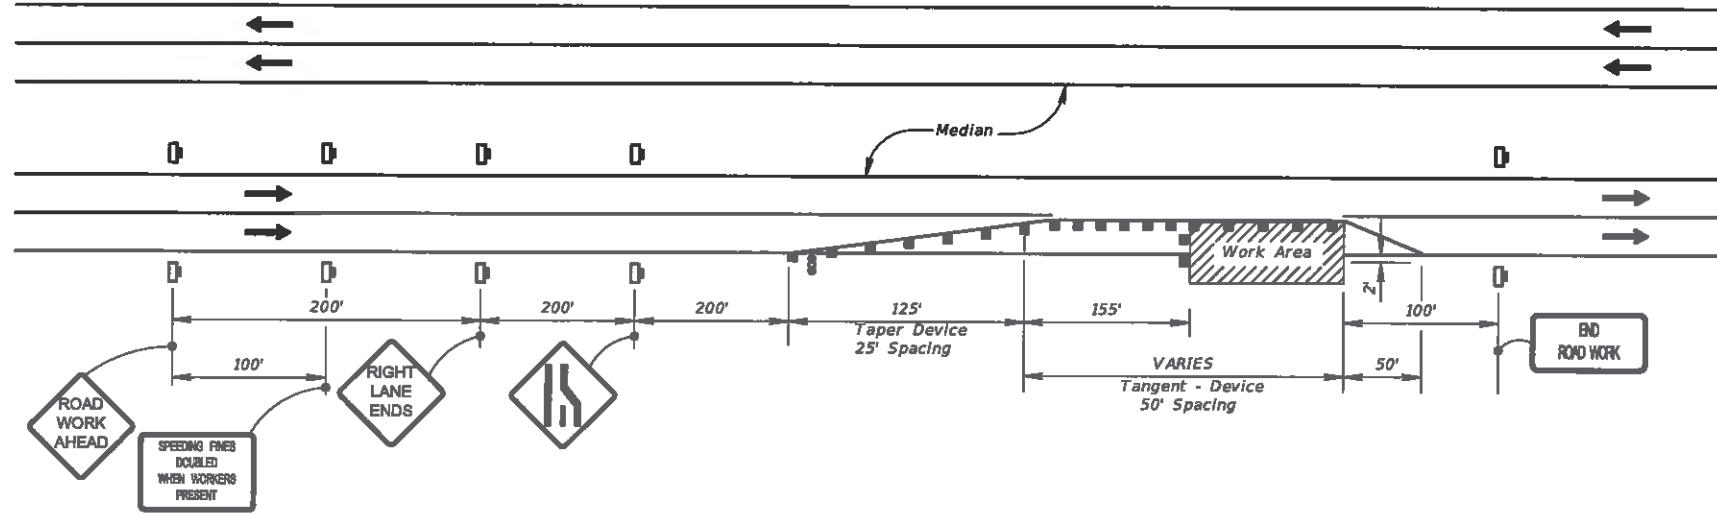

ADVANCED WARNING SCHEMATIC FOR FDOT DESIGN STANDARDS INDEX 603  
ALL OTHER STREETS  
(WITH DISTANCES PER PROJECT POSTED SPEEDS)

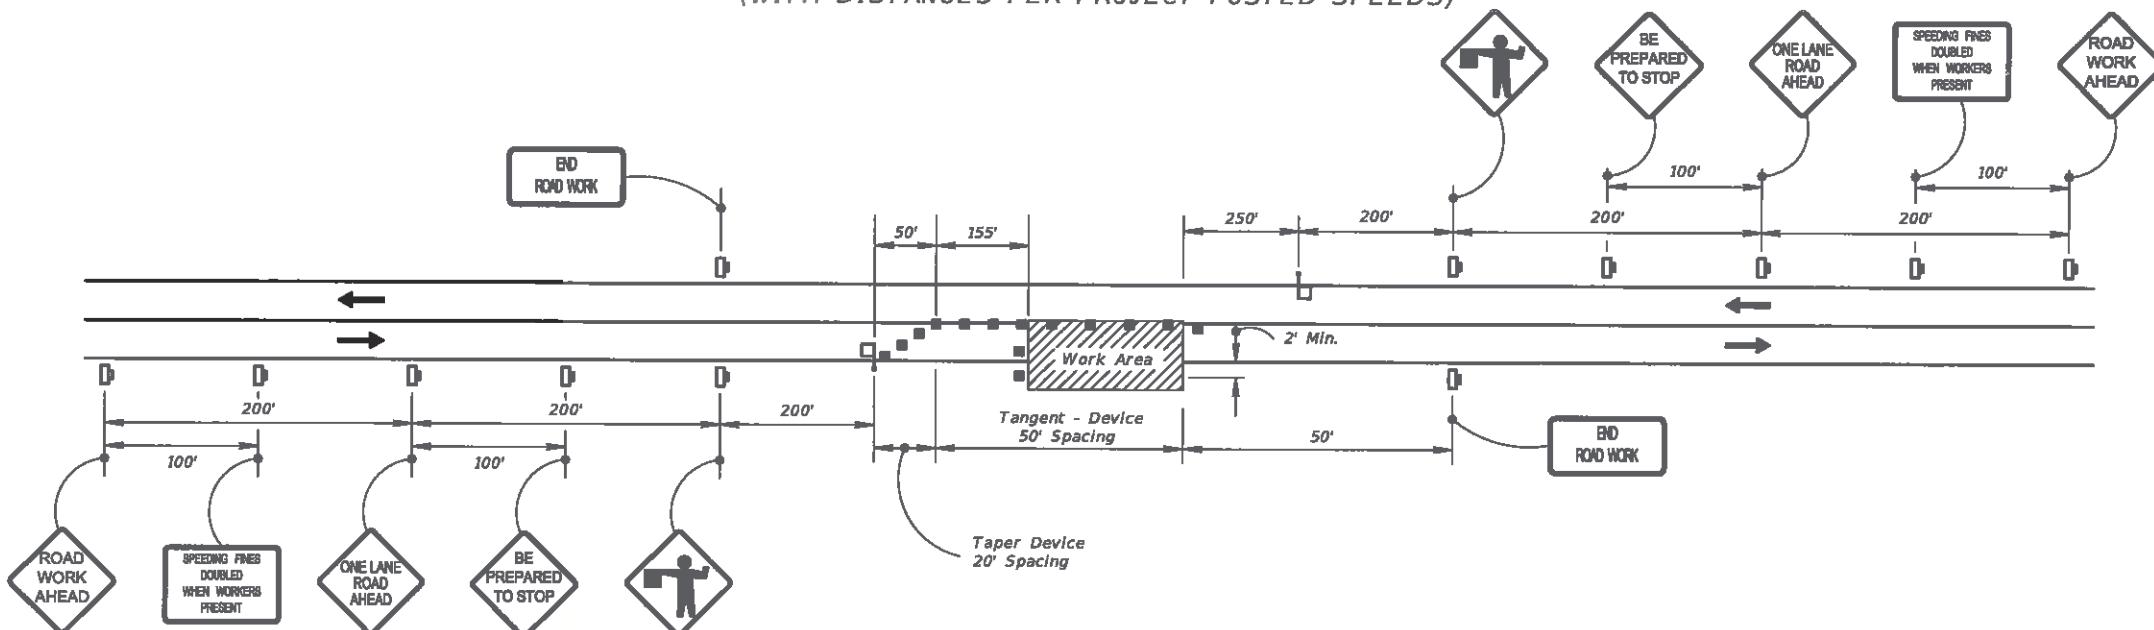

			PREPARED FOR:	PREPARED BY:	PROJECT:	DESCRIPTION:	APPROVED BY:	DATE:
			DESIGNED MLM	Venice, FL City on the Gulf	ATKINS	CITY OF VENICE DOWNTOWN ROADWAY CORRIDOR IMPROVEMENTS	TTCP General Notes	3/13/2018
DRAWN	MA		DRAWN MLM				JOHN SALATINO, P.E. P.E. LICENSE NUMBER 60921 ATKINS NORTH AMERICA (CERT. OF AUTH. NO. 24) 4030 WEST BOY SCOUT BOULEVARD, SUITE 700 TAMPA, FL 33607-1712	DATE PROJECT NO.: SHEET:
CHECKED MLM								100054389 72


**LEGEND**

- Work Zone Sign
- Type III Barricade
- Existing Lane Identification and Direction of Traffic
- Shifted Lane Identification and Direction of Traffic
- Active Work Zone
- Detour Route
- Portable Changeable Messaging Sign

**NOTES:**

1. DETOUR FOR NASSAU ST AND MIAMI AVE OR NOKOMIS AVE AND MIAMI AVE INTERSECTION DRAINAGE STRUCTURE INSTALLATION OR ANY OTHER ACTIVITY ALONG MIAMI AVE. DETOURS SHALL BE LIMITED TO BETWEEN SUNDAY 9 P.M. THROUGH WEDNESDAY 6 A.M. PER INTERSECTION, ANY OTHER USE OF THE DETOUR SHALL BE AT THE DISCRETION OF THE ENGINEER.


2. DETOURS FOR AN INDIVIDUAL INTERSECTION CAN BE ACCOMPLISHED BY MOVING SIGNS SHOWN ON HARBOR TO NASSUA ST FOR NOKOMIS AVE AND MIAMI AVE OR MOVING THE SIGNS ON US41 TO NOKOMIS AVE FOR WORK AT NASSAU ST AND MIAMI AVE.

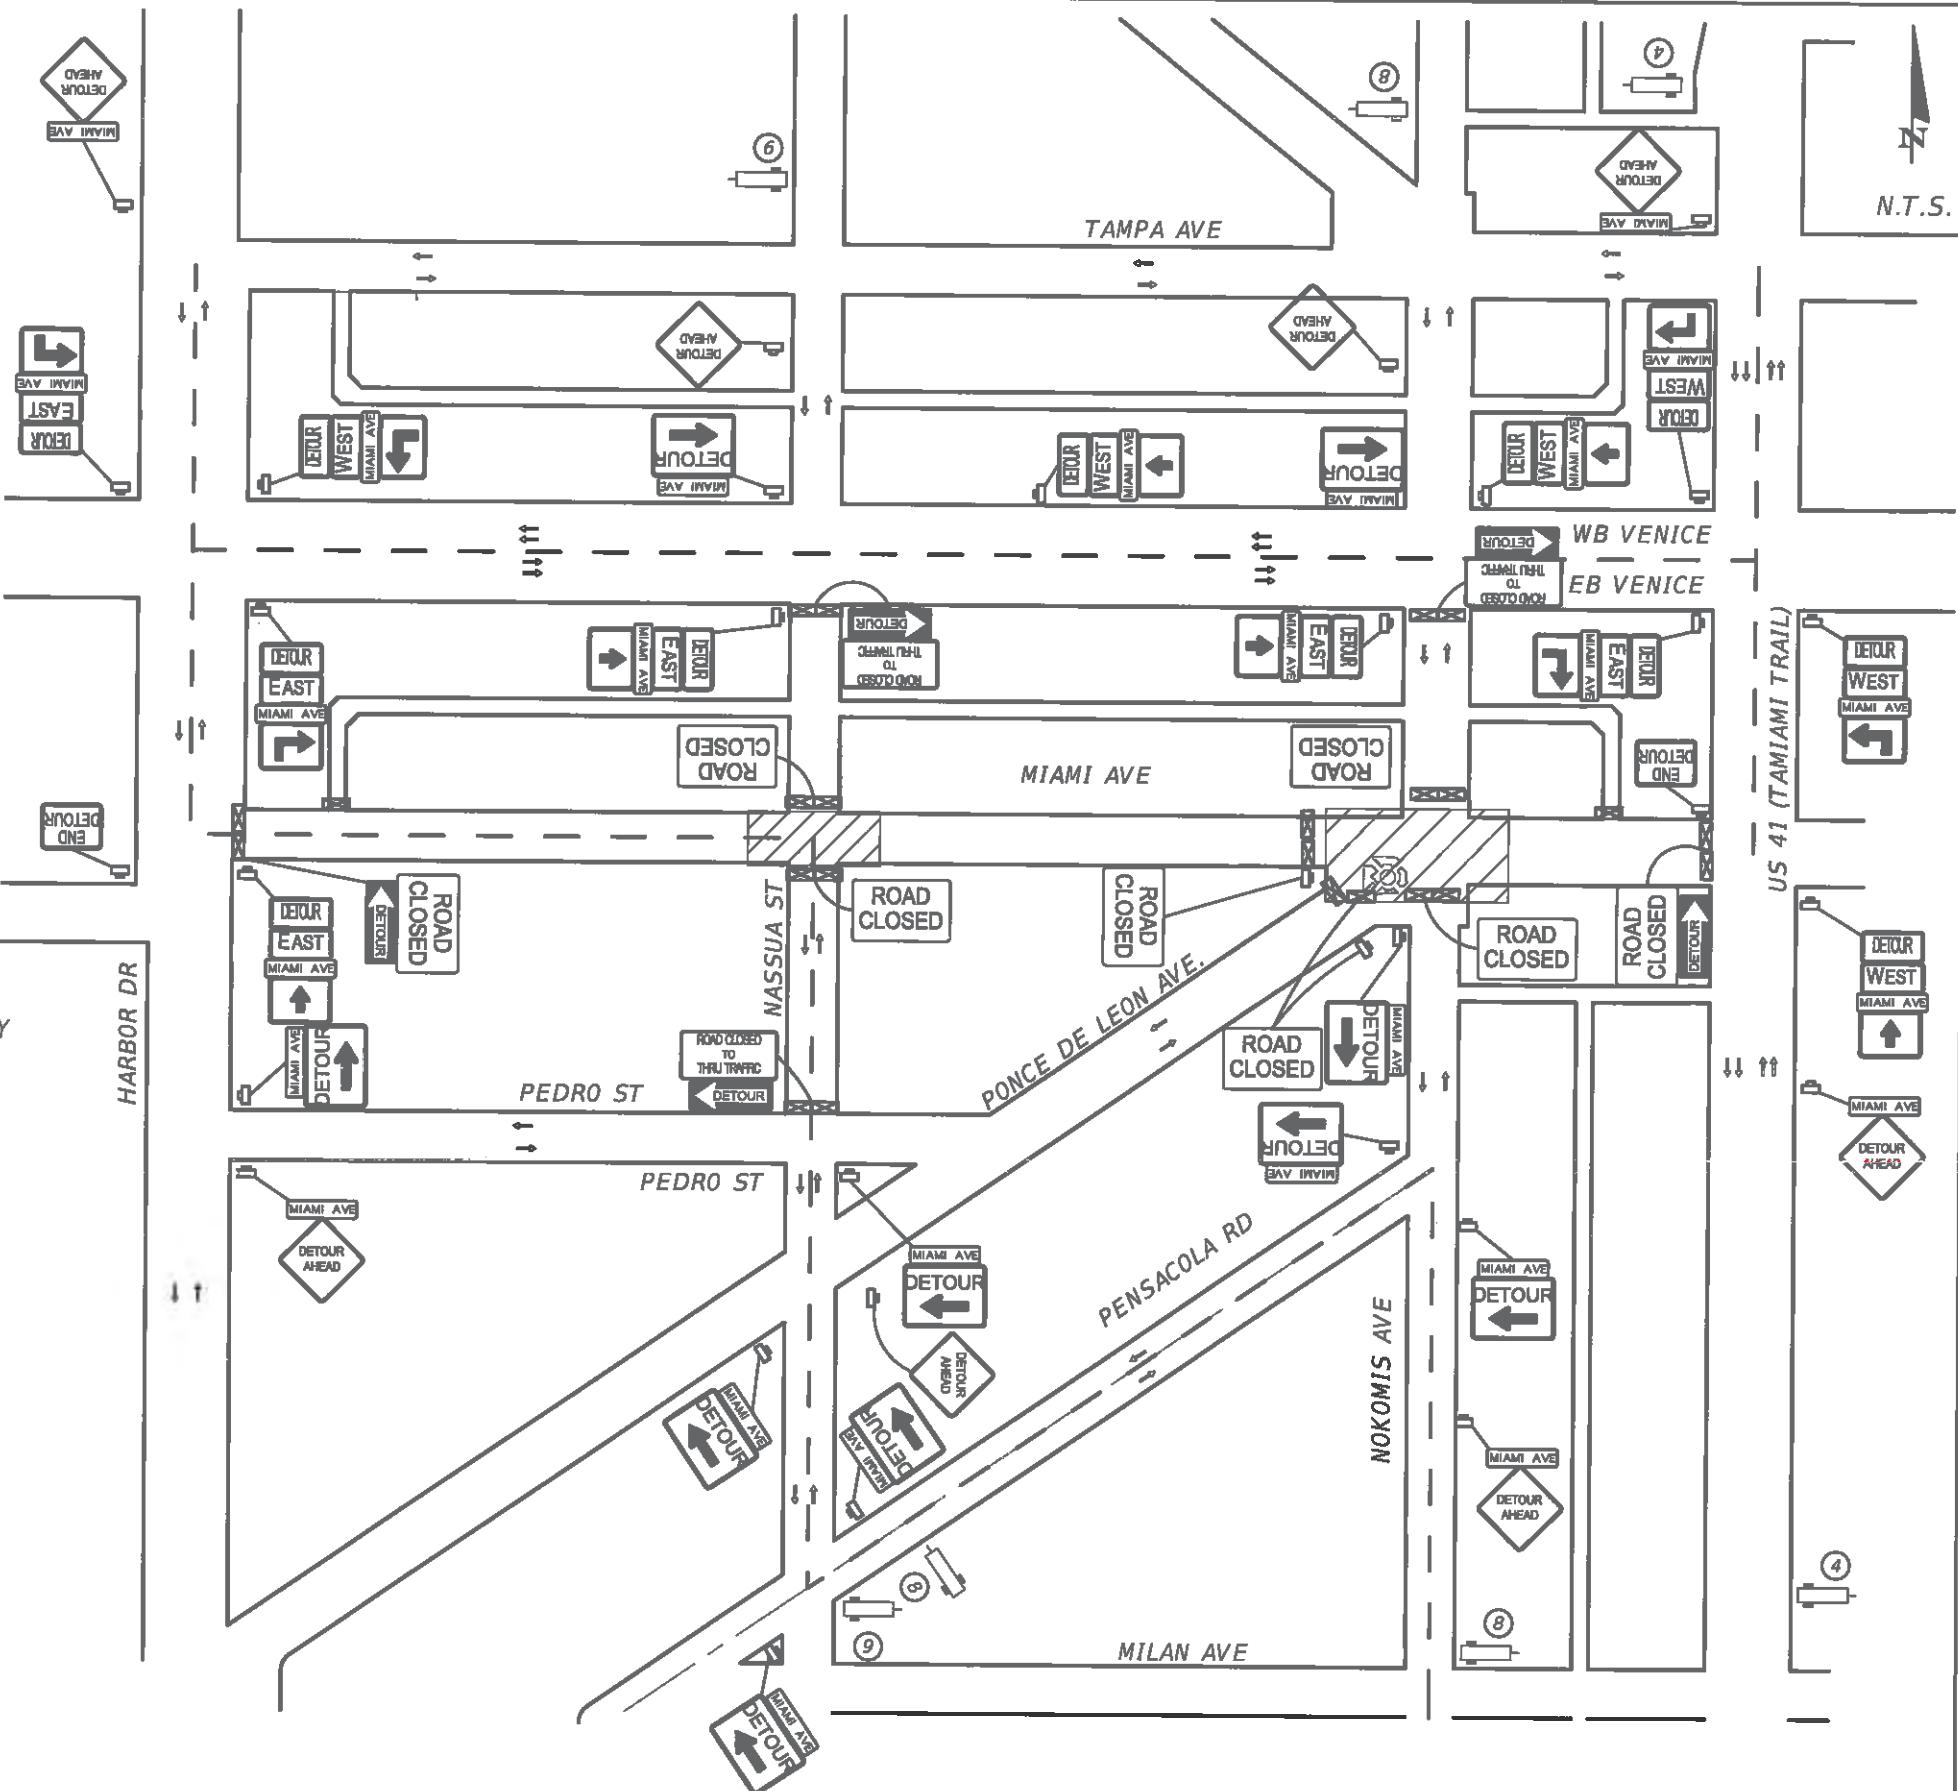

PREPARED FOR:	PREPARED BY:	PROJECT:	DESCRIPTION:	APPROVED BY:	DATE:
DESIGNED MLM		ATKINS	CITY OF VENICE DOWNTOWN ROADWAY CORRIDOR IMPROVEMENTS	TTCP MIAMI AVE Detour Routes	3/15/2018
DRAWN MA				JOHN SALATINO, P.E. P.E. LICENSE NUMBER 60921 ATKINS NORTH AMERICA (CERT. OF AUTH. NO. 24) 4030 WEST BOY SCOUT BOULEVARD, SUITE 700 TAMPA, FL 33607-1712	DATE PROJECT NO.: SHEET:
CHECKED MLM					100054389 73

LEGEND

- Work Zone Sign
- Type III Barricade
- Existing Lane Identification and Direction of Traffic
- Shifted Lane Identification and Direction of Traffic
- Active Work Zone
- Detour Route
- Portable Changeable Messaging Sign

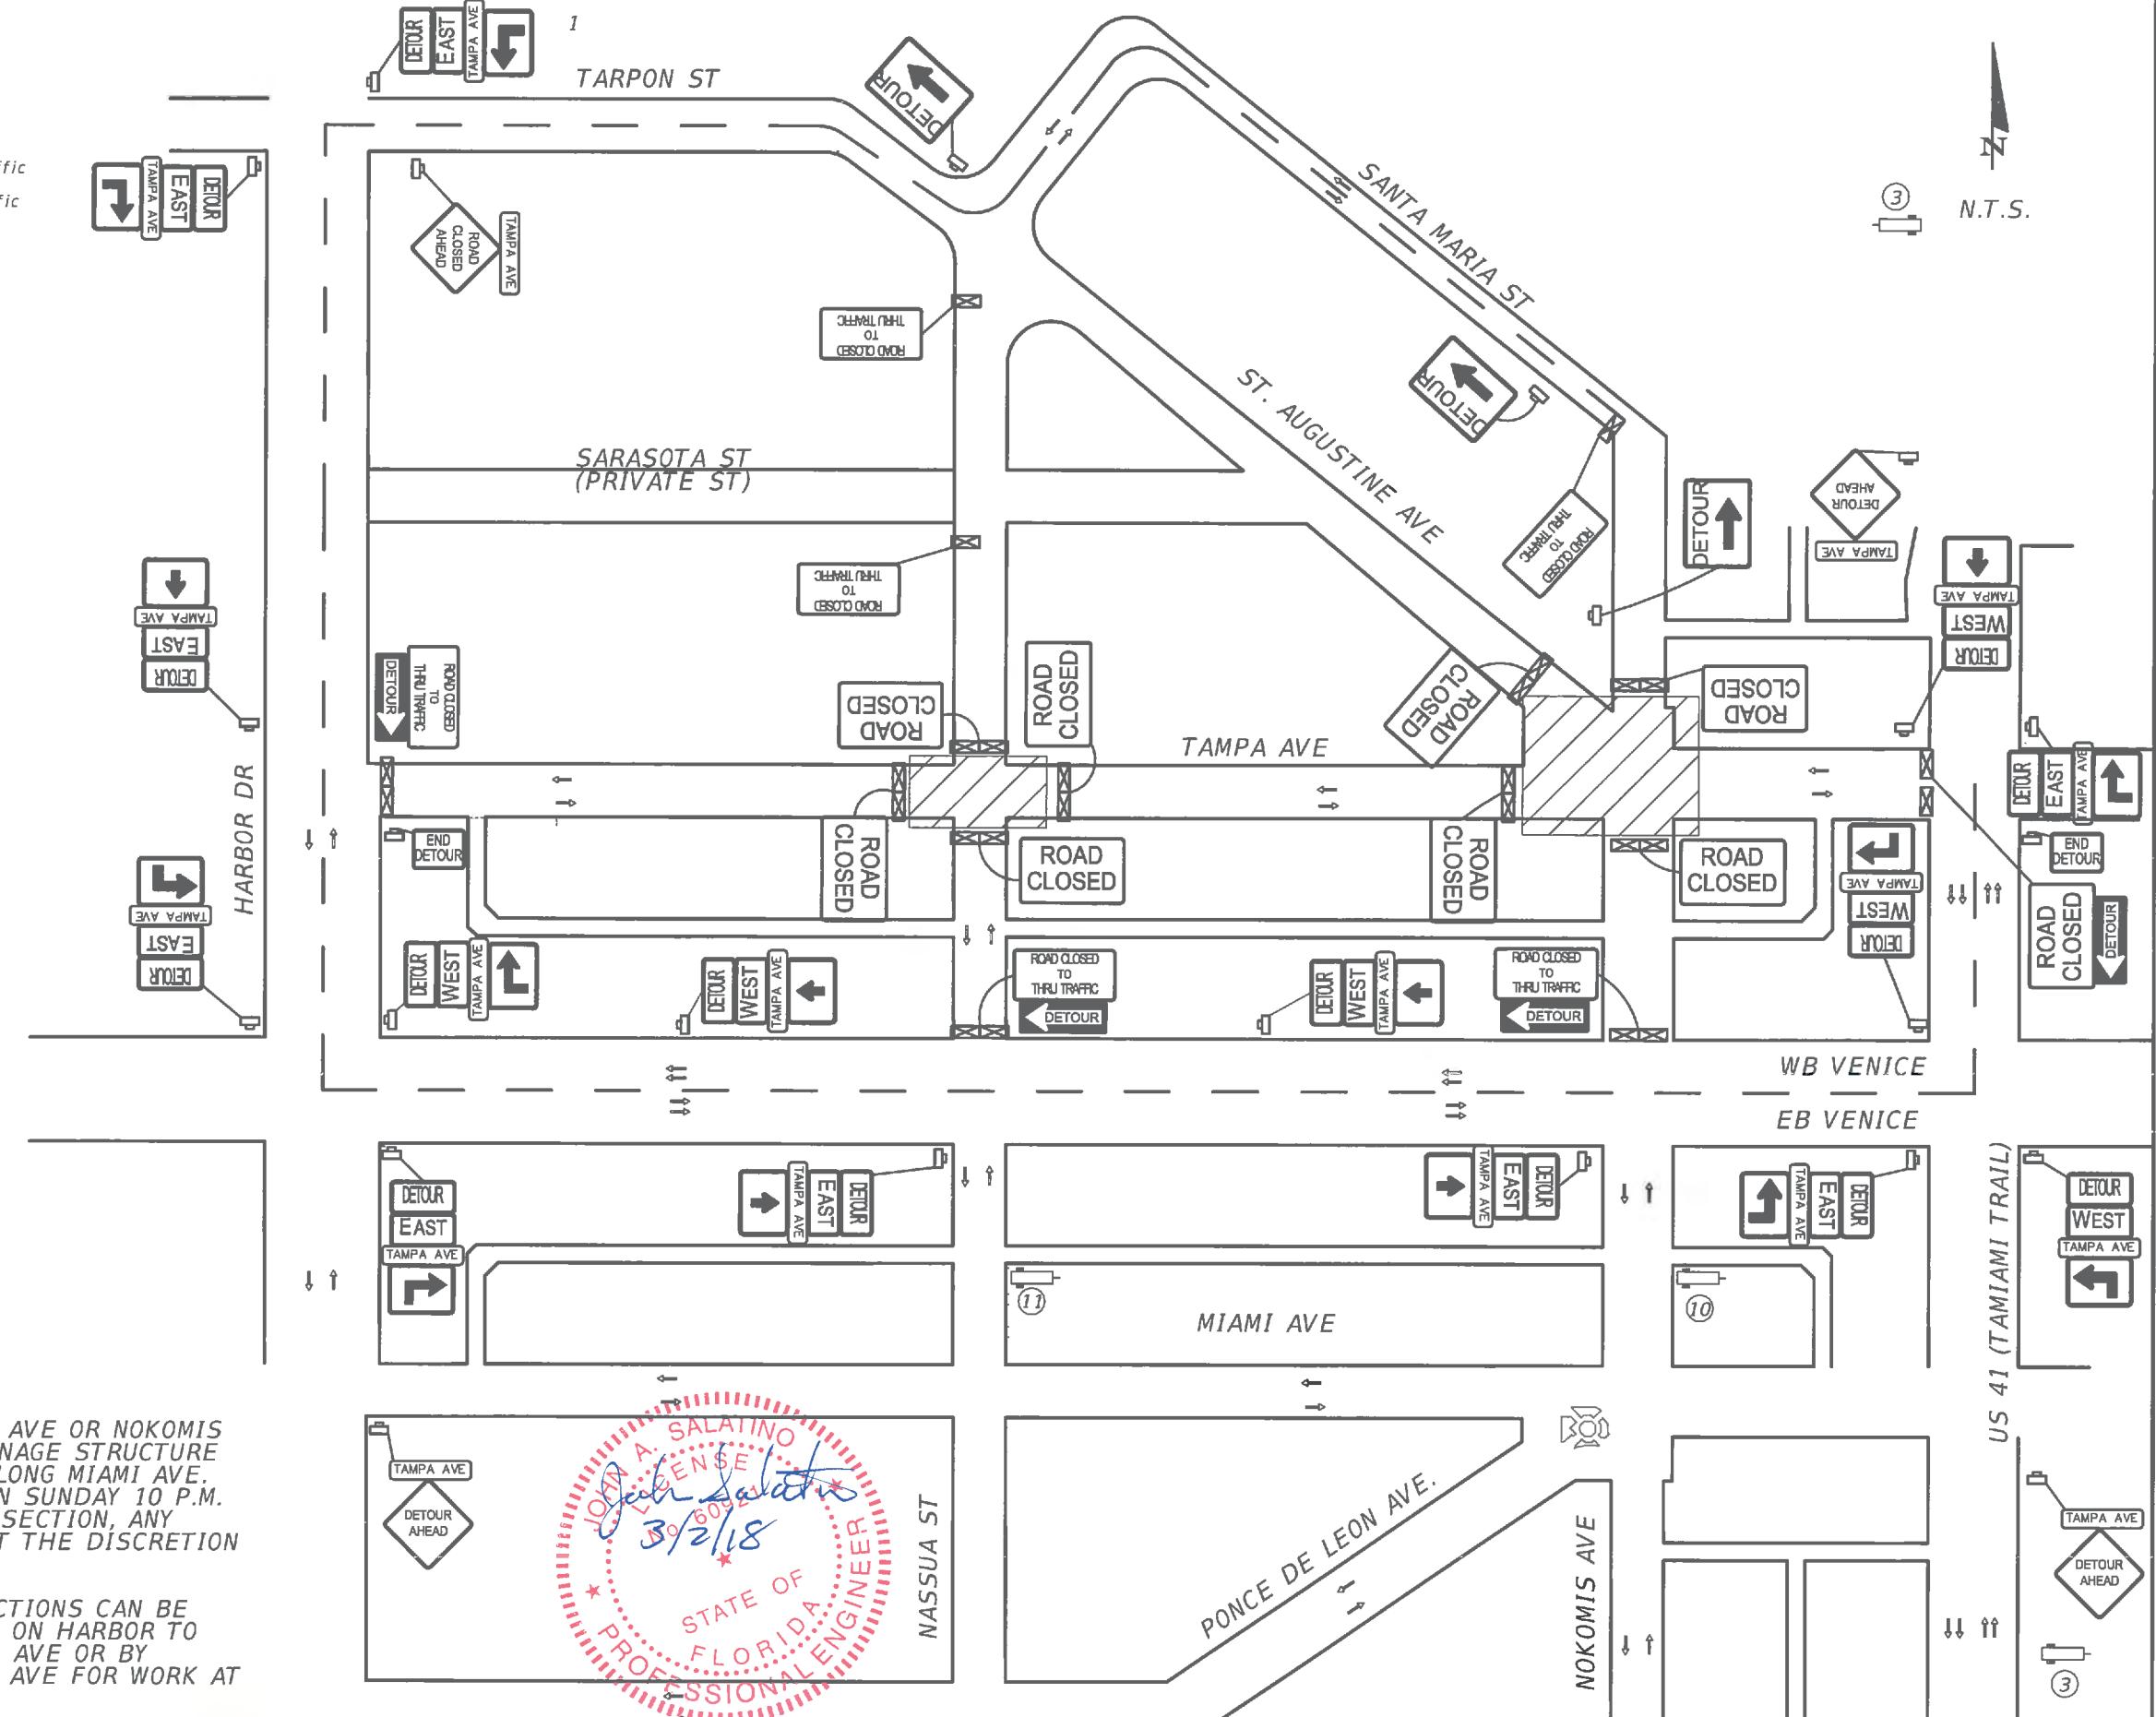**NOTES:**

1. DETOUR FOR NASSAU ST AND MIAMI AVE OR NOKOMIS AVE AND MIAMI AVE INTERSECTION DRAINAGE STRUCTURE INSTALLATION OR ANY OTHER ACTIVITY ALONG MIAMI AVE. DETOURS SHALL BE LIMITED TO BETWEEN SUNDAY 10 P.M. THROUGH WEDNESDAY 6 A.M. PER INTERSECTION, ANY OTHER USE OF THE DETOUR SHALL BE AT THE DISCRETION OF THE ENGINEER.

2. DETOURS FOR INDIVIDUAL INTERSECTIONS CAN BE ACCOMPLISHED BY MOVING SIGNS SHOWN ON HARBOR TO NASSAU ST FOR NOKOMIS AVE AND MIAMI AVE OR BY MOVING THE SIGNS ON US41 TO NOKOMIS AVE FOR WORK AT NASSAU ST AND MIAMI AVE.

PREPARED FOR:	PREPARED BY:	PROJECT:	DESCRIPTION:	APPROVED BY:	DATE:
DESIGNED MLM DRAWN MA CHECKED MLM	Venice, FL City on the Gulf	ATKINS	CITY OF VENICE DOWNTOWN ROADWAY CORRIDOR IMPROVEMENTS	TTCP Tampa Ave Detour Routes	JOHN SALATINO, P.E. P.E. LICENSE NUMBER 60921 ATKINS NORTH AMERICA (CERT. OF AUTH. NO. 24) 4030 WEST BOY SCOUT BOULEVARD, SUITE 700 TAMPA, FL 33607-1712
Page 963 of 1140 REV. NO. DATE DESCRIPTION					2/28/2018 PROJECT NO.: 10054389 SHEET: 74

LEGEND


- Work Zone Sign
- Type III Barricade
- Existing Lane Identification and Direction of Traffic
- Shifted Lane Identification and Direction of Traffic
- Active Work Zone
- Detour Route
- Portable Changeable Messaging Sign



N.T.S.

## NOTES:

1. ONLY ONE ROAD MAY BE DETOURED AT A TIME TO PREVENT CONFLICTING SIGNAGE UNLESS APPROVED BY THE ENGINEER
2. CONSTRUCT TIES INTO EXISTING DRAINAGE ON NOKOMIS USING THESE DETOURS.

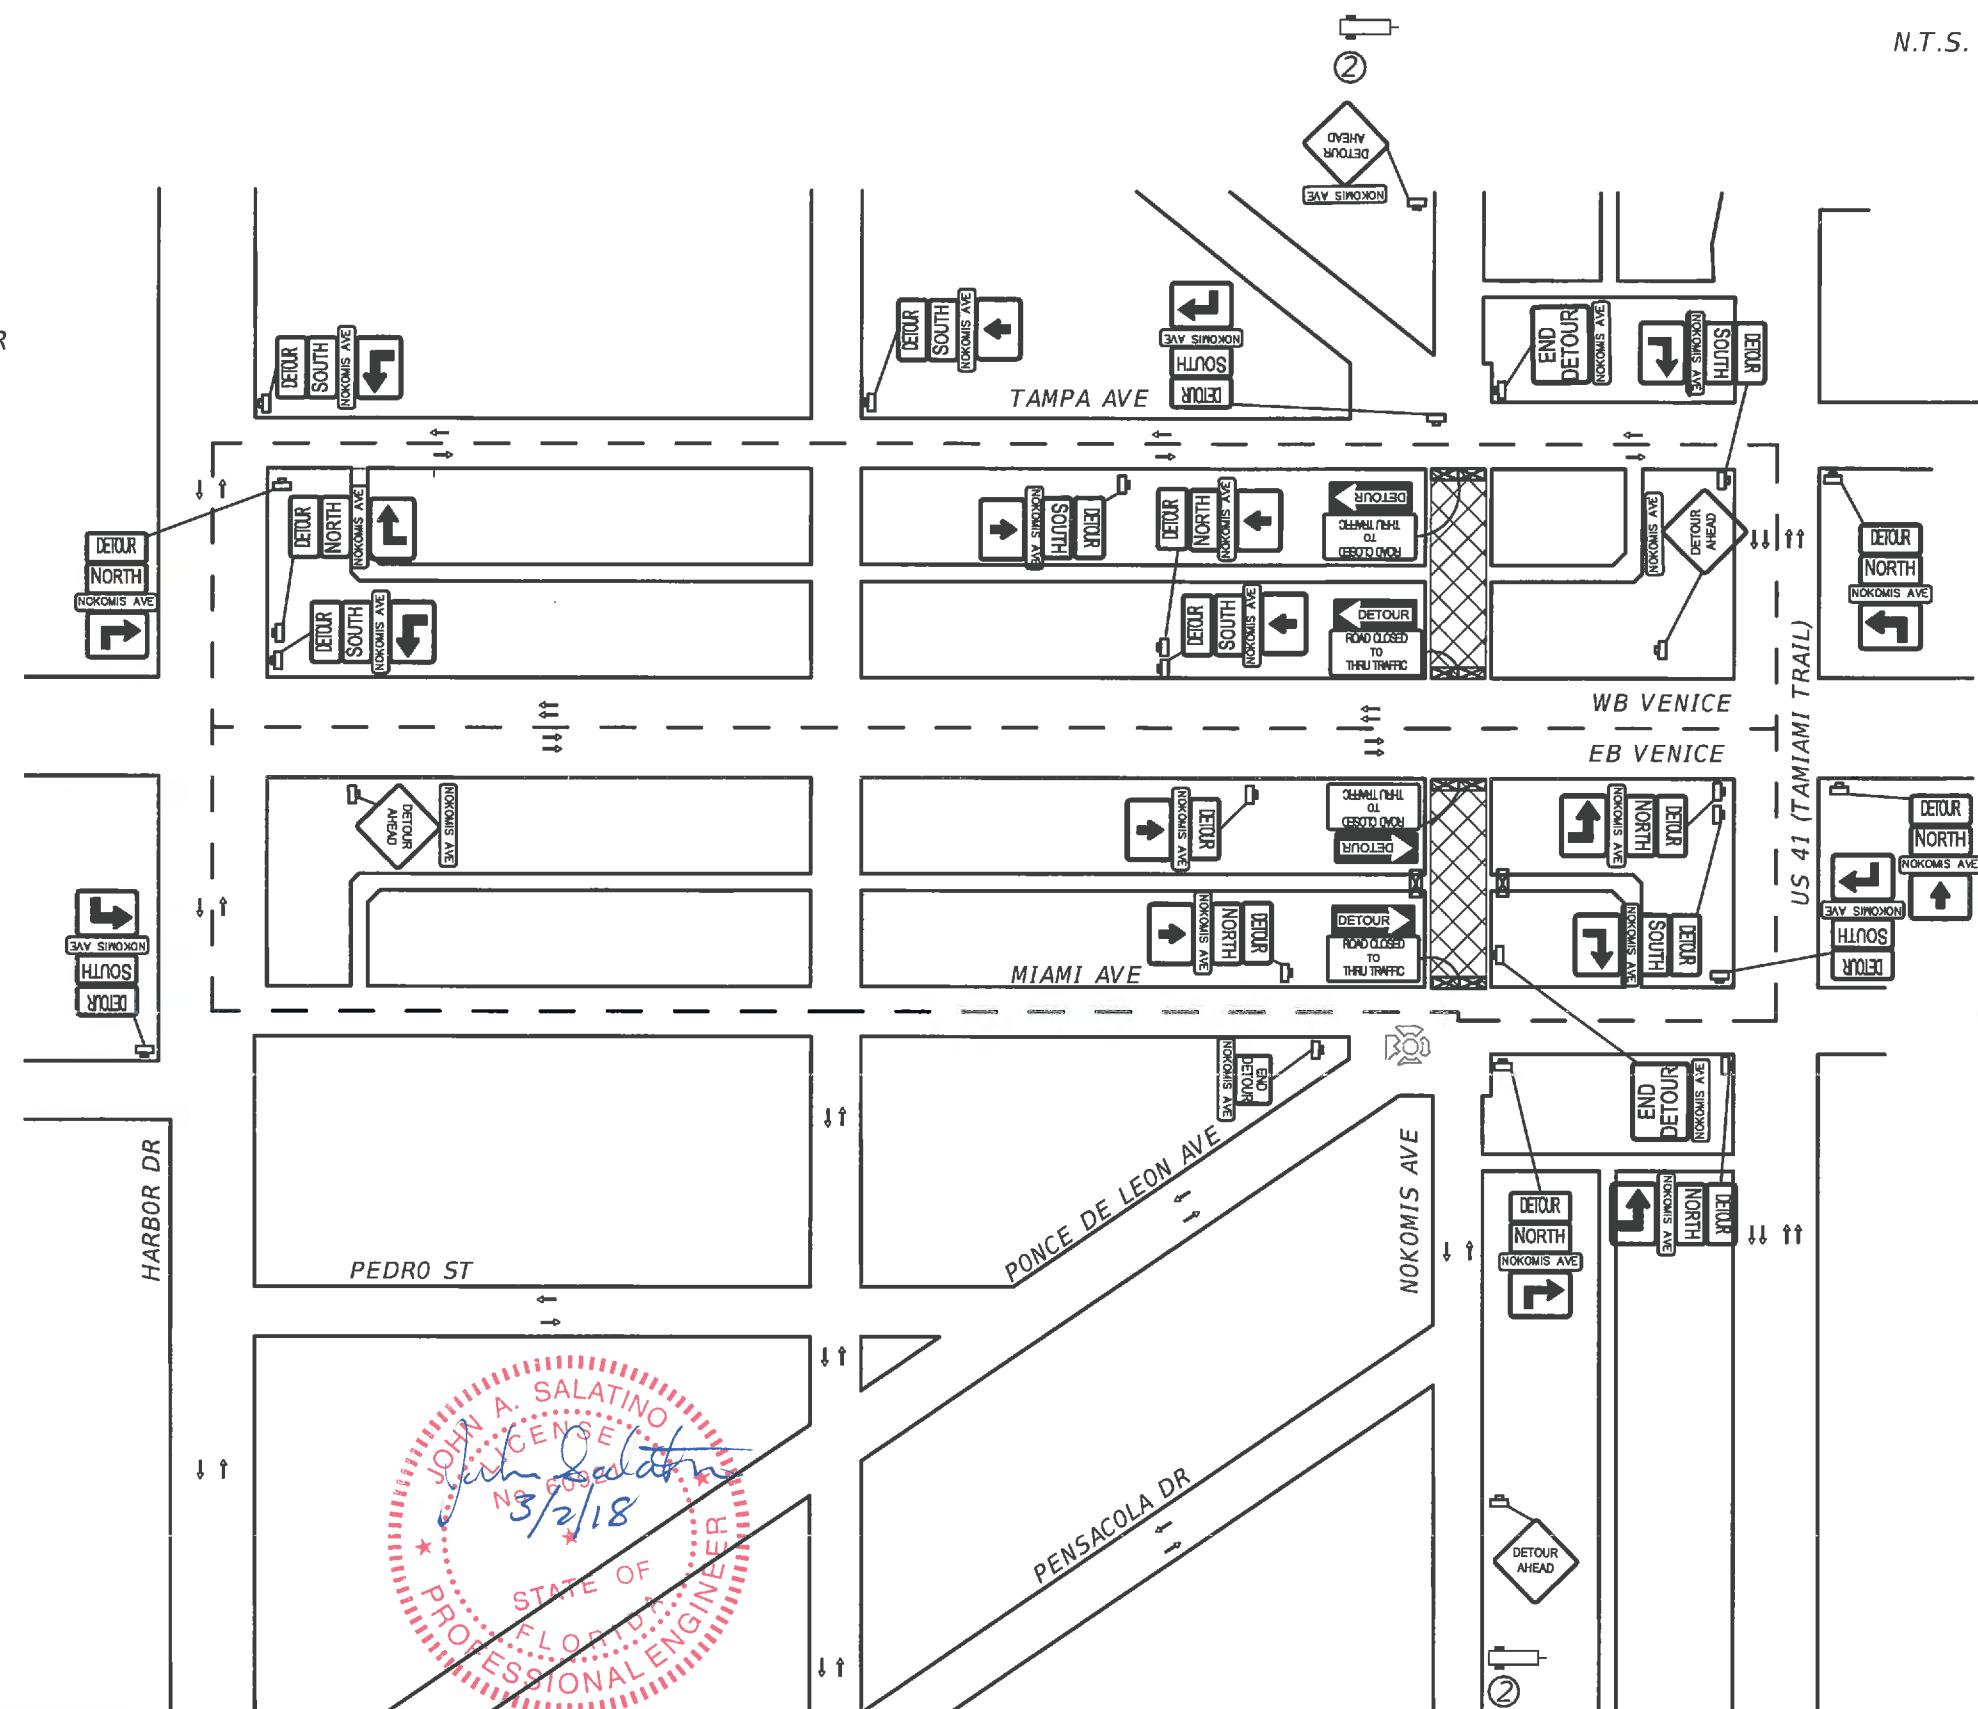

DESIGNED	PREPARED FOR:	PREPARED BY:	PROJECT:	DESCRIPTION:	APPROVED BY:	DATE:
MLM	Venice, FL City on the Gulf	ATKINS	CITY OF VENICE DOWNTOWN ROADWAY CORRIDOR IMPROVEMENTS	TTCP Nokomis Ave Detour Routes	JOHN SALATINO, P.E. P.E. LICENSE NUMBER 60921 ATKINS NORTH AMERICA (CERT. OF AUTH. No. 24) 4030 WEST BOY SCOUT BOULEVARD, SUITE 700 TAMPA, FL 33607-1712	2/28/2018
DRAWN	MA	MA				PROJECT NO.: 100054389
CHECKED	MLM					SHEET: 75

## LEGEND


- Work Zone Sign
- Type III Barricade
- Existing Lane Identification and Direction of Traffic
- Shifted Lane Identification and Direction of Traffic
- Active Work Zone
- Detour Route
- Portable Changeable Messaging Sign



N.T.S.

### NOTES:

1. ONLY ONE ROAD MAY BE DETOURED AT A TIME TO PREVENT CONFLICTING SIGNAGE UNLESS APPROVED BY THE ENGINEER
2. CONSTRUCT TIES INTO EXISTING DRAINAGE ON NASSAU USING THESE DETOURS

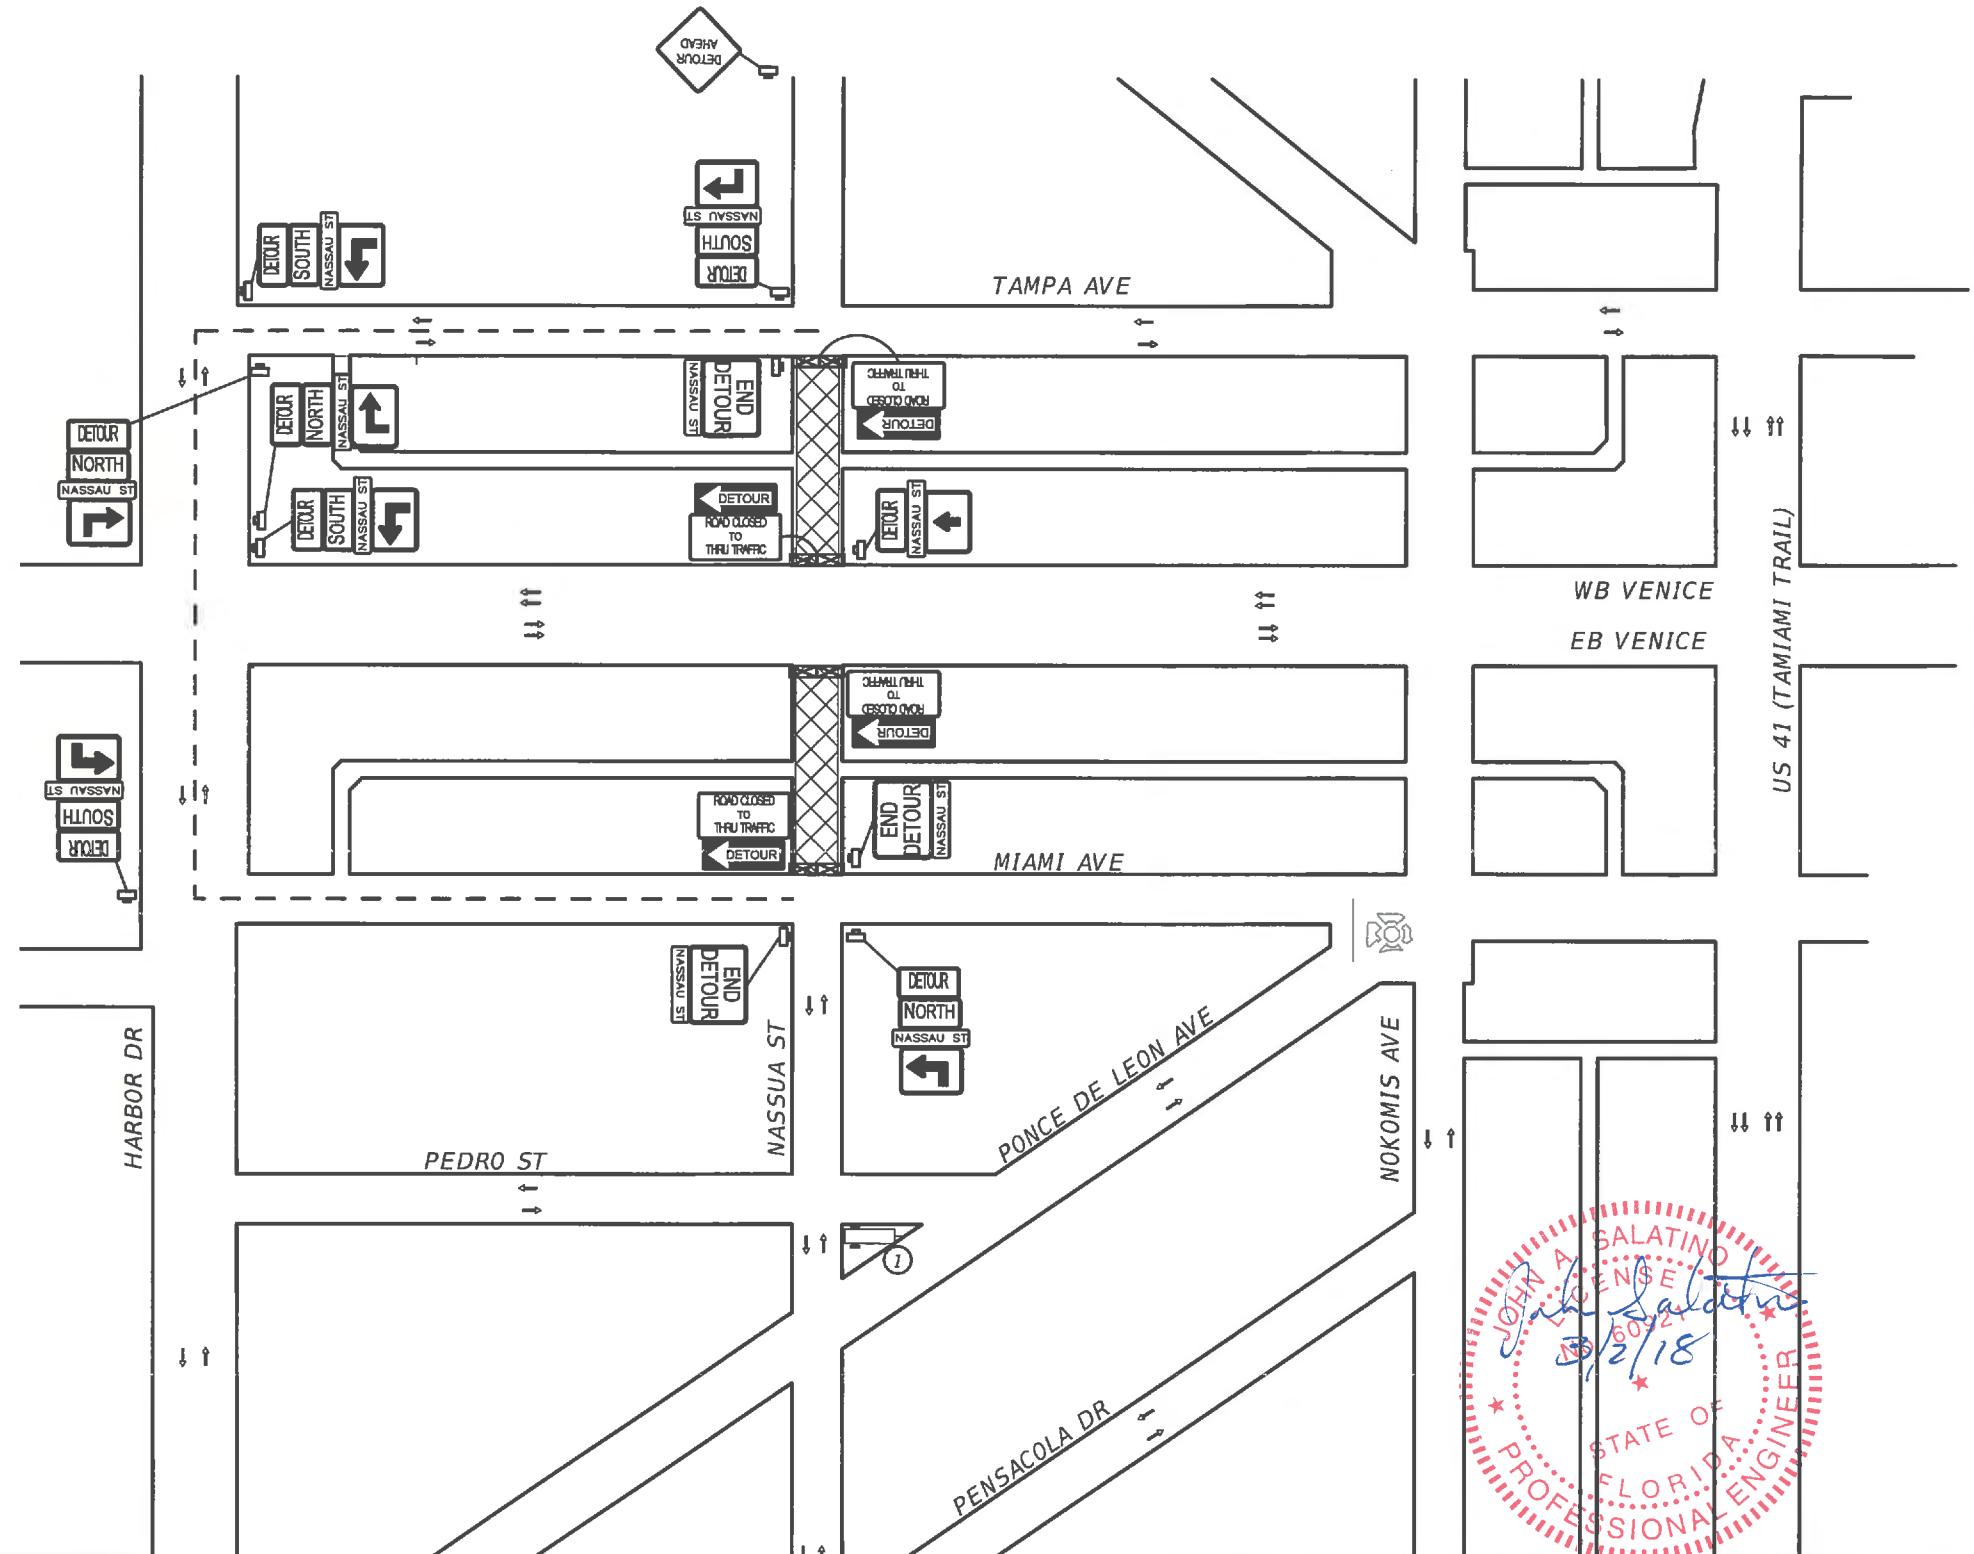

DESIGNED	PREPARED FOR:	PREPARED BY:	PROJECT:	DESCRIPTION:	APPROVED BY:	DATE:
MLM	Venice, FL City on the Gulf	ATKINS	CITY OF VENICE DOWNTOWN ROADWAY CORRIDOR IMPROVEMENTS	TTCP Nassau St Detour Routes	JOHN SALATINO, P.E. P.E. LICENSE NUMBER 60921 ATKINS NORTH AMERICA (CERT. OF AUTH. NO. 24) 4030 WEST BOY SCOUT BOULEVARD, SUITE 700 TAMPA, FL 33607-1712	2/28/2018
DRAWN	MA					PROJECT NO.: 100054389
CHECKED	MLM					SHEET: 76

## LEGEND

-  Active Work Zone
-  Active Work Zone (Night Time Sidewalk Construction)
-  Pedestrian Longitudinal channelizing device (LCD)
-  Pedestrian Path
-  Shift Lane Identification and Direction of Traffic




N.T.S.


## NIGHT TIME SIDEWALK CONSTRUCTION AND SIDEWALK DETOUR DETAIL

### NOTES:

1. CLOSE NO MORE SIDEWALK, ADJACENT TO BUSINESS ENTRANCES, THAN CAN BE RECONSTRUCTED IN A ONE NIGHT CLOSURE, 8:30 PM TO 6:00 AM.
2. SETUP PEDESTRIAN DETOUR SIGNS USING FDOT STANDARD INDEX 660 PRIOR TO SIDEWALK CLOSURE.
3. MINIMIZE DETOURS LENGTH BY UTILIZING MIDBLOCK CROSSWALKS.
4. APPLY DETOUR BELOW TO EACH QUADRANT OF THE INTERSECTION TO CONSTRUCT BULBOUTS.
5. ALL CROSSWALKS, CURB RAMPS, AND SIDEWALKS (TEMPORARY AND/OR PERMANENT) SHALL BE ADA ACCESSIBLE AND SHALL MEET THE REQUIREMENTS OF FDOT STANDARD INDEXES 304, 600, AND 660.

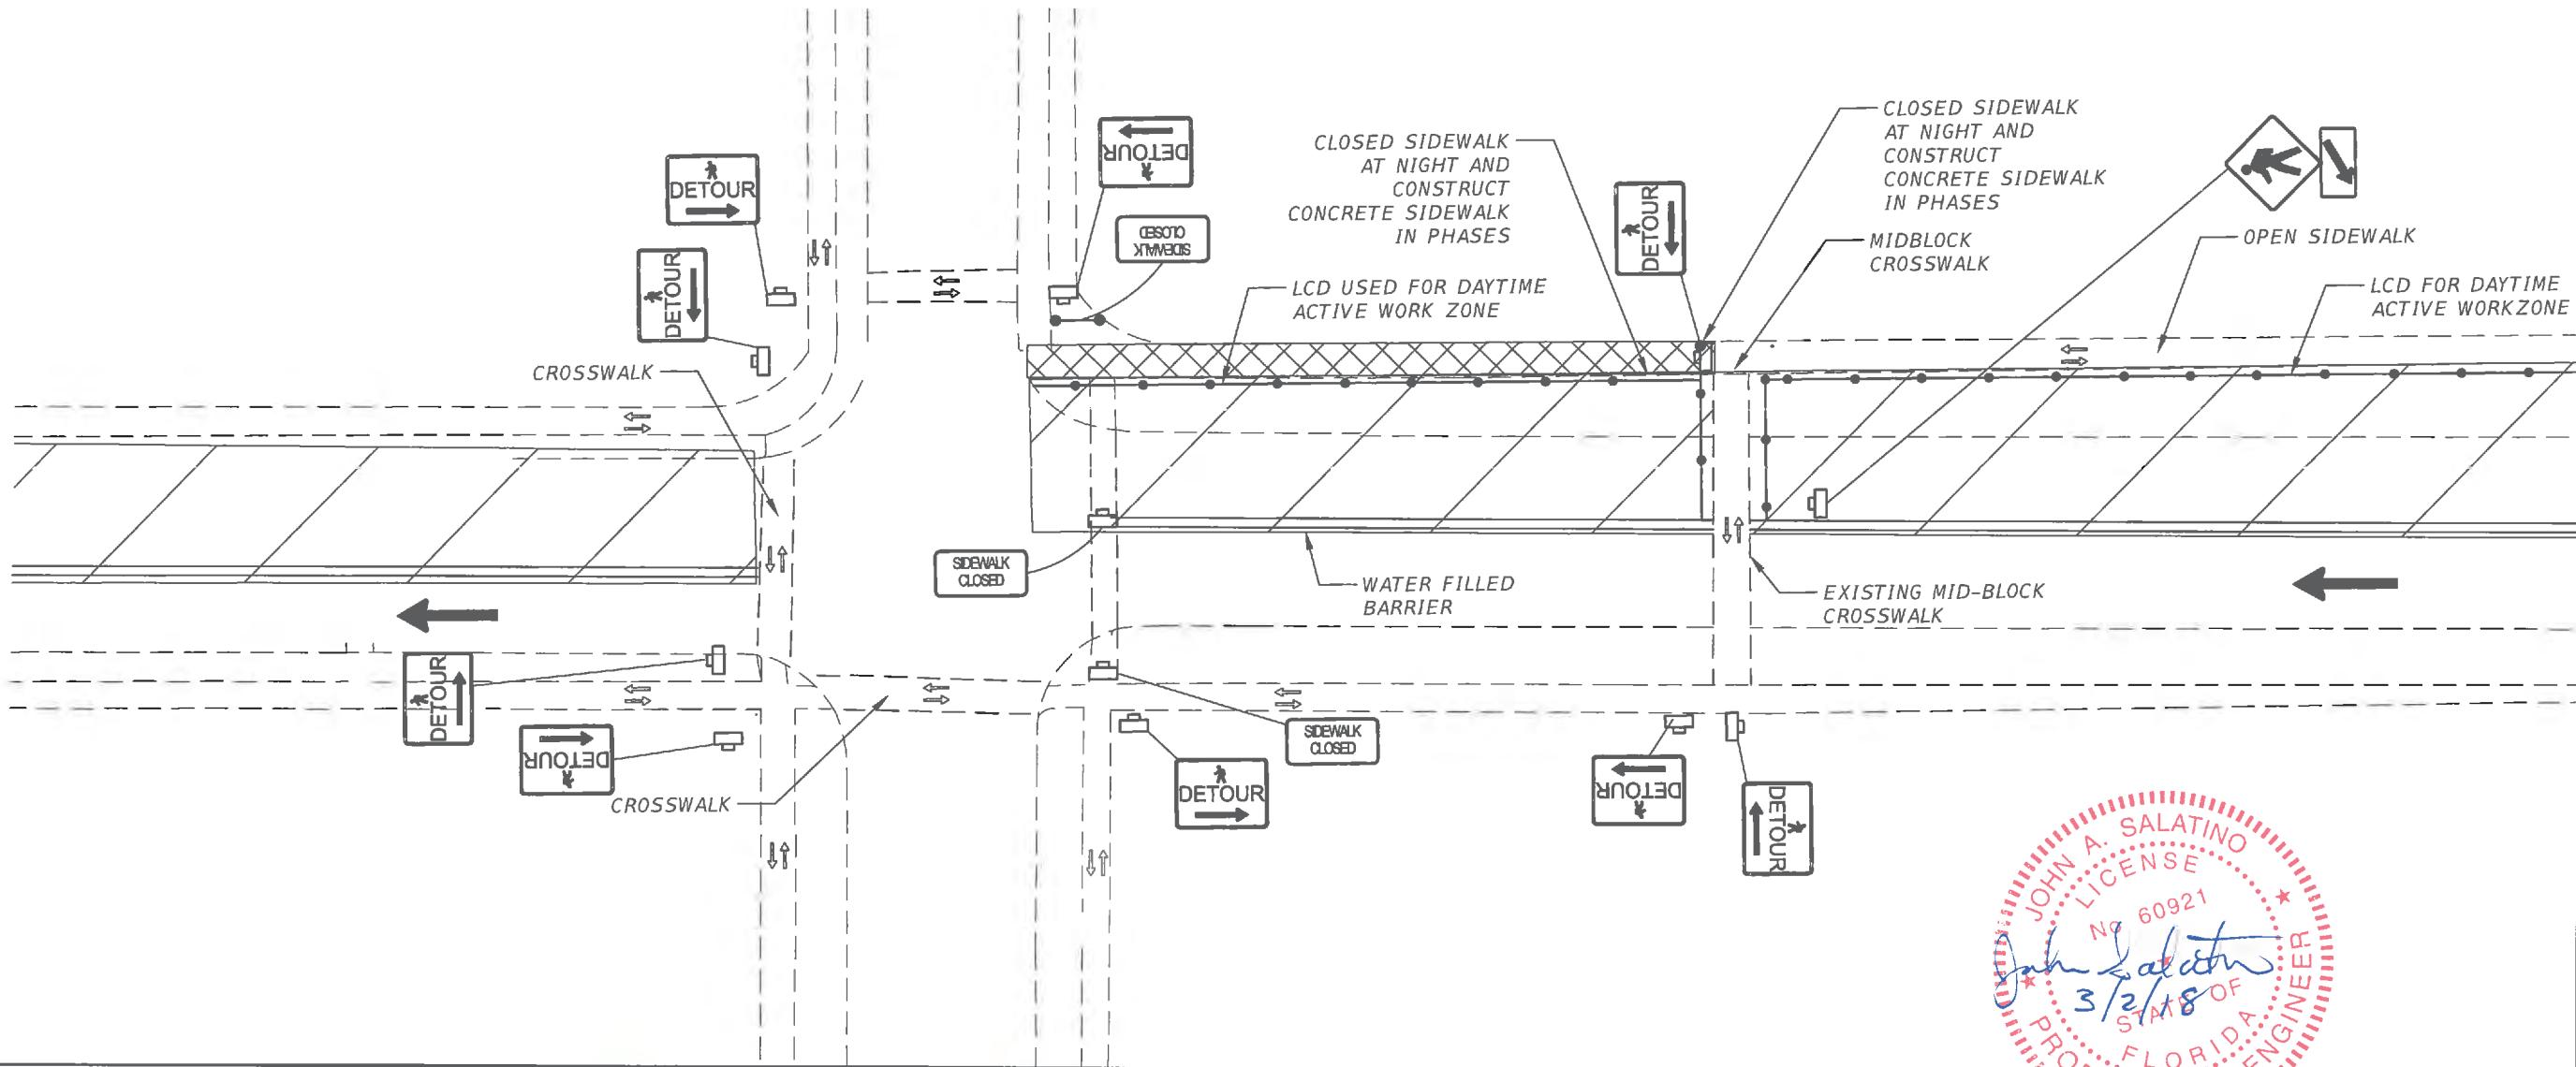

			PREPARED FOR:	PREPARED BY:	PROJECT:	DESCRIPTION:	APPROVED BY:	DATE:
			DESIGNED MLM DRAWN MA CHECKED MLM	Venice, FL City on the Gulf	ATKINS	CITY OF VENICE DOWNTOWN ROADWAY CORRIDOR IMPROVEMENTS	TTCP Pedestrian Sidewalk Detour Route	JOHN SALATINO, P.E. P.E. LICENSE NUMBER 60921 ATKINS NORTH AMERICA (CERT. OF AUTH. NO. 24) 4030 WEST BOY SCOUT BOULEVARD, SUITE 700 TAMPA, FL 33607-1712
Page 966 of 1140	REV. NO.	DATE	DESCRIPTION					2/28/2018 PROJECT NO.: 100054389 SHEET: 77

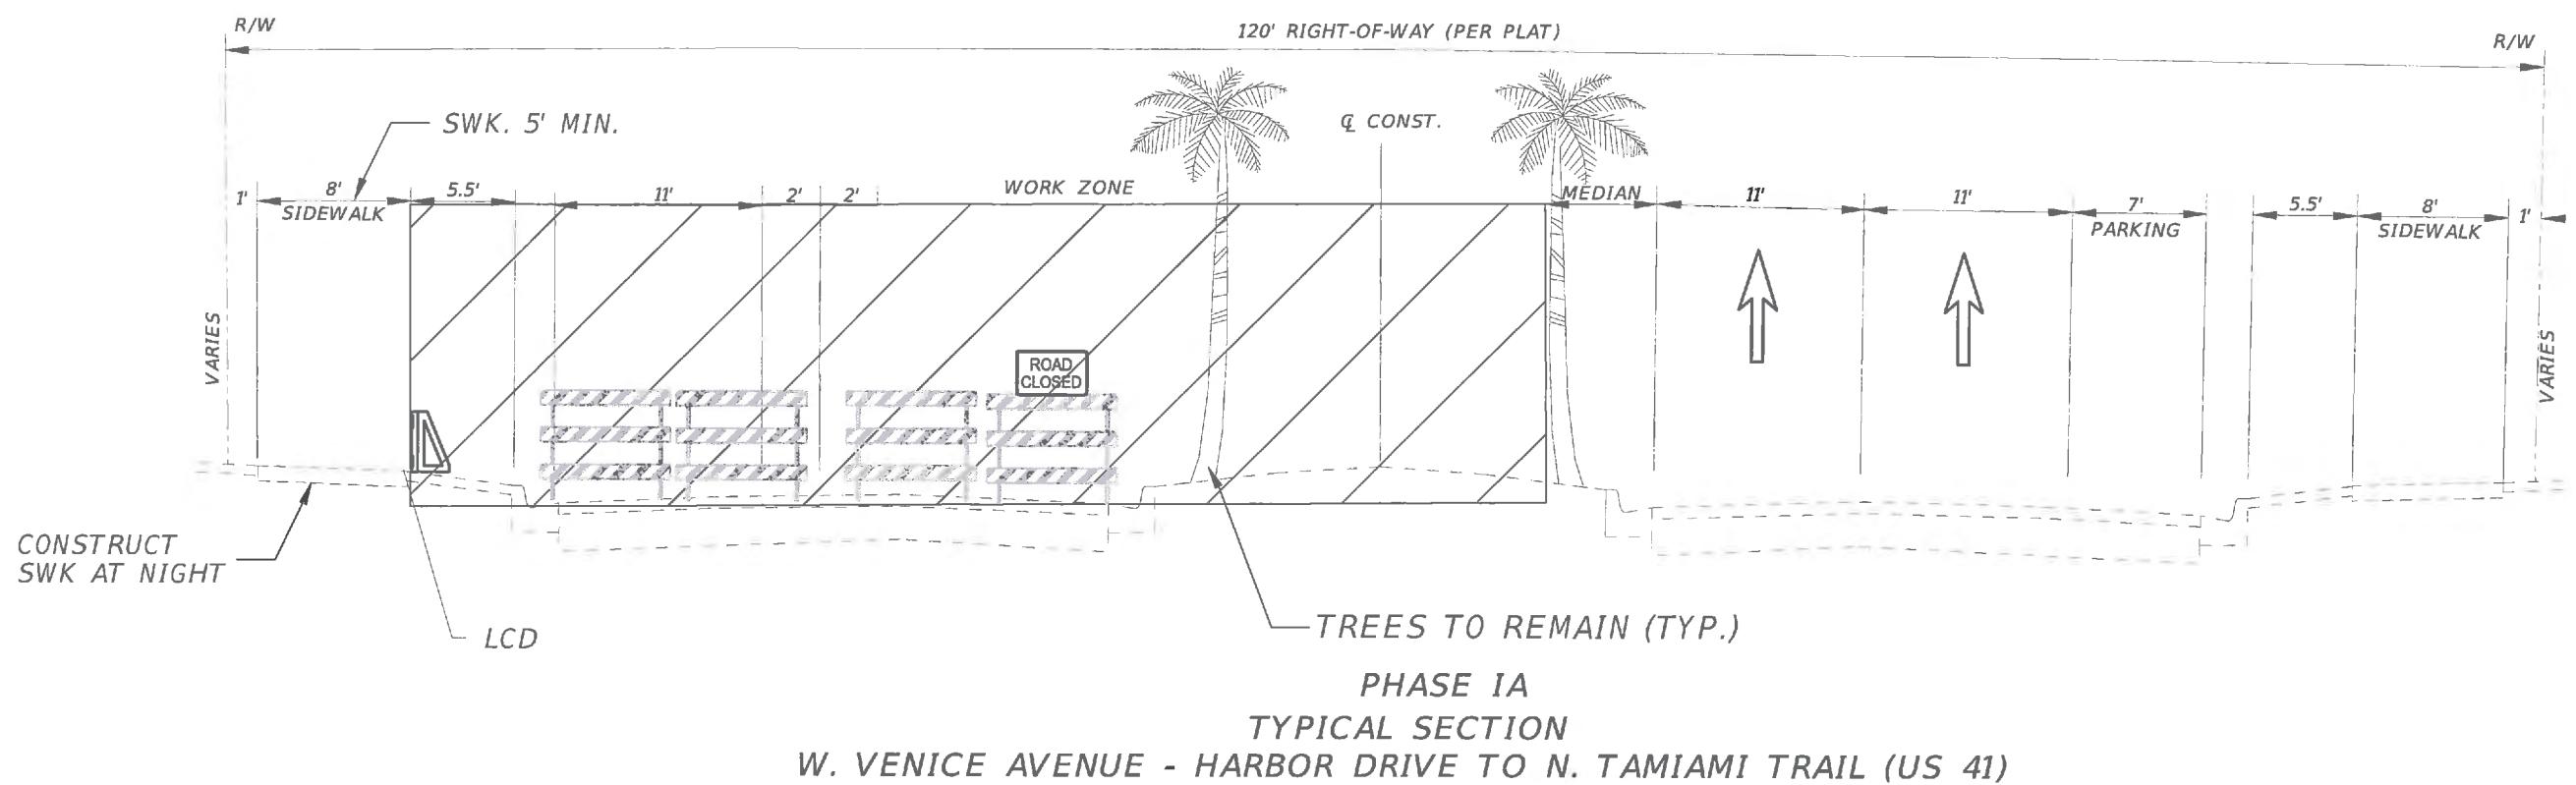

PHASE NOTES:

PHASE IA


- CLOSE WB LANES USING FDOT DESIGN STANDARDS INDEX 600 AND THE TRAFFIC CONTROL PLANS. CONSTRUCT THE WB LANES AND LEFT SIDE OF MEDIAN, INCLUDING STORM DRAIN MAINLINE.
- MAINTAIN PEDESTRIAN TRAFFIC USING FDOT DESIGN STANDARDS INDEX 660. TOTAL SIDEWALK CLOSURES ADJACENT TO BUSINESS ENTRANCES WILL BE ALLOWED FROM 8:30 PM TO 6:00 AM AT THE DISCRETION OF THE ENGINEER

LEGEND

- EXISTING LANE IDENTIFICATION AND DIRECTION OF TRAFFIC
- SHIFTED LANE IDENTIFICATION AND DIRECTION OF TRAFFIC
- ACTIVE WORK ZONE



			DESIGNED MLM	DRAWN MA	PREPARED FOR: 	PREPARED BY: 	PROJECT: CITY OF VENICE DOWNTOWN ROADWAY CORRIDOR IMPROVEMENTS	DESCRIPTION: TTCP Typical Sections	APPROVED BY: JOHN SALATINO, P.E. P.E. LICENSE NUMBER 60921 ATKINS NORTH AMERICA (CERT. OF AUTH. NO. 24) 4030 WEST BOY SCOUT BOULEVARD, SUITE 700 TAMPA, FL 33607-1712	DATE: 2/28/2018	
Page 967	of 1140		REV. NO.	DATE	DESCRIPTION					PROJECT NO.: 100054389	

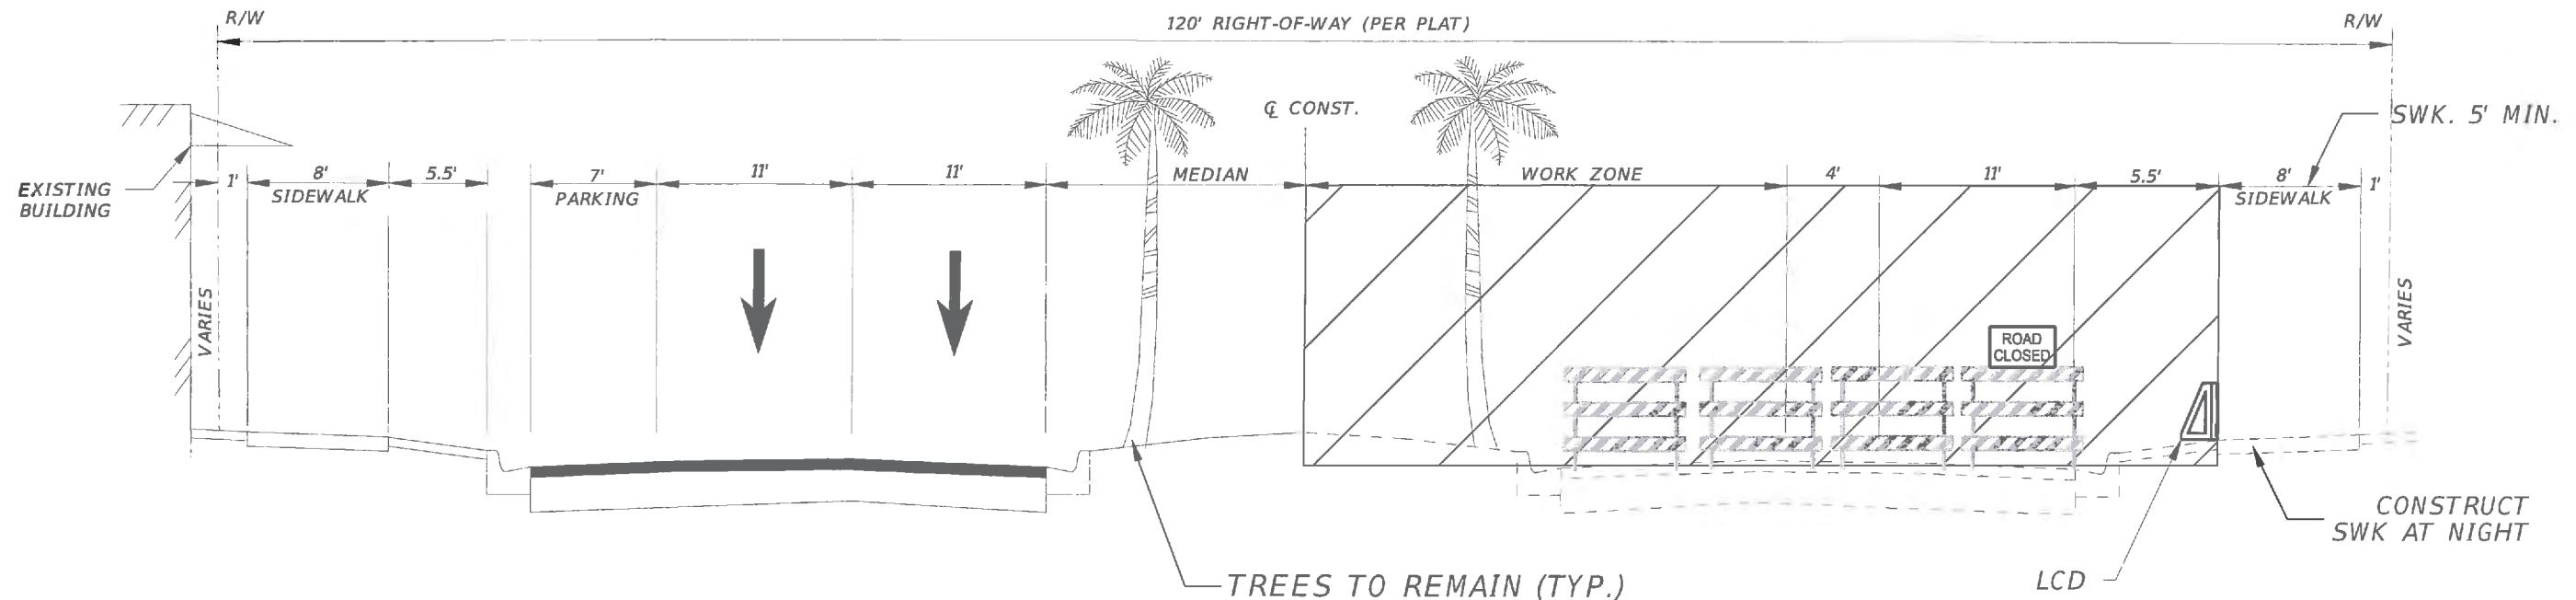

**PHASE IB  
TYPICAL SECTION  
W. VENICE AVENUE - HARBOR DRIVE TO N. TAMiami TRAIL (US 41)**

PHASE NOTES:

PHASE IB

1. CLOSE EB LANES USING FDOT DESIGN STANDARDS INDEX 600. CONSTRUCT INSIDE EB LANES, CURB AND GUTTER AND DRAINAGE.
2. MAINTAIN SIDEWALK USING FDOT DESIGN STANDARDS INDEX 660. TOTAL SIDEWALK CLOSURES ADJACENT TO BUSINESS ENTRANCES WILL BE ALLOWED FROM 8:30 PM TO 6:00 AM AT THE DISCRETION OF THE ENGINEER


LEGEND

→ EXISTING LANE IDENTIFICATION AND DIRECTION OF TRAFFIC

→ SHIFTED LANE IDENTIFICATION AND DIRECTION OF TRAFFIC



				DESIGNED MLM	DRAWN MA	CHECKED MLM	PREPARED FOR: 	PREPARED BY: <b>ATKINS</b>	PROJECT: CITY OF VENICE DOWNTOWN ROADWAY CORRIDOR IMPROVEMENTS	DESCRIPTION: TTCP Typical Sections	APPROVED BY: JOHN SALATINO, P.E. P.E. LICENSE NUMBER 60921 ATKINS NORTH AMERICA (CERT. OF AUTH. NO. 24) 4030 WEST BOY SCOUT BOULEVARD, SUITE 700 TAMPA, FL 33607-1712	DATE: 2/28/2018
Page 968 of 1140	REV. NO.	DATE	DESCRIPTION									PROJECT NO.: 100054389 SHEET: 79

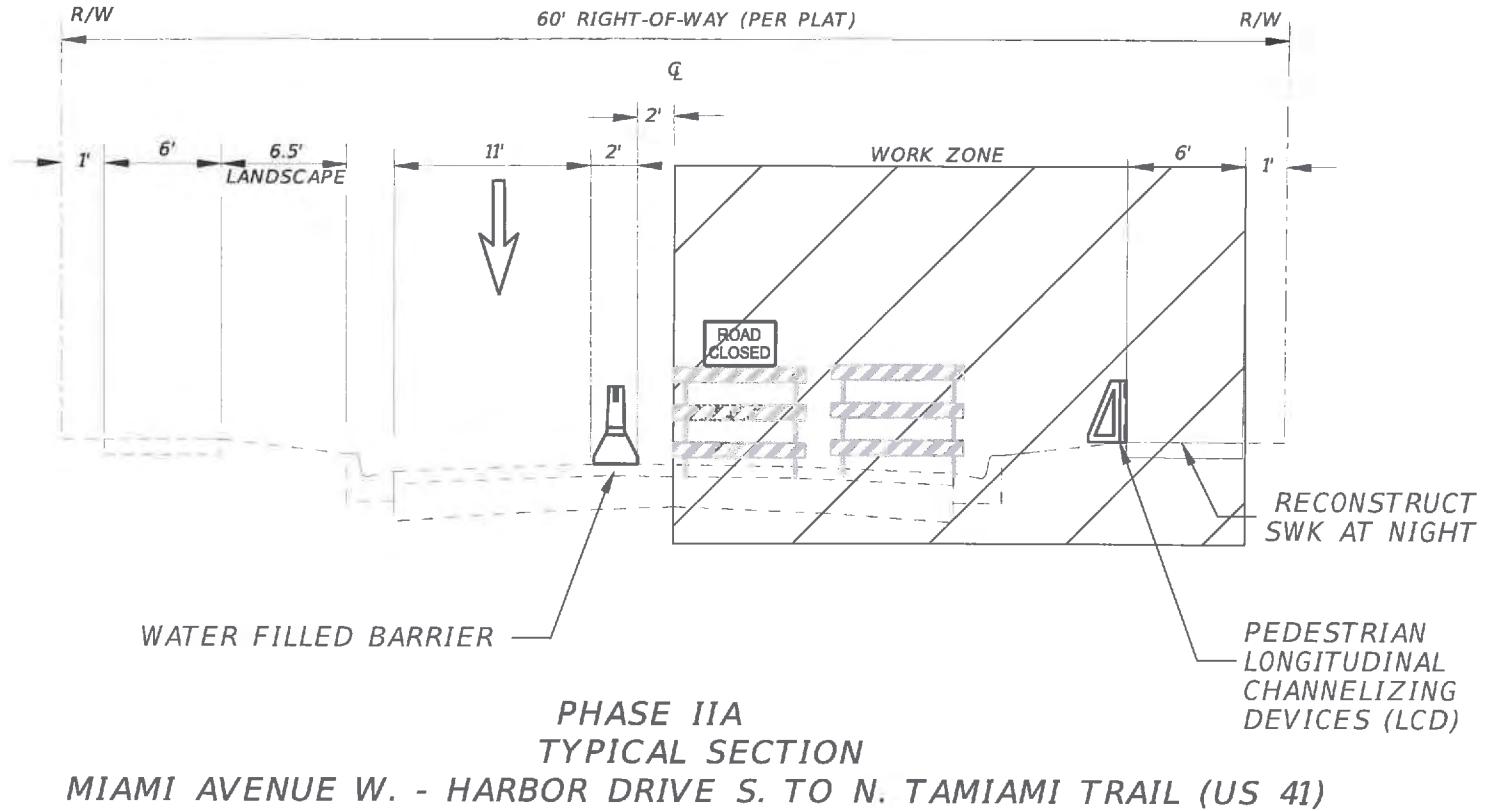

PHASE NOTES:

PHASE IIA


- CLOSE EB LANE USING FDOT DESIGN STANDARDS INDEX 603 AND THE TEMPORARY TRAFFIC CONTROL PLANS (SEE TTC PLANS PHASE IA). PLACE ADVANCED WARNING SIGNAGE AND CHANNELIZING DEVICES. CONSTRUCT DRAINAGE, ON STREET PARKING, CURB AND GUTTER, AND EB TRAVEL LANE.
- MAINTAIN SIDEWALK USING FDOT DESIGN STANDARDS INDEX 660. TOTAL SIDEWALK CLOSURES ADJACENT TO BUSINESS ENTRANCES WILL BE ALLOWED FROM 8:30 PM TO 6:00 AM AT THE DISCRETION OF THE ENGINEER.
- COMPLETE ROAD CLOSURES IN BOTH DIRECTION WILL BE ALLOW AT THE DISCRETION OF THE ENGINEER AFTER 10:00 PM.

LEGEND

- EXISTING LANE IDENTIFICATION AND DIRECTION OF TRAFFIC  
→ SHIFTED LANE IDENTIFICATION AND DIRECTION OF TRAFFIC



				PREPARED FOR: 	PREPARED BY: <b>ATKINS</b>	PROJECT: CITY OF VENICE DOWNTOWN ROADWAY CORRIDOR IMPROVEMENTS	DESCRIPTION: TTCP Typical Sections	APPROVED BY: JOHN SALATINO, P.E. P.E. LICENSE NUMBER 60921 ATKINS NORTH AMERICA (CERT. OF AUTH. NO. 24) 4030 WEST BOY SCOUT BOULEVARD, SUITE 700 TAMPA, FL 33607-1712	DATE: 2/28/2018 PROJECT NO.: 100054389 SHEET: 80
Page 969 of 1140	REV. NO.	DATE	DESCRIPTION	DESIGNED MLM	DRAWN MA	CHECKED MLM			

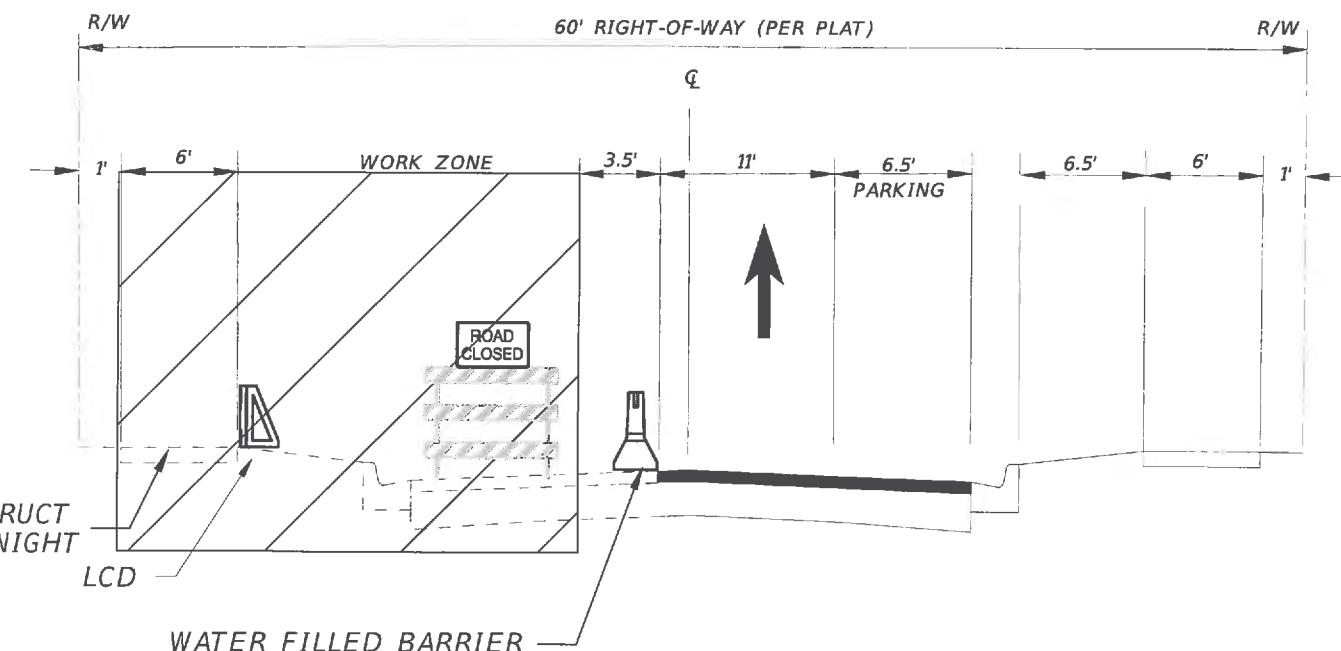

**PHASE IIB  
TYPICAL SECTION  
MIAMI AVENUE W. - HARBOR DRIVE S. TO N. TAMiami TRAIL (US 41)**

PHASE NOTES:

**PHASE IIB**

1. SHIFT TRAFFIC ONTO THE NEWLY CONSTRUCTED EB TRAVEL LANE.
2. CLOSE WB LANE USING FDOT DESIGN STANDARDS INDEX 603 AND THE TEMPORARY TRAFFIC CONTROL PLANS TO PLACE ADVANCED WARNING SIGNAGE AND CHANNELIZING DEVICES. CONSTRUCT DRAINAGE, CURB AND GUTTER FOR WB TRAVEL LANE.
3. CLOSE PARKING AT NIGHT, PLACE CHANNELIZING DEVICES AND SHIFT TRAFFIC 2' INTO PARKING SPACES USING TAPER RATES OF  $L=WS^2/60$  TO CONSTRUCT UP TO THE ADJOINING .
4. MAINTAIN SIDEWALK USING FDOT DESIGN STANDARDS INDEX 660. TOTAL SIDEWALK CLOSURES ADJACENT TO BUSINESS ENTRANCES WILL BE ALLOWED FROM 8:30 PM TO 6:00 AM AT THE DISCRETION OF THE ENGINEER
5. COMPLETE ROAD CLOSURES IN BOTH DIRECTION WILL BE ALLOW AT THE DISCRETION OF THE ENGINEER AFTER 10:00 PM.
6. RESTORE TRAFFIC EACH MORNING AS SHOWN ABOVE.
7. USE FDOT DESIGN STANDARDS INDEX 603 TO PLACE FINAL PAVEMENT COURSE AND FINAL STRIPING.
8. PLACE TRAFFIC IN FINAL CONFIGURATION.

LEGEND

→ EXISTING LANE IDENTIFICATION AND DIRECTION OF TRAFFIC


→ SHIFTED LANE IDENTIFICATION AND DIRECTION OF TRAFFIC



ACTIVE WORK ZONE



PREPARED FOR:	PREPARED BY:	PROJECT:	DESCRIPTION:	APPROVED BY:	DATE:	
DESIGNED MLM	DRAWN MA	ATKINS	CITY OF VENICE DOWNTOWN ROADWAY CORRIDOR IMPROVEMENTS	TTCP Typical Sections	JOHN SALATINO, P.E. P.E. LICENSE NUMBER 60921 ATKINS NORTH AMERICA (CERT. OF AUTH. NO. 24) 4030 WEST BOY SCOUT BOULEVARD, SUITE 700 TAMPA, FL 33607-1712	2/28/2018
DRAWN MA	ATKINS	TTCP Typical Sections	APPROVED BY:	JOHN SALATINO, P.E. P.E. LICENSE NUMBER 60921 ATKINS NORTH AMERICA (CERT. OF AUTH. NO. 24) 4030 WEST BOY SCOUT BOULEVARD, SUITE 700 TAMPA, FL 33607-1712	PROJECT NO.: 100054389	
REV. NO. DATE DESCRIPTION	Page 970 of 1140	REV. NO. DATE DESCRIPTION	SHEET: 81			

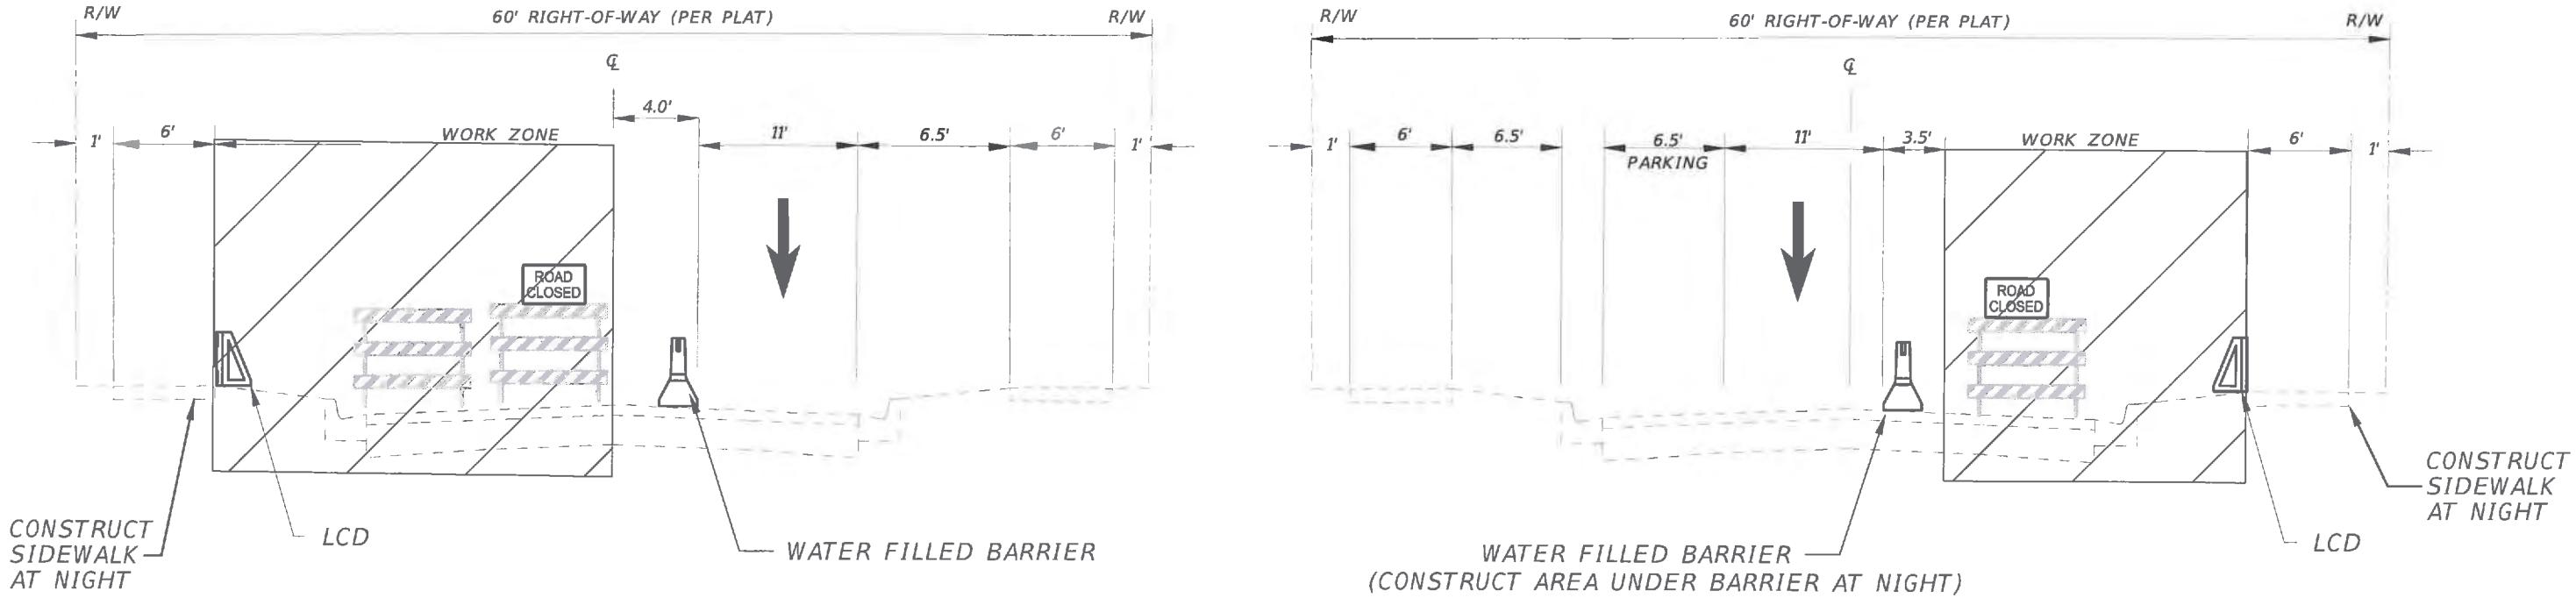


#### LEGEND


- EXISTING LANE IDENTIFICATION AND DIRECTION OF TRAFFIC
- SHIFTED LANE IDENTIFICATION AND DIRECTION OF TRAFFIC



PREPARED FOR:	PREPARED BY:	PROJECT:	DESCRIPTION:	APPROVED BY:	DATE:
DESIGNED MLM DRAWN MA CHECKED MLM	PREPARED BY:  <b>ATKINS</b>	PROJECT: CITY OF VENICE DOWNTOWN ROADWAY CORRIDOR IMPROVEMENTS	DESCRIPTION: TTCP Typical Sections	APPROVED BY: JOHN SALATINO, P.E. P.E. LICENSE NUMBER 60921 ATKINS NORTH AMERICA (CERT. OF AUTH. NO. 24) 4030 WEST BOY SCOUT BOULEVARD, SUITE 700 TAMPA, FL 33607-1712	DATE: 2/28/2018
Page 971 of 1140 REV. NO. DATE DESCRIPTION					PROJECT NO.: 100054389 SHEET: 82

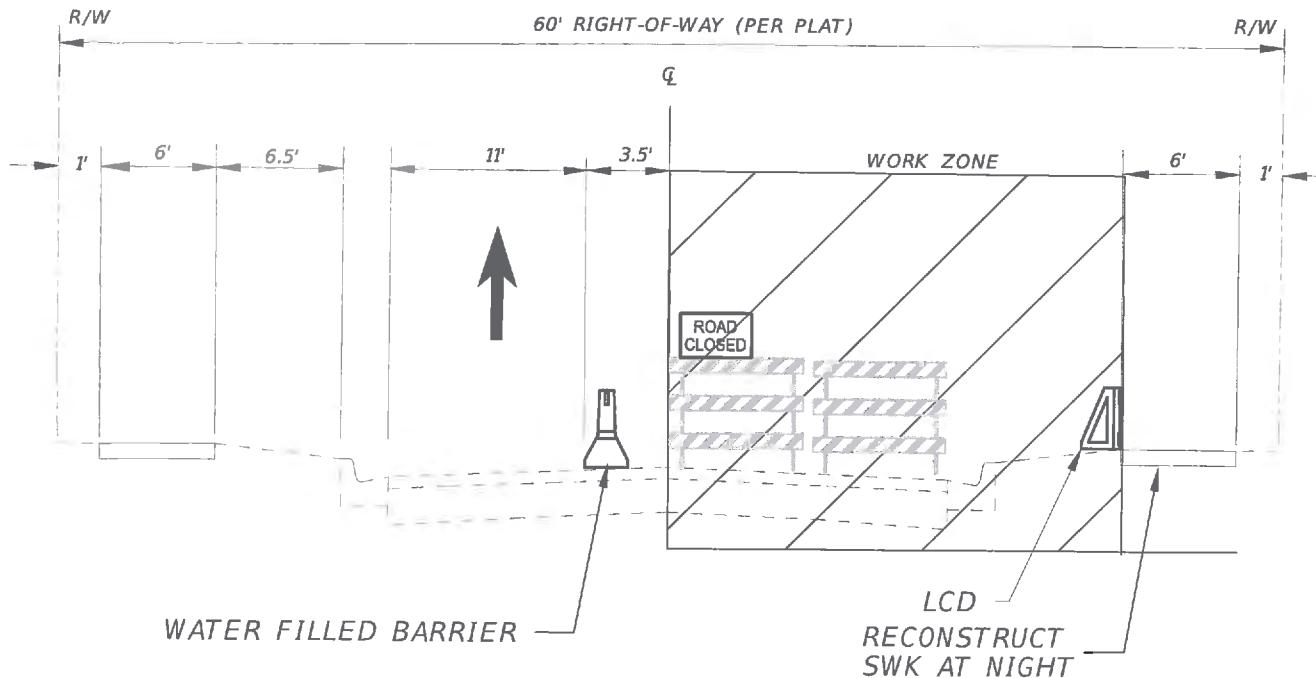

**PHASE IIIB**  
**TYPICAL SECTION**  
TAMPA AVENUE W. - HARBOR DRIVE N. TO NASSAU ST.

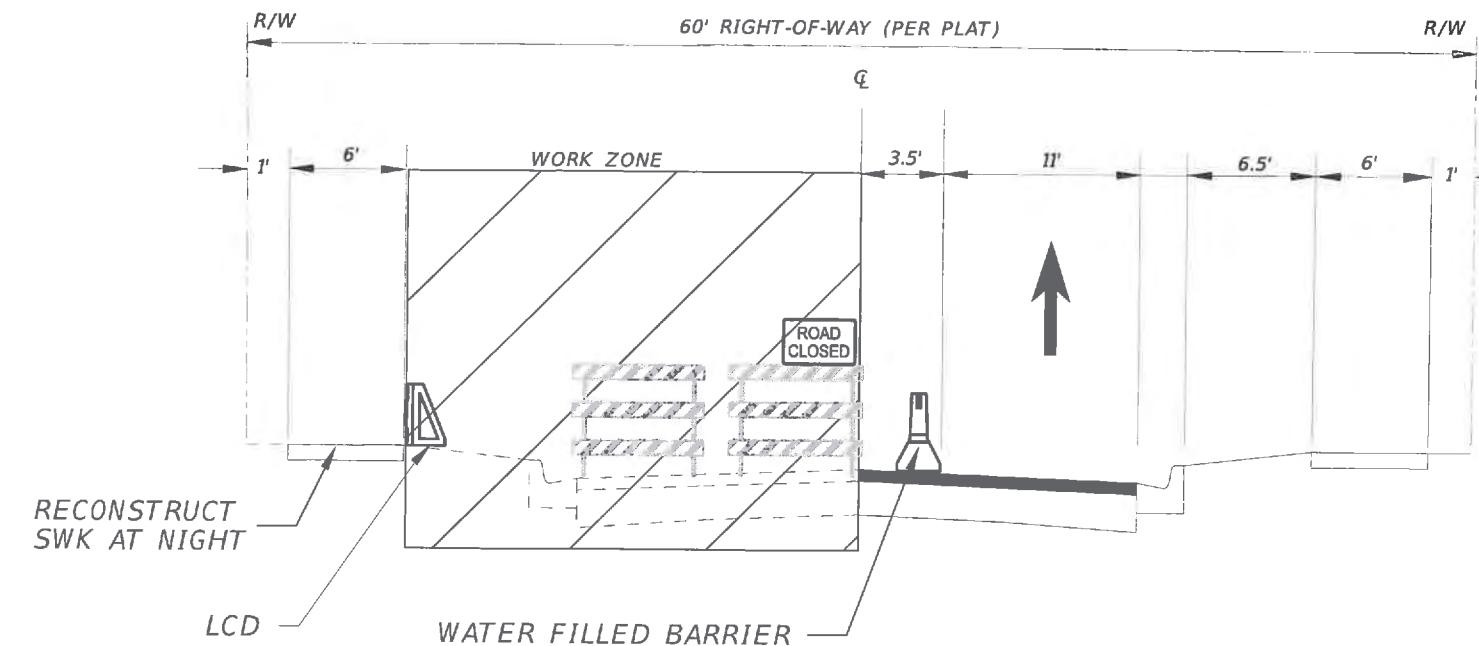

**PHASE IIIB**  
**TYPICAL SECTION**  
TAMPA AVENUE W. - NASSAU ST. TO N. TAMiami TRAIL (US 41)

PHASE NOTES:

PHASE IIIB (HARBOR DRIVE N. TO NASSAU ST.)

1. SHIFT EB TRAFFIC ONTO THE NEWLY CONSTRUCTED WB TRAVEL LANE.
2. CLOSE EB LANE USING FDOT DESIGN STANDARDS INDEX 603 AND THE TEMPORARY TRAFFIC CONTROL PLANS TO PLACE ADVANCED WARNING SIGNAGE AND CHANNELIZING DEVICES. CONSTRUCT DRAINAGE, CURB AND GUTTER FOR EB TRAVEL LANE. CONSTRUCT ONE BLOCK OF PARKING AT A TIME TO MINIMIZE PARKING IMPACTS.
3. SHIFT TRAFFIC AT THE INTERSECTION USING  $L=WS^2/60$  OR AS SHOWN IN THE TTC PLANS.
4. MAINTAIN SIDEWALK USING FDOT DESIGN STANDARDS INDEX 660. TOTAL SIDEWALK CLOSURES ADJACENT TO BUSINESS ENTRANCES WILL BE ALLOWED FROM 8:30 PM TO 6:00 AM AT THE DISCRETION OF THE ENGINEER
5. COMPLETE ROAD CLOSURES IN BOTH DIRECTION WILL BE ALLOW AT THE DISCRETION OF THE ENGINEER AFTER 10:00 PM.

PHASE IIIB (NASSAU ST. TO N. TAMiami TRAIL (US 41))

1. SHIFT TRAFFIC ONTO THE NEWLY CONSTRUCTED EB TRAVEL LANE.
2. CLOSE THE WB TRAVEL LANES USING FDOT DESIGN STANDARDS INDEX 603 AND THE TTC PLANS TO PLACE ADVANCED SIGNAGE AND CHANNELIZING DEVICES. CONSTRUCT DRAINAGE, CURBS, AND GUTTER FOR THE WB TRAVEL LANE.
3. MAINTAIN SIDEWALK USING FDOT DESIGN STANDARDS INDEX 660. TOTAL SIDEWALK CLOSURES ADJACENT TO BUSINESS ENTRANCES WILL BE ALLOWED FROM 8:30 PM TO 6:00 AM AT THE DISCRETION OF THE ENGINEER
4. COMPLETE ROAD CLOSURES IN BOTH DIRECTION WILL BE ALLOW AT THE DISCRETION OF THE ENGINEER AFTER 10:00 PM.

LEGEND

- EXISTING LANE IDENTIFICATION AND DIRECTION OF TRAFFIC  
→ SHIFTED LANE IDENTIFICATION AND DIRECTION OF TRAFFIC



ACTIVE WORK ZONE





JOHN A. SALATINO  
P.E.  
CITY OF VENICE  
STATE OF FLORIDA  
TAMPA, FL 33607-1712  
PHONE: (813) 473-2121  
FAX: (813) 473-2122  
E-MAIL: JOHN.SALATINO@CITYOFVENICE.COM  
DATE: 2/28/2018  
PROJECT NO.: 100054389  
SHEET: 83

DESIGNED	MLM	PREPARED FOR:	PREPARED BY:	PROJECT:	DESCRIPTION:	APPROVED BY:	DATE:
DRAWN	MA	Venice, FL City on the Gulf	ATKINS	CITY OF VENICE DOWNTOWN ROADWAY CORRIDOR IMPROVEMENTS	TTCP Typical Sections	JOHN SALATINO, P.E. P.E. LICENSE NUMBER 60921 ATKINS NORTH AMERICA (CERT. OF AUTH. NO. 24) 4030 WEST BOY SCOUT BOULEVARD, SUITE 700 TAMPA, FL 33607-1712	2/28/2018
REV. NO.	DATE	DESCRIPTION					PROJECT NO.: 100054389 SHEET: 83
Page 972 of 1140							


LEGEND

- Work Zone Sign
- Type III Barricade
- Channelizing Device (See Index 600)
- Existing Lane Identification and Direction of Traffic
- Shifted Lane Identification and Direction of Traffic
- Temporary Barrier (Water Filled)
- Active Work Zone
- Temporary Pavement
- Active Work Zone (LOCAL ACCESS ONLY)
- Pedestrian Midblock Crosswalk To Be Used With Pedestrian Detour At Night

N.T.S.

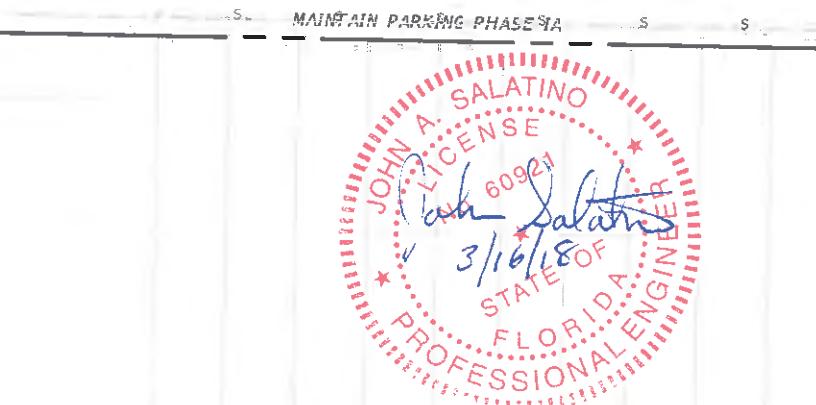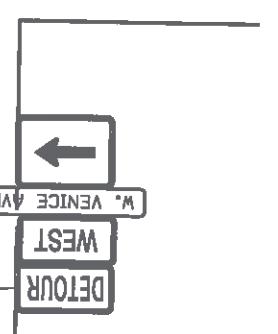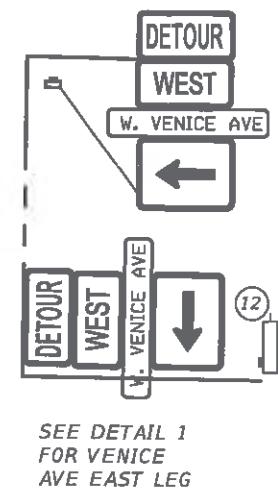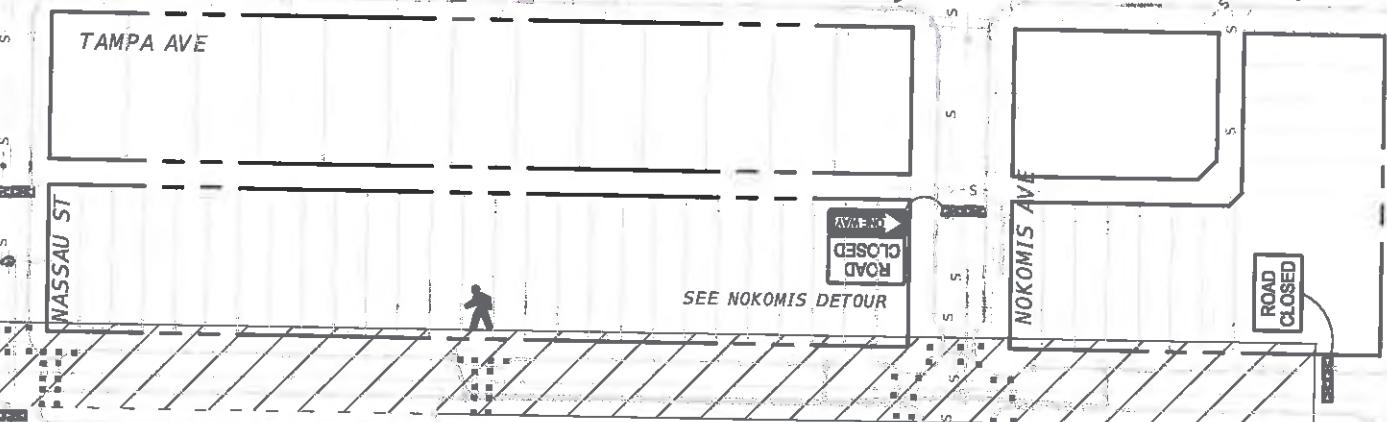

PREPARED FOR:	PREPARED BY:	PROJECT:	DESCRIPTION:	APPROVED BY:	DATE:
DESIGNED MLM		ATKINS	CITY OF VENICE DOWNTOWN ROADWAY CORRIDOR IMPROVEMENTS	TTCP Phase IA	3/16/2018
DRAWN MA				JOHN SALATINO, P.E. P.E. LICENSE NUMBER 60921 ATKINS NORTH AMERICA (CERT. OF AUTH. NO. 24) 4030 WEST BOY SCOUT BOULEVARD, SUITE 700 TAMPA, FL 33607-1712	DATE PROJECT NO.: SHEET:
CHECKED MLM					100054389 84

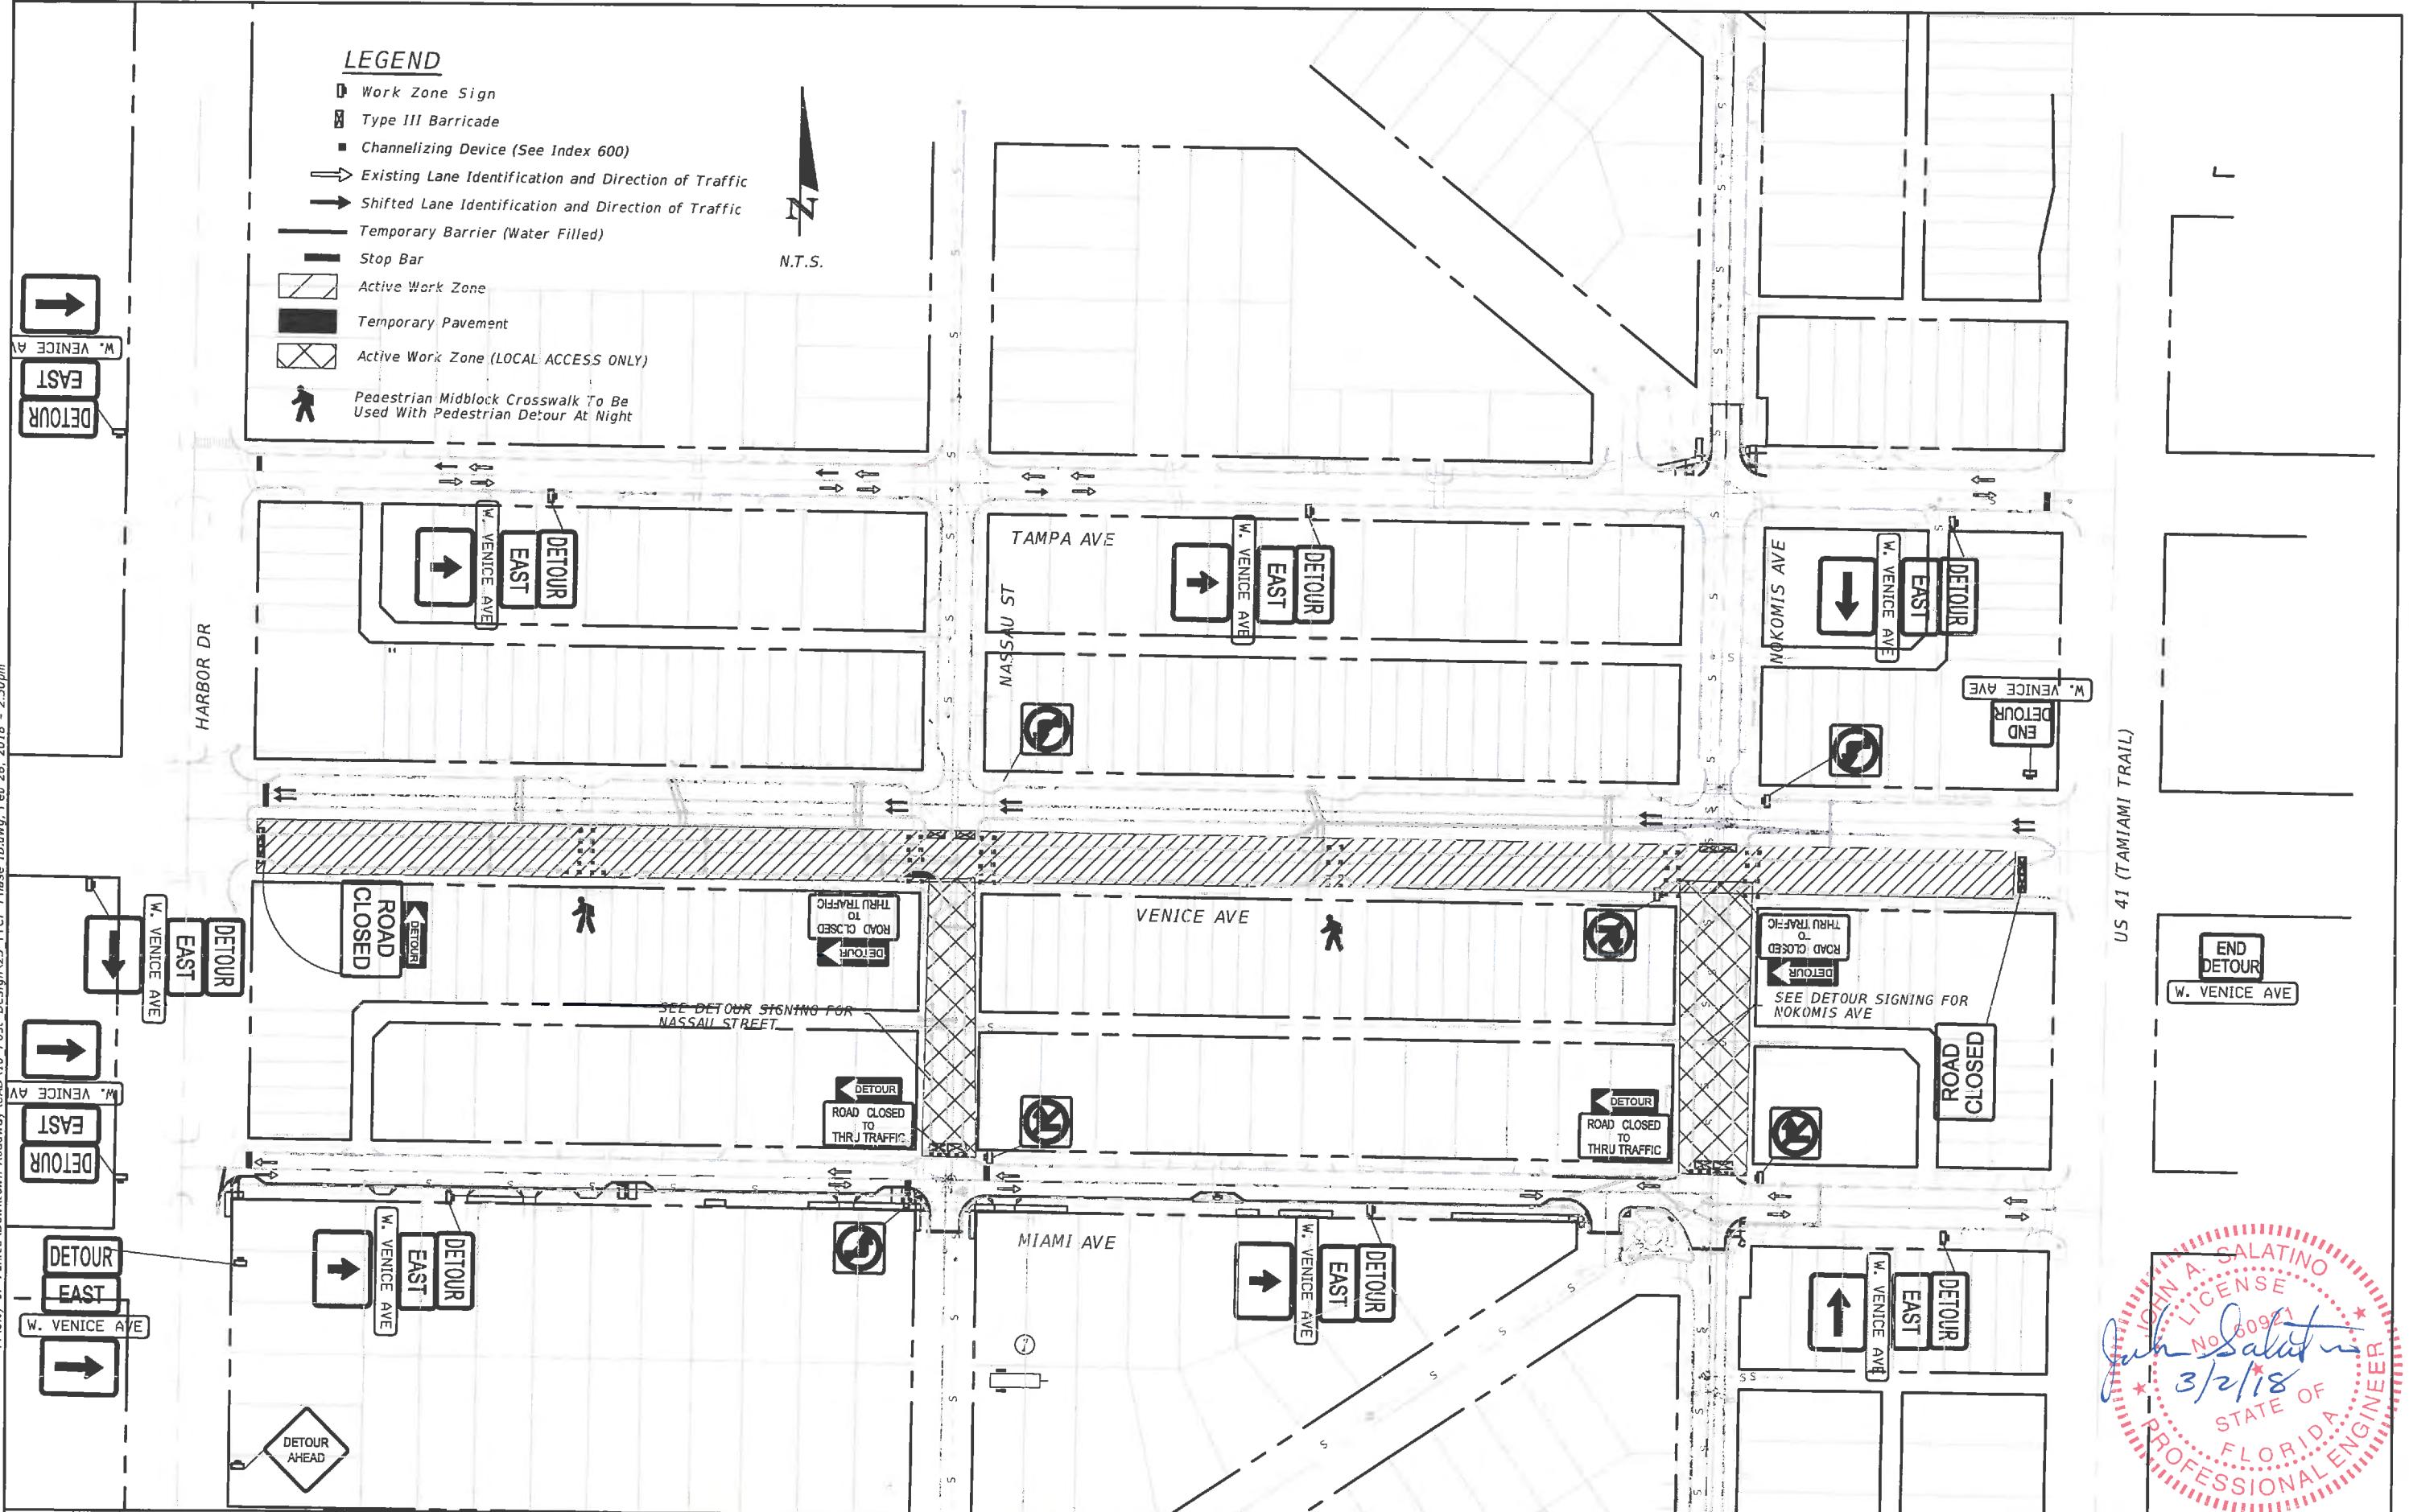

JOHN A. SALATINO  
No. 60921  
3/2/18  
STATE OF  
FLORIDA  
PROFESSIONAL ENGINEER

LEGEND

- Work Zone Sign
  - Type III Barricade
  - Channelizing Device (See Index 600)
  -  Existing Lane Identification and Direction of Traffic
  -  Shifted Lane Identification and Direction of Traffic

---

  - Temporary Barrier (Water Filled)
  -  Active Work Zone
  -  Temporary Pavement
  -  Active Work Zone (LOCAL ACCESS ONLY)
  
  -  Pedestrian Midblock Crosswalk To Be Used With Pedestrian Detour At Night



N.T.




			PREPARED FOR:	PREPARED BY:	PROJECT:	DESCRIPTION:	APPROVED BY:	DATE:
			DESIGNED MLM		CITY OF VENICE DOWNTOWN ROADWAY CORRIDOR IMPROVEMENTS	TTCP Phase IIA	JOHN SALATINO, P.E. P.E. LICENSE NUMBER 60921 ATKINS NORTH AMERICA (CERT. OF AUTH. NO. 24) 4030 WEST BOY SCOUT BOULEVARD, SUITE 700 TAMPA, FL 33607-1712	3/16/2018
			DRAWN MA	ATKINS				PROJECT NO.: 100054389
			CHECKED MLM					SHEET: 86
REV. NO.	DATE	DESCRIPTION						

**LEGEND**

- Work Zone Sign
- Type III Barricade
- Channelizing Device (See Index 600)
- Existing Lane Identification and Direction of Traffic
- Shifted Lane Identification and Direction of Traffic
- Temporary Barrier (Water Filled)
- Stop Bar
- Active Work Zone
- Temporary Pavement
- Active Work Zone (LOCAL ACCESS ONLY)
- Pedestrian Midblock Crosswalk To Be Used With Pedestrian Detour At Night

N.T.S.

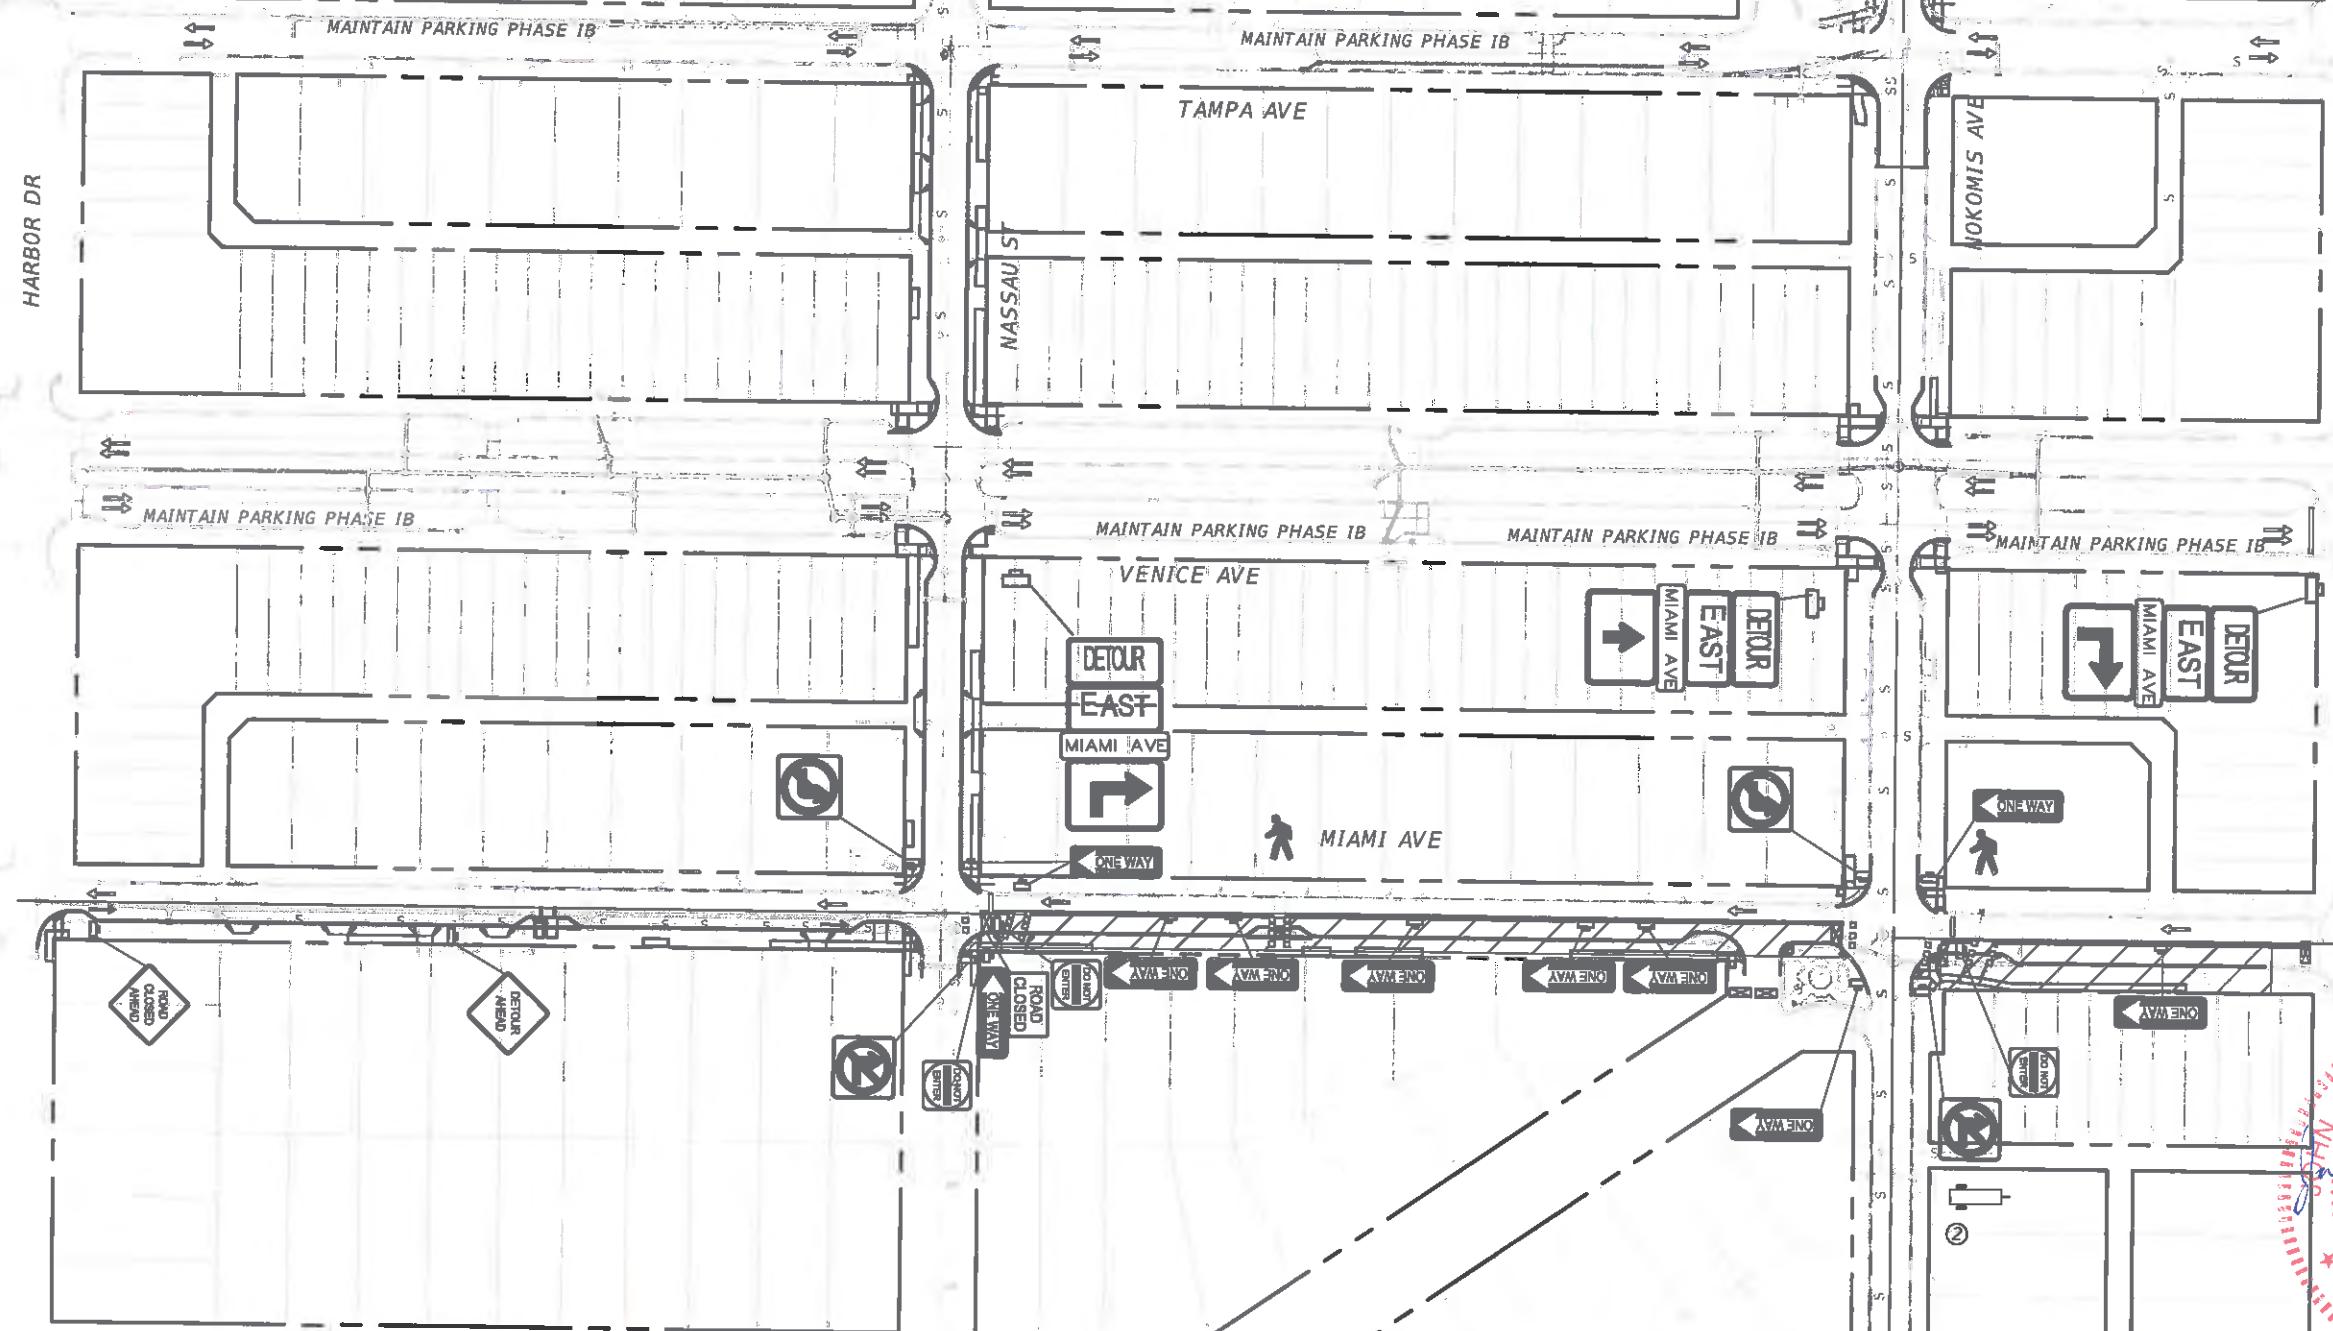

US 41 (TAMiami TRAIL)



PREPARED FOR:	PREPARED BY:	PROJECT:	DESCRIPTION:	APPROVED BY:	DATE:
DESIGNED MLM	DRAWN MA	PROJECT: CITY OF VENICE DOWNTOWN ROADWAY CORRIDOR IMPROVEMENTS	DESCRIPTION: TTCP Phase IIA	APPROVED BY: JOHN SALATINO, P.E., P.E. LICENSE NUMBER 60921 ATKINS NORTH AMERICA (CERT. OF AUTH. NO. 24) 4030 WEST BOY SCOUT BOULEVARD, SUITE 700 TAMPA, FL 33607-1712	DATE: 3/15/2018
DRAWN MA	ATKINS	REV. NO. DATE DESCRIPTION	DATE: PROJECT NO.: SHEET:	100054389 87	
CHECKED MLM	Venice, FL city on the Gulf				

**LEGEND**

- Work Zone Sign
- Type III Barricade
- Channelizing Device (See Index 600)
- Existing Lane Identification and Direction of Traffic
- Shifted Lane Identification and Direction of Traffic
- Temporary Barrier (Water Filled)
- Stop Bar
- Active Work Zone
- Temporary Pavement
- Active Work Zone (LOCAL ACCESS ONLY)
- Pedestrian Midblock Crossover To Be Used With Pedestrian Detour At Night

N.T.S.


HARBOR DR

TAMPA AVE

VENICE AVE

MIAMI AVE


US 41 (MIAMI TRAIL)

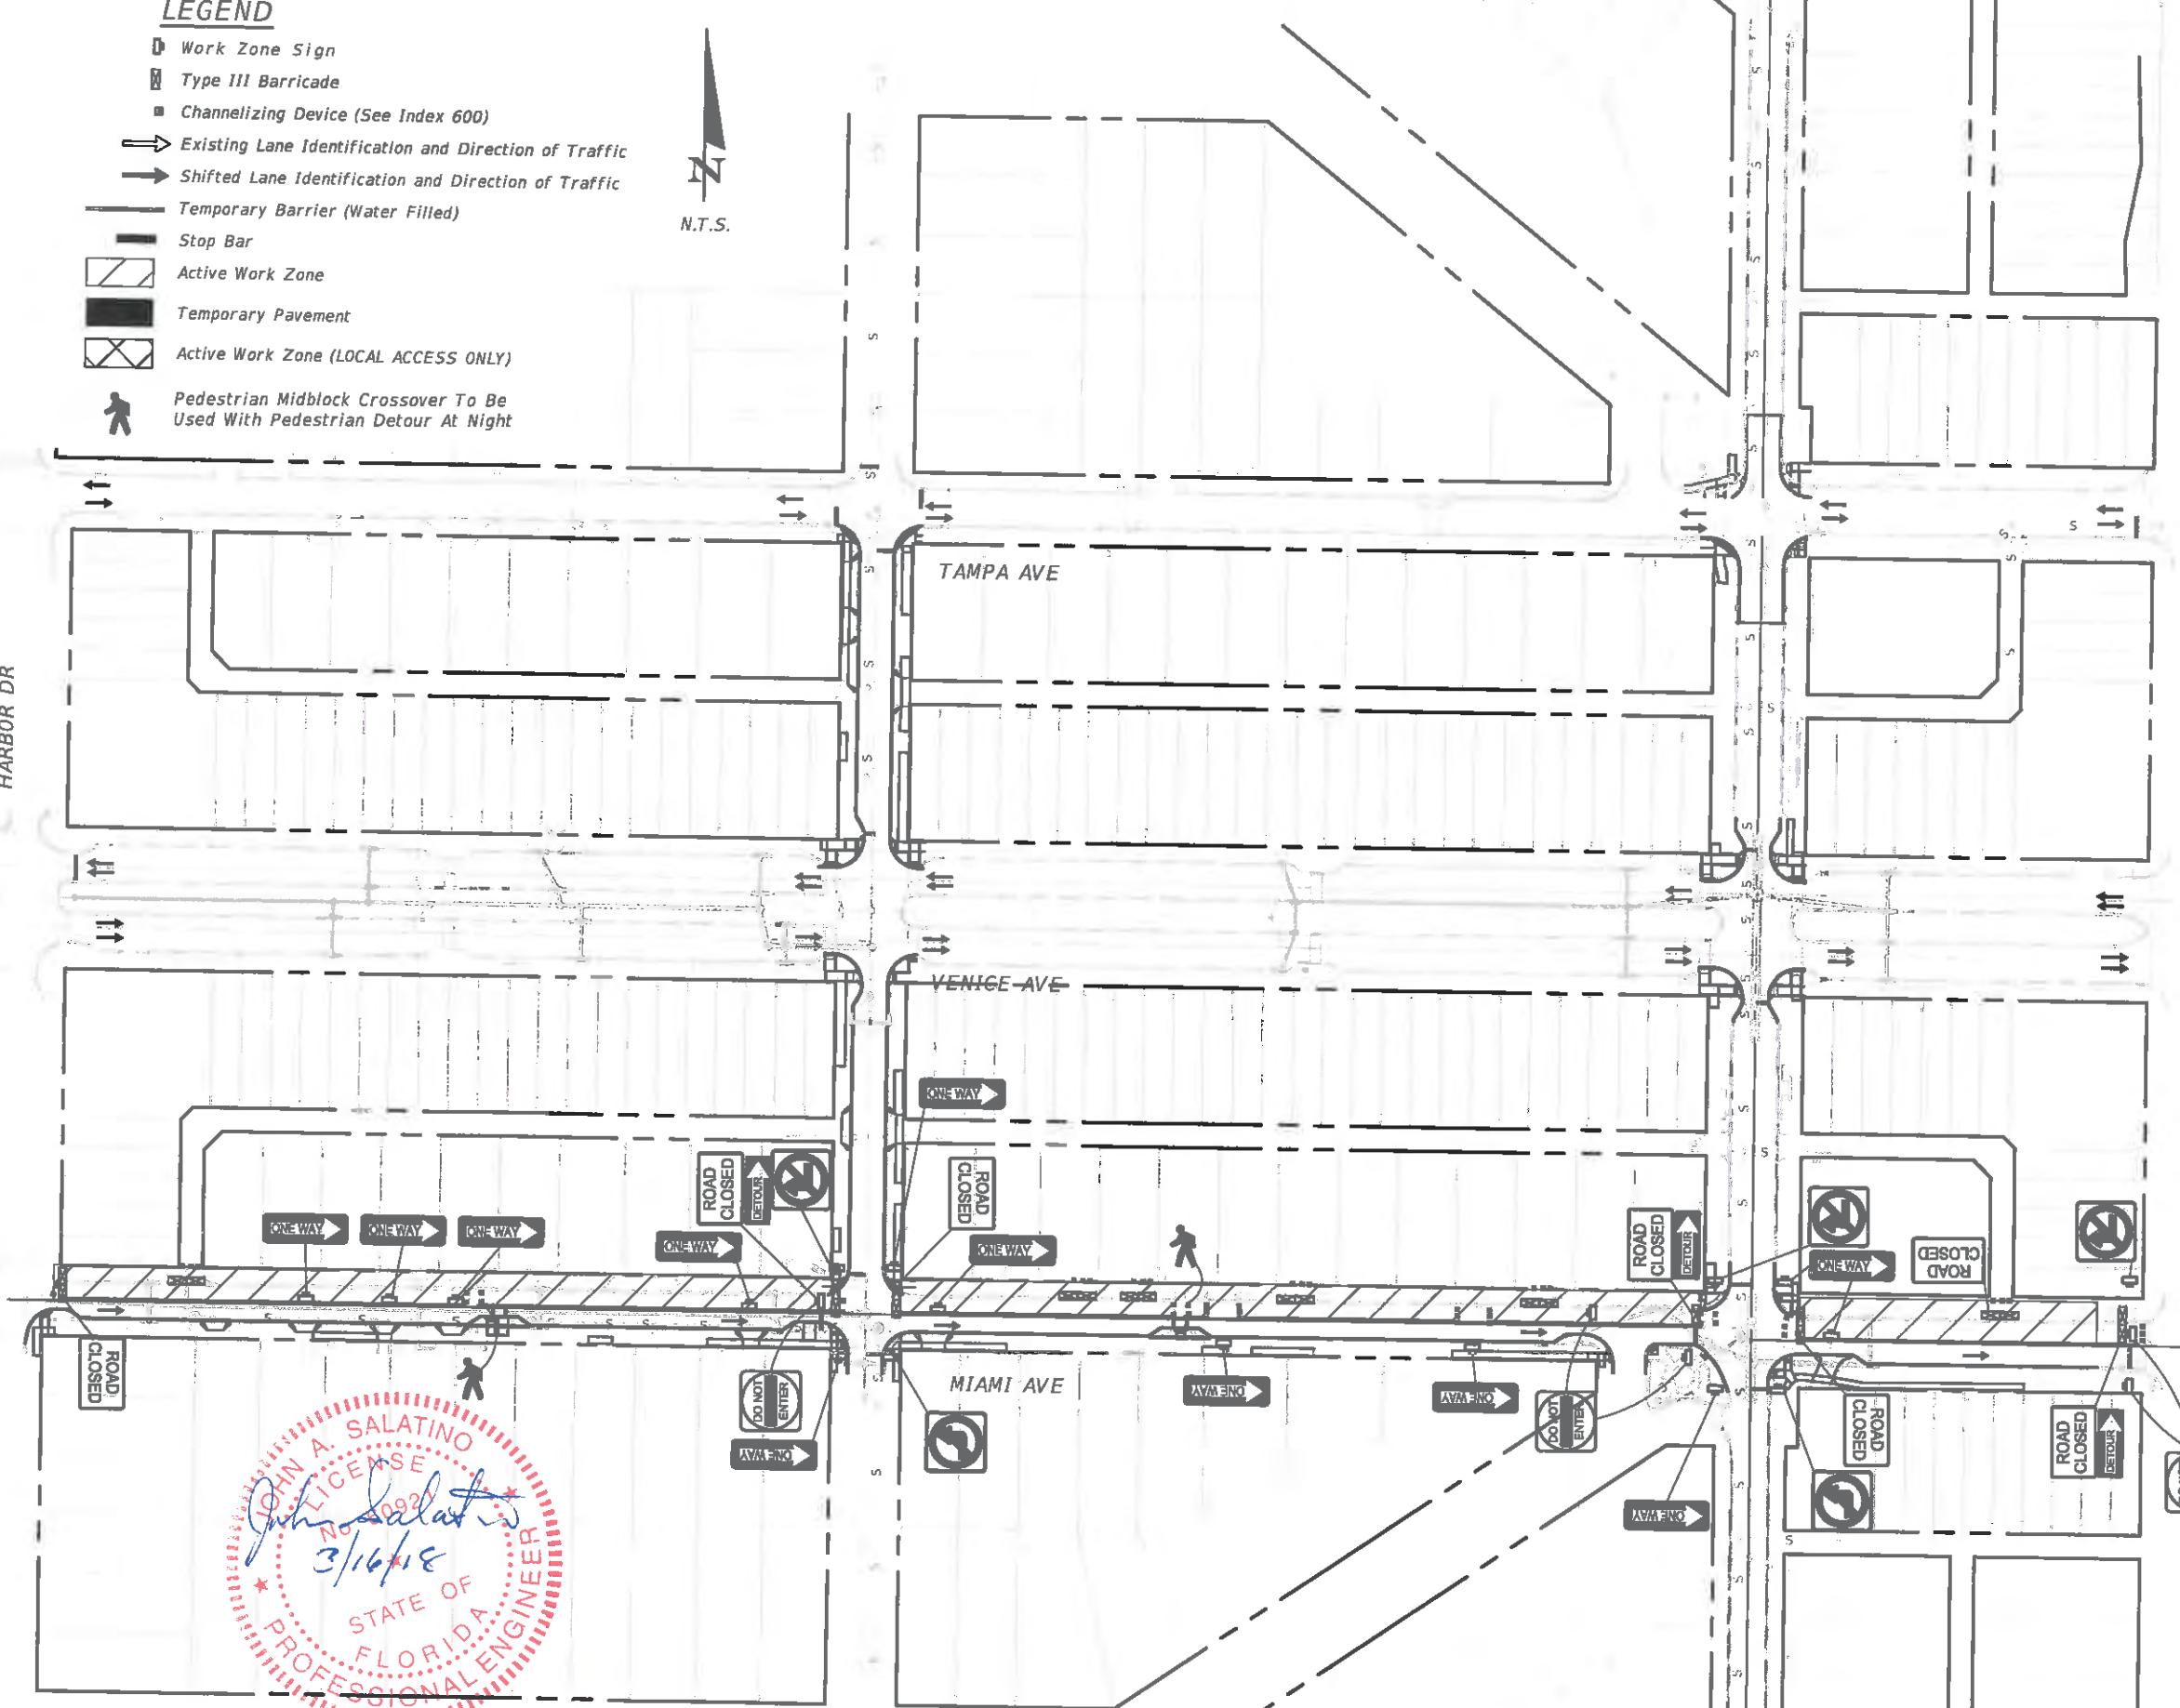SEE DETAIL 4  
MIAMI AVE  
EAST LEG

PREPARED FOR:	PREPARED BY:	PROJECT:	DESCRIPTION:	APPROVED BY:	DATE:
DESIGNED MLM	PREPARED BY:	PROJECT:	DESCRIPTION:	APPROVED BY:	DATE:
DRAWN MA	ATKINS	CITY OF VENICE DOWNTOWN ROADWAY CORRIDOR IMPROVEMENTS	TTCP Phase IIB	JOHN SALATINO, P.E. P.E. LICENSE NUMBER 60921 ATKINS NORTH AMERICA (CERT. OF AUTH. NO. 24) 4030 WEST BOY SCOUT BOULEVARD, SUITE 700 TAMPA, FL 33607-1712	3/15/2018
CHECKED MLM					PROJECT NO.: 100054389 SHEET: 88

LEGEND

- Work Zone Sign
- Type III Barricade
- Channelizing Device (See Index 600)
- Existing Lane Identification and Direction of Traffic
- Shifted Lane Identification and Direction of Traffic
- Temporary Barrier (Water Filled)
- Stop Bar
- Active Work Zone
- Temporary Pavement
- Active Work Zone (LOCAL ACCESS ONLY)
- Pedestrian Midblock Crosswalk To Be Used With Pedestrian Detour At Night

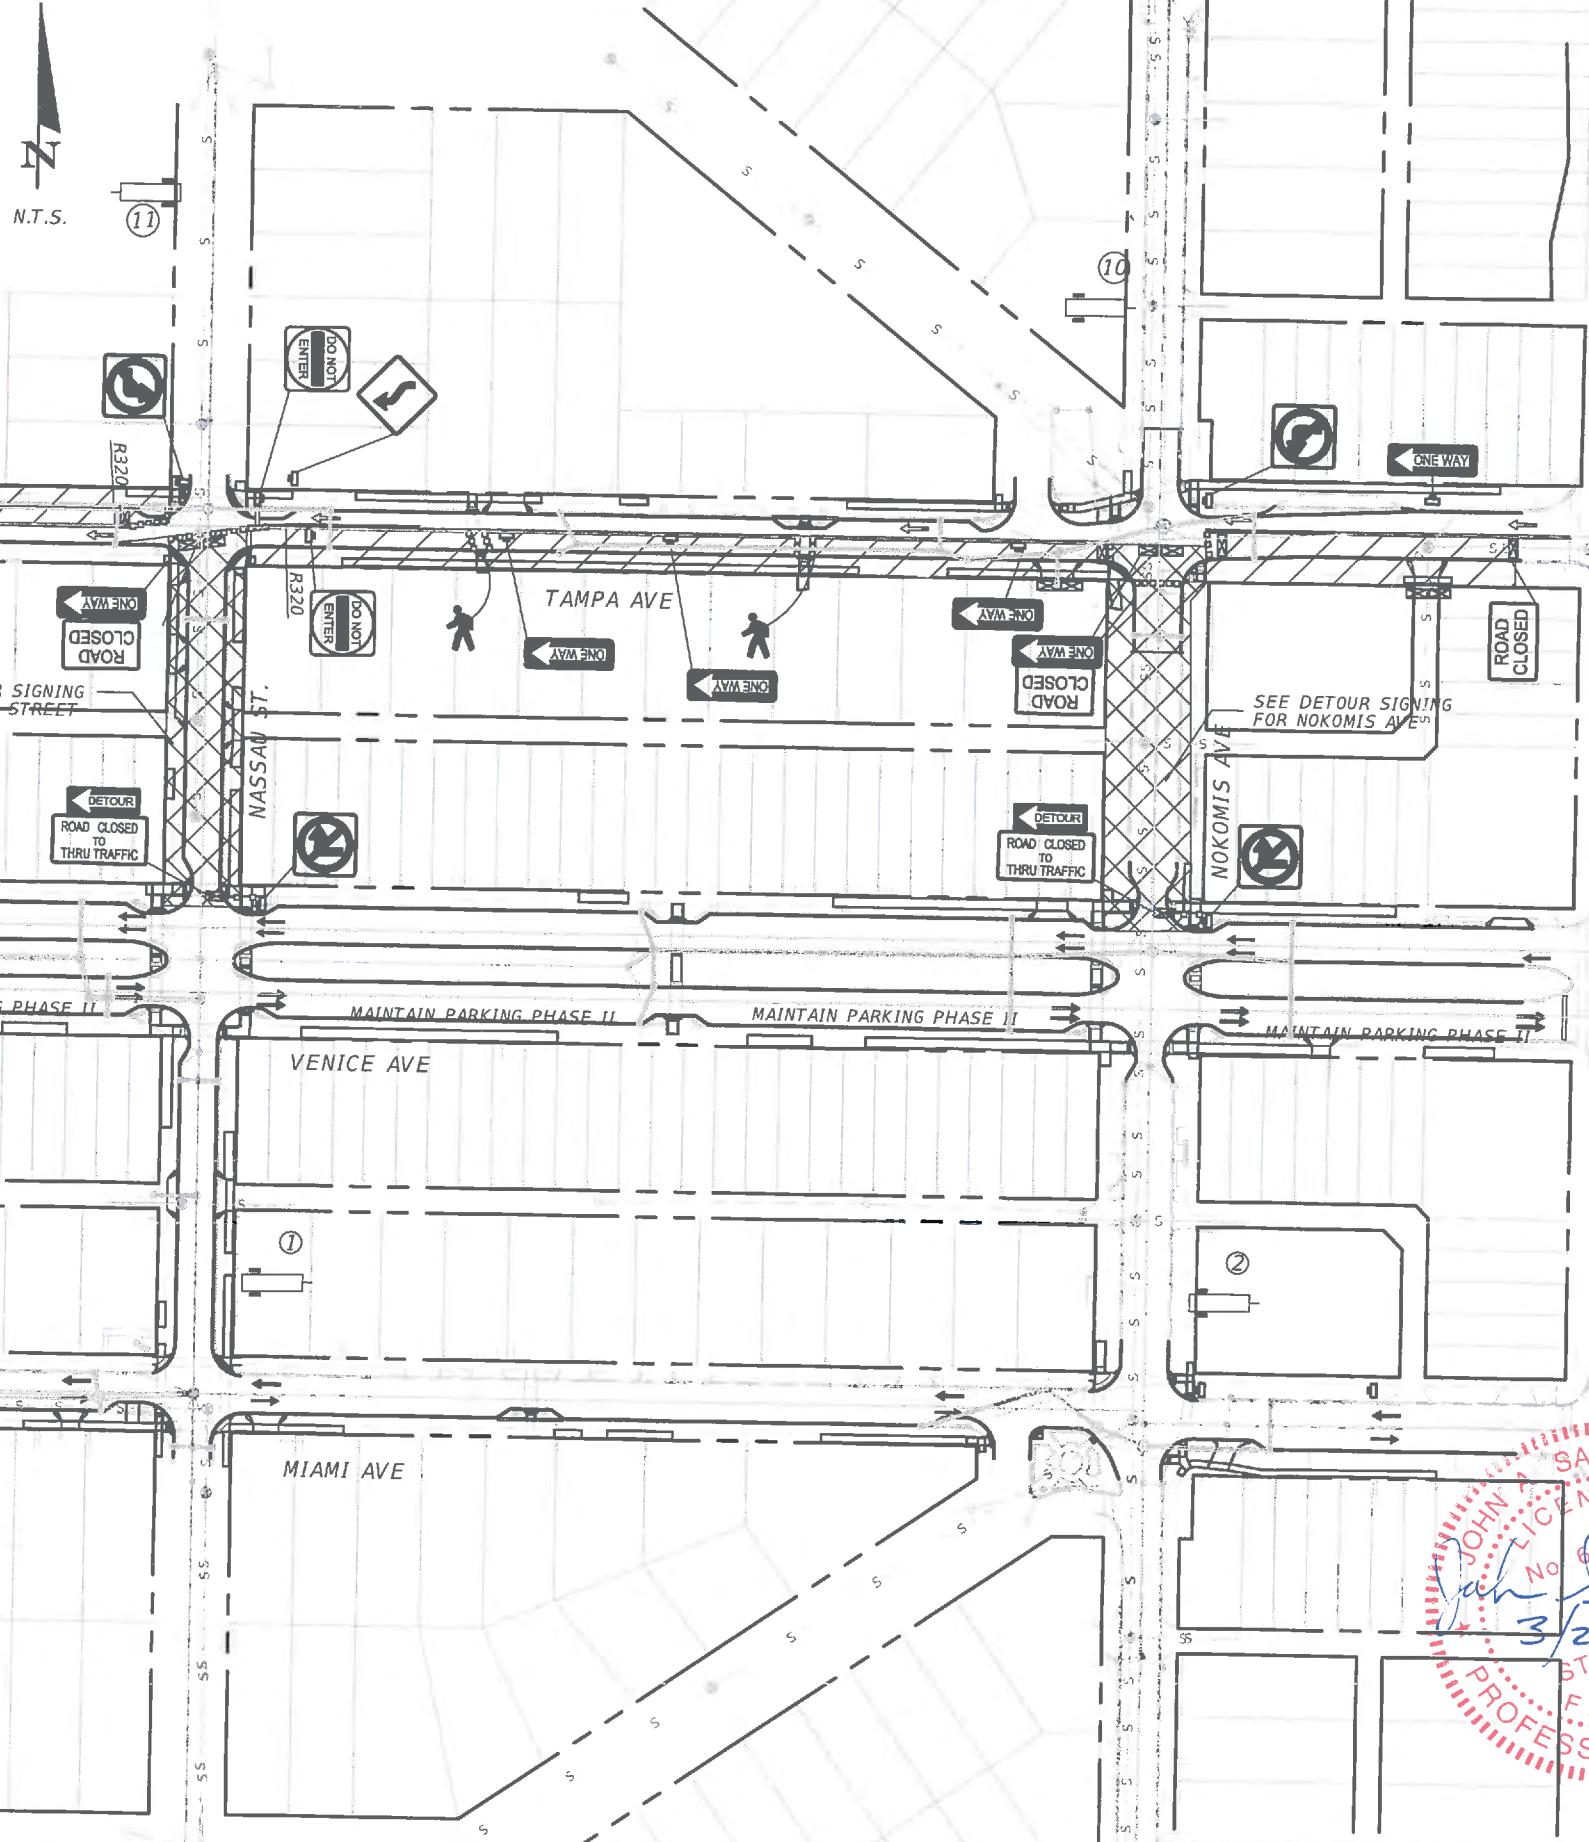
SEE DETAIL 1  
VENICE AVE  
EAST LEG

PREPARED FOR:	PREPARED BY:	PROJECT:	DESCRIPTION:	APPROVED BY:	DATE:	
DESIGNED MLM					2/28/2018	
DRAWN MA					PROJECT NO.: 100054389	
CHECKED MLM					SHEET: 89	
REV. NO. Page 978 of 1140	DATE DESCRIPTION	Venice, FL City on the Gulf	ATKINS	CITY OF VENICE DOWNTOWN ROADWAY CORRIDOR IMPROVEMENTS	TTCP Phase IIIA	JOHN A. SALATINO, P.E. P.E. LICENSE NUMBER 60921 ATKINS NORTH AMERICA (CERT. OF AUTH. NO. 24) 4030 WEST BOY SCOUT BOULEVARD, SUITE 700 TAMPA, FL 33607-1712

LEGEND

- Work Zone Sign
- Type III Barricade
- Channelizing Device (See Index 600)
- Existing Lane Identification and Direction of Traffic
- Shifted Lane Identification and Direction of Traffic
- Temporary Barrier (Water Filled)
- Stop Bar
- Active Work Zone
- Temporary Pavement
- Active Work Zone (LOCAL ACCESS ONLY)


Pedestrian Midblock crosswalk To Be  
Used With Pedestrian Detour At Night

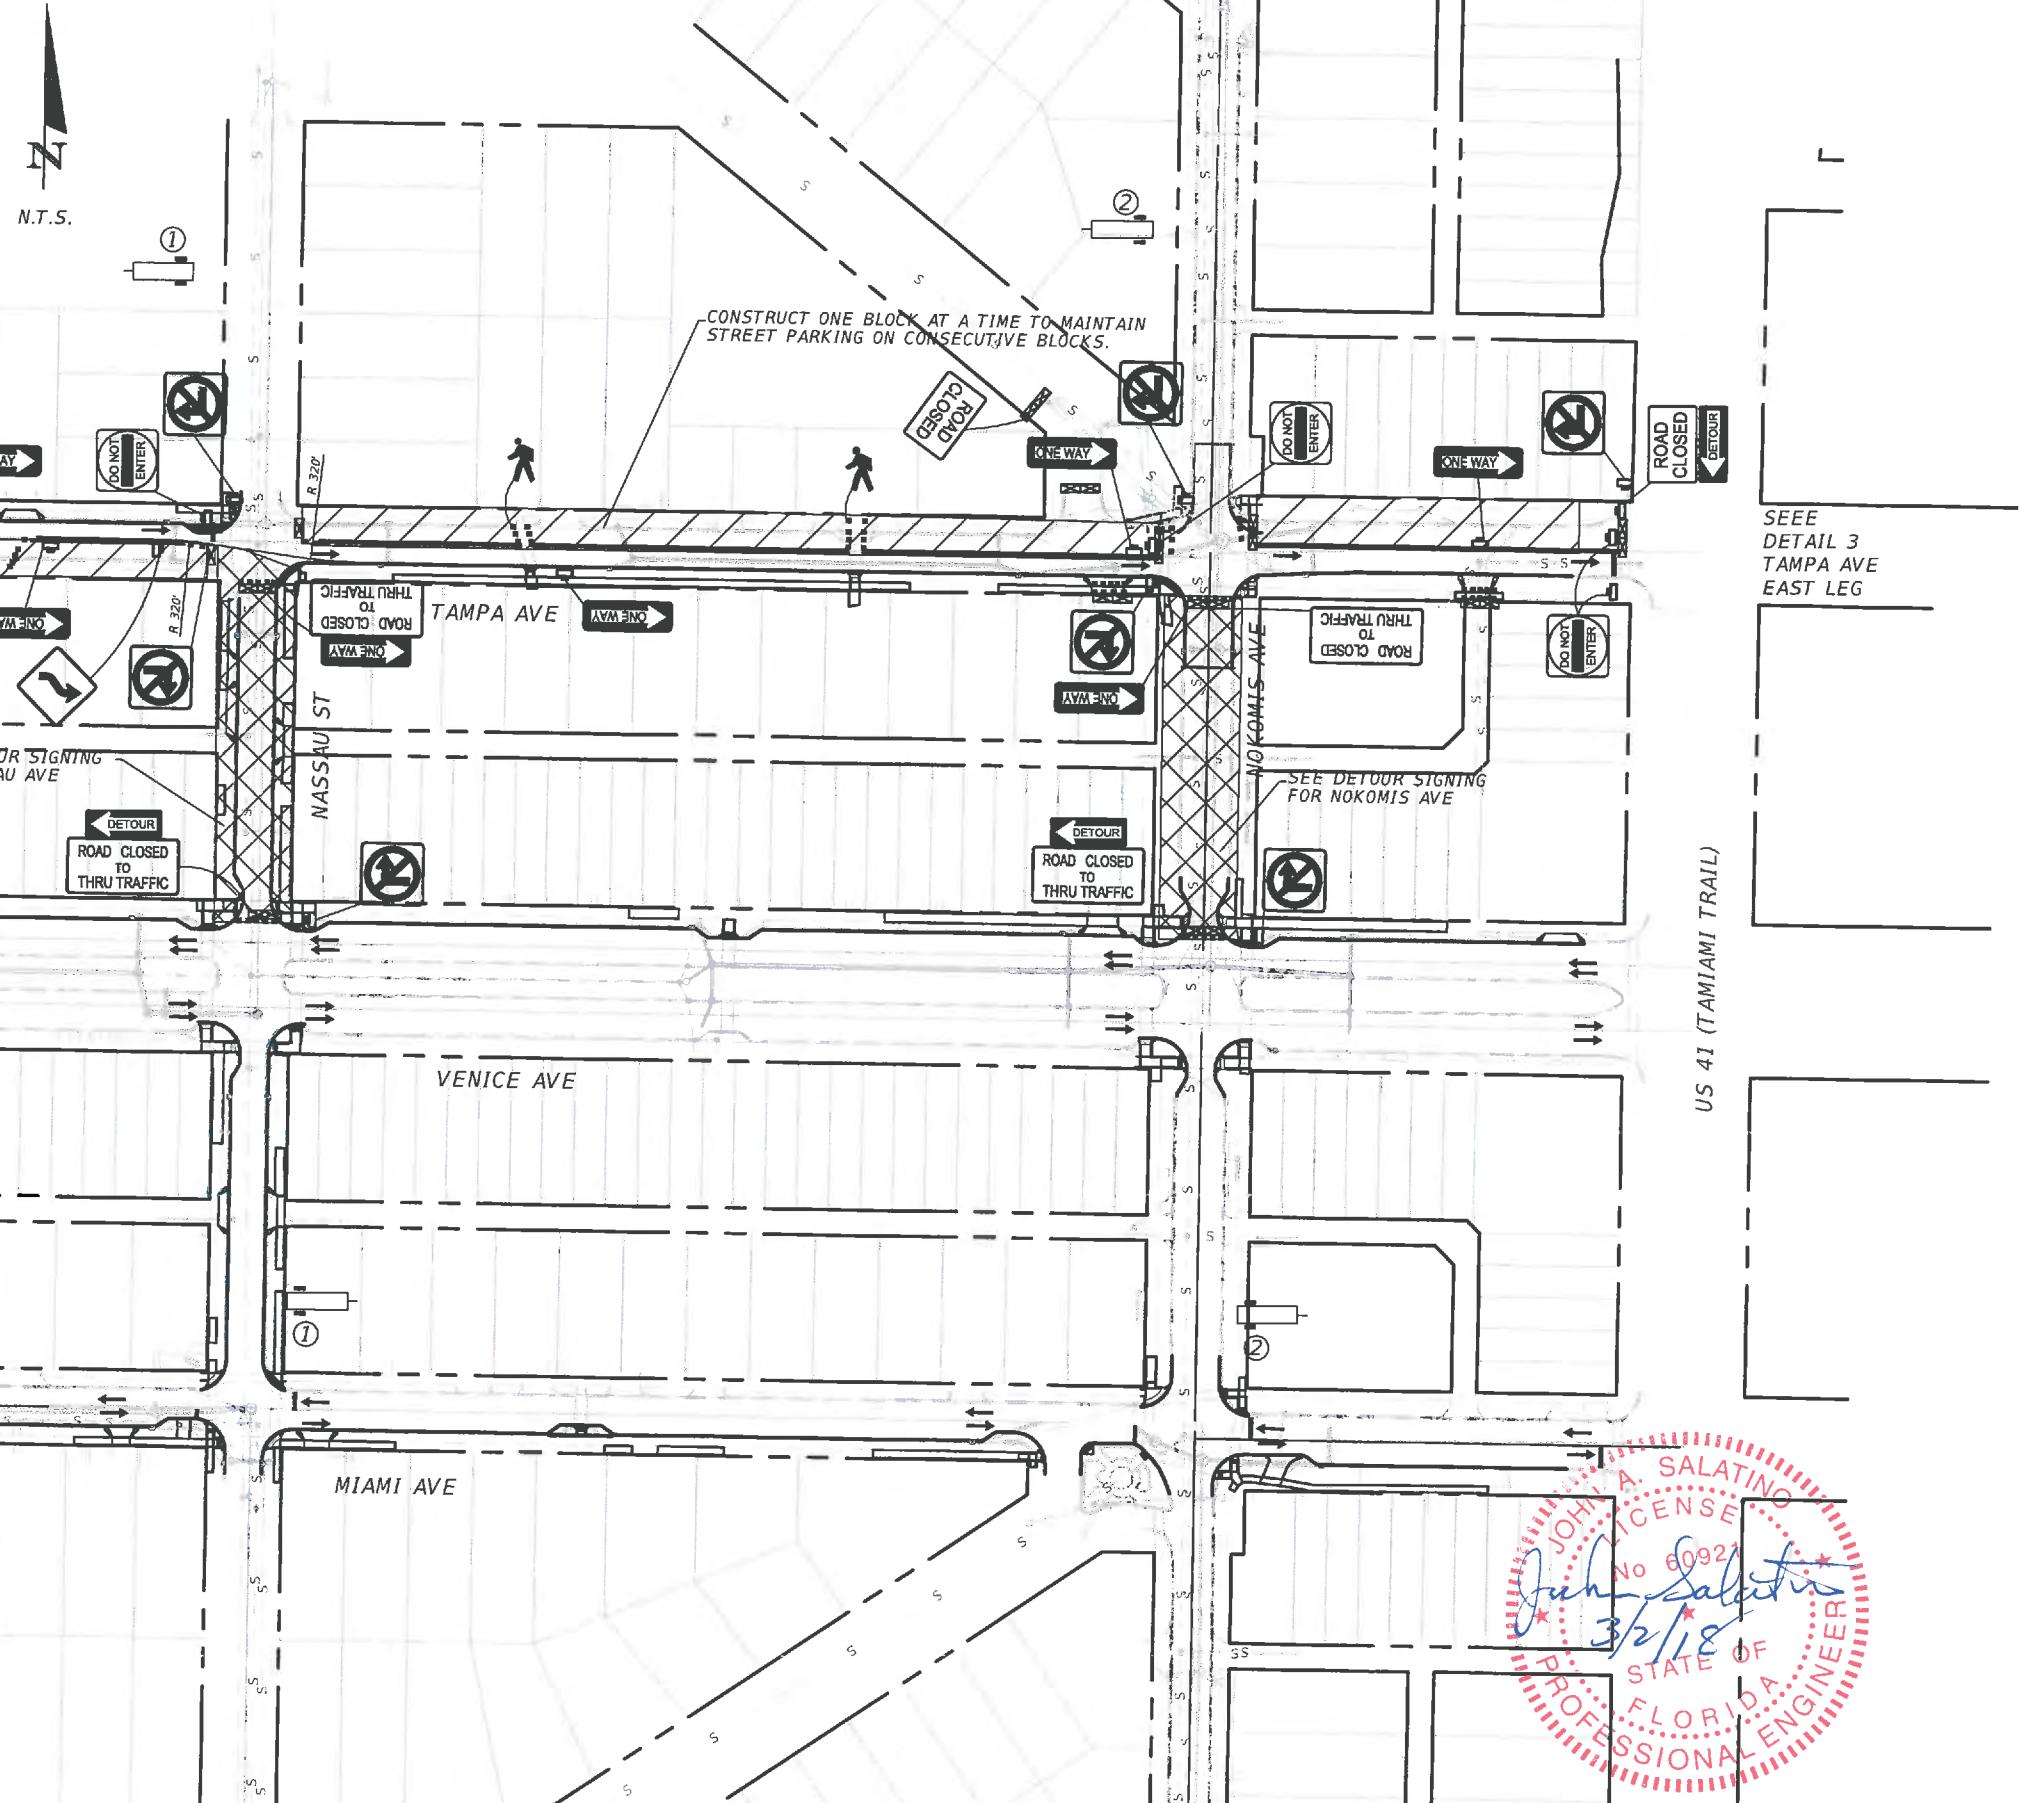

PREPARED FOR:	PREPARED BY:	PROJECT:	DESCRIPTION:	APPROVED BY:	DATE:
DESIGNED MLM					2/28/2018
DRAWN MA					PROJECT NO.: 100054389
CHECKED MLM					SHEET: 90
REV. NO. Page 979 of 1140	Venice, FL City on the Gulf	ATKINS	CITY OF VENICE DOWNTOWN ROADWAY CORRIDOR IMPROVEMENTS	TTCP Phase IIIB	JOHN SALATINO, P.E. P.E. LICENSE NUMBER 60921 ATKINS NORTH AMERICA (CERT. OF AUTH. NO. 24) 4030 WEST BOY SCOUT BOULEVARD, SUITE 700 TAMPA, FL 33607-1712

TTCP - PHASE IA  
DETAIL 1


			PREPARED FOR:	PREPARED BY:	PROJECT:	DESCRIPTION:	APPROVED BY:	DATE:
			DESIGNED MLM		CITY OF VENICE	TTCP	JOHN SALATINO, P.E.	2/28/2018
			DRAWN MA	ATKINS	DOWNTOWN ROADWAY	DATE	P.E. LICENSE NUMBER 60921	PROJECT NO.: 100054389
			CHECKED MLM		CORRIDOR IMPROVEMENTS	Suite 700	ATKINS NORTH AMERICA (CERT. OF AUTH. No. 24)	SHEET: 91

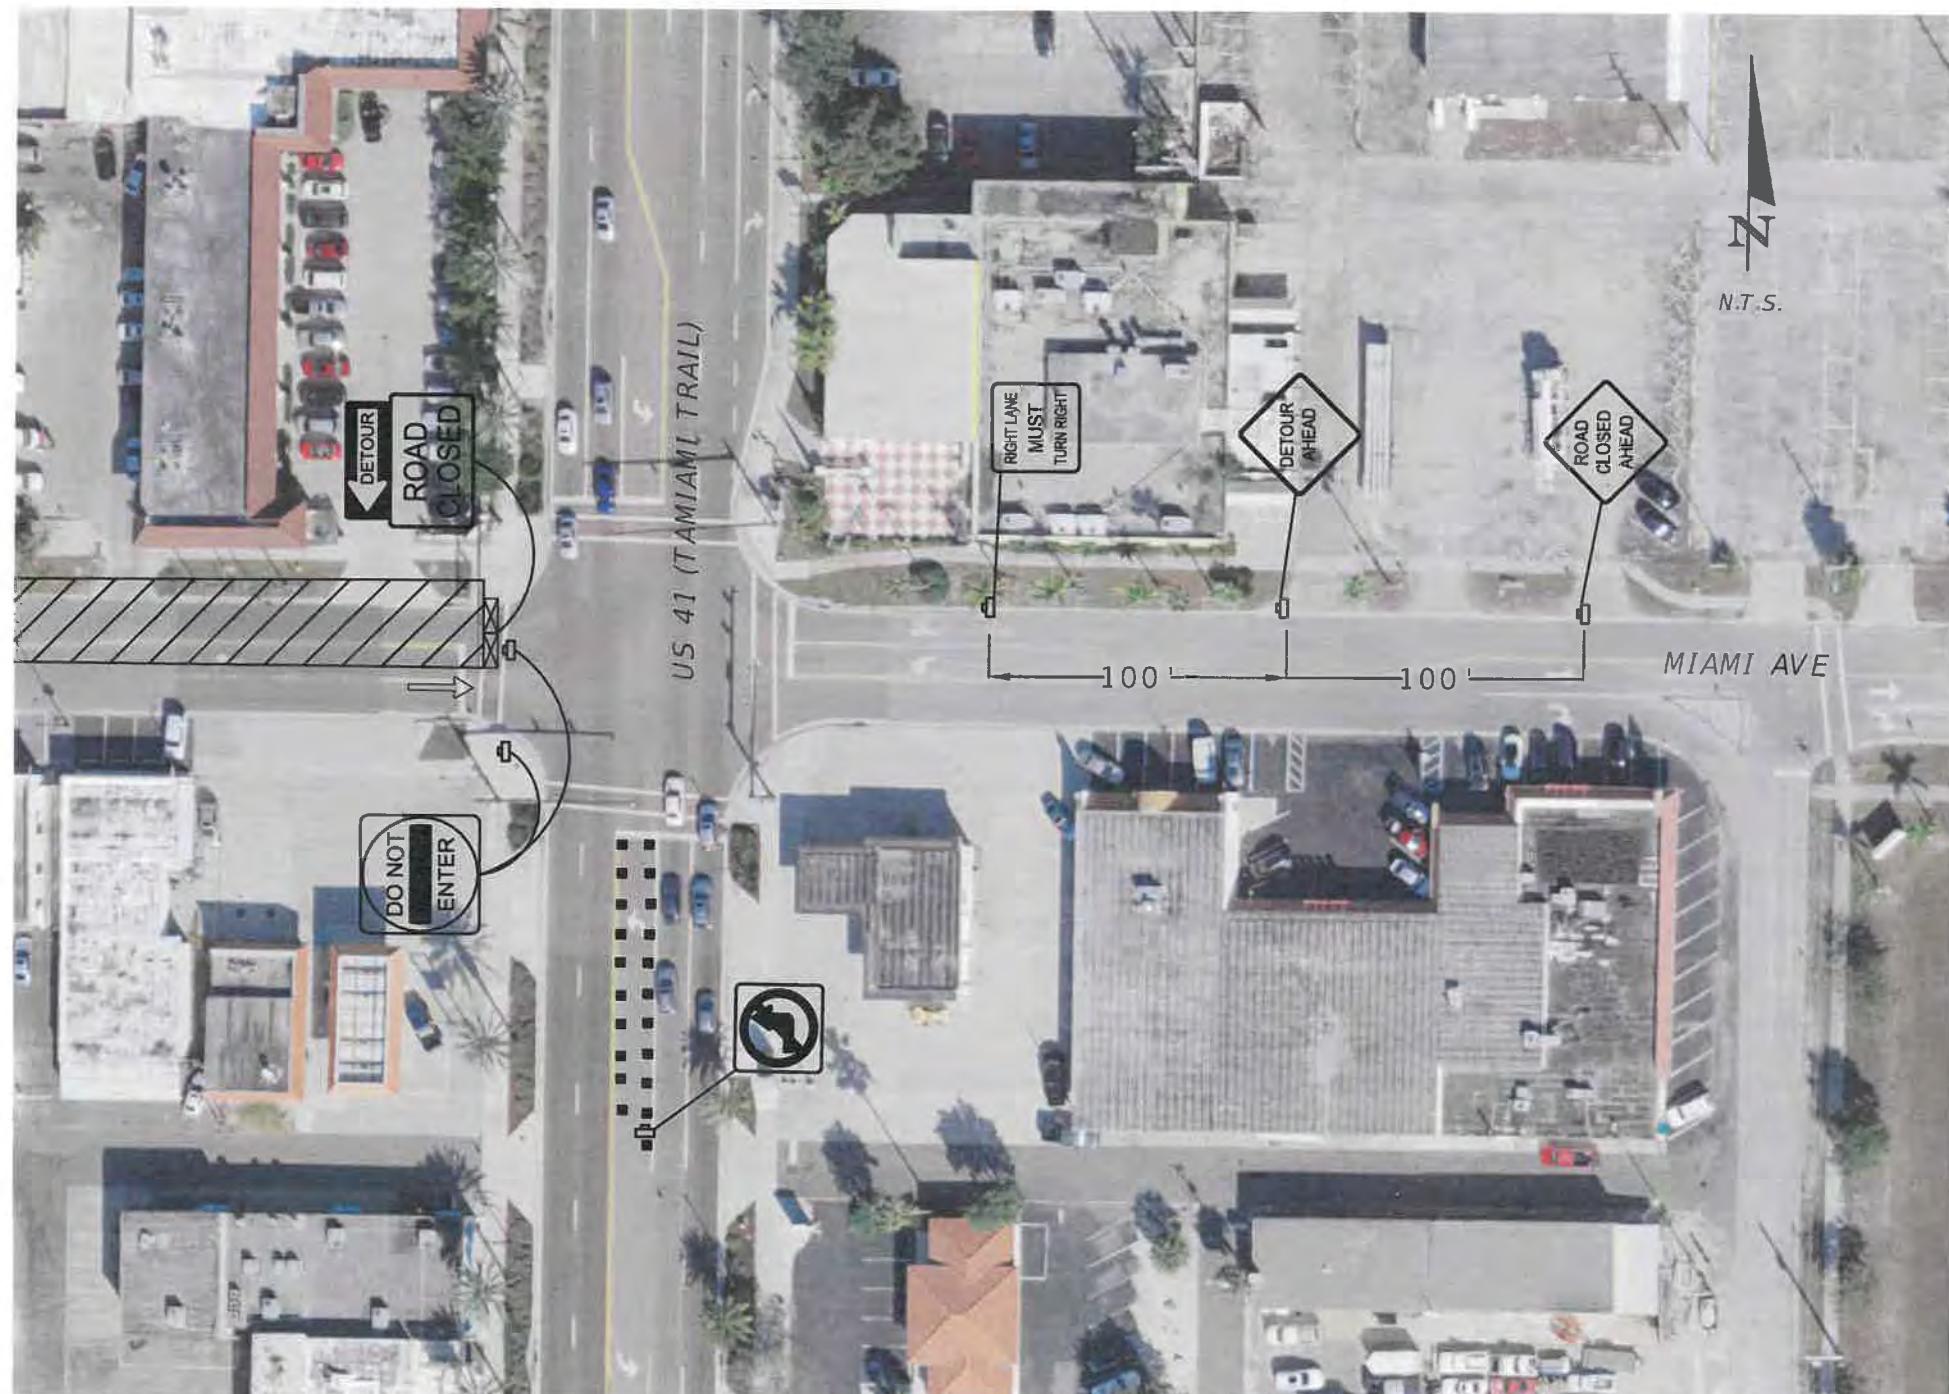

TTCP - PHASE II  
DETAIL 4

*John Salatino*  
JOHN A. SALATINO  
LICENSING NO. 60921  
3/2/18  
STATE OF FLORIDA  
PROFESSIONAL ENGINEER

				PREPARED FOR: <b>Venice, FL</b> City on the Gulf	PREPARED BY: <b>ATKINS</b>	PROJECT: CITY OF VENICE DOWNTOWN ROADWAY CORRIDOR IMPROVEMENTS	DESCRIPTION: TTCP Miami Ave. - East Leg Detail	APPROVED BY: JOHN SALATINO, P.E. P.E. LICENSE NUMBER 60921 ATKINS NORTH AMERICA (CERT. OF AUTH. NO. 24) 4030 WEST BOY SCOUT BOULEVARD, SUITE 700 TAMPA, FL 33607-1712	DATE: 2/28/2018 PROJECT NO.: 100054389 SHEET: 92
REV. Page 981	DESCRIPTION			DESIGNED MLM DRAWN MA CHECKED MLM					



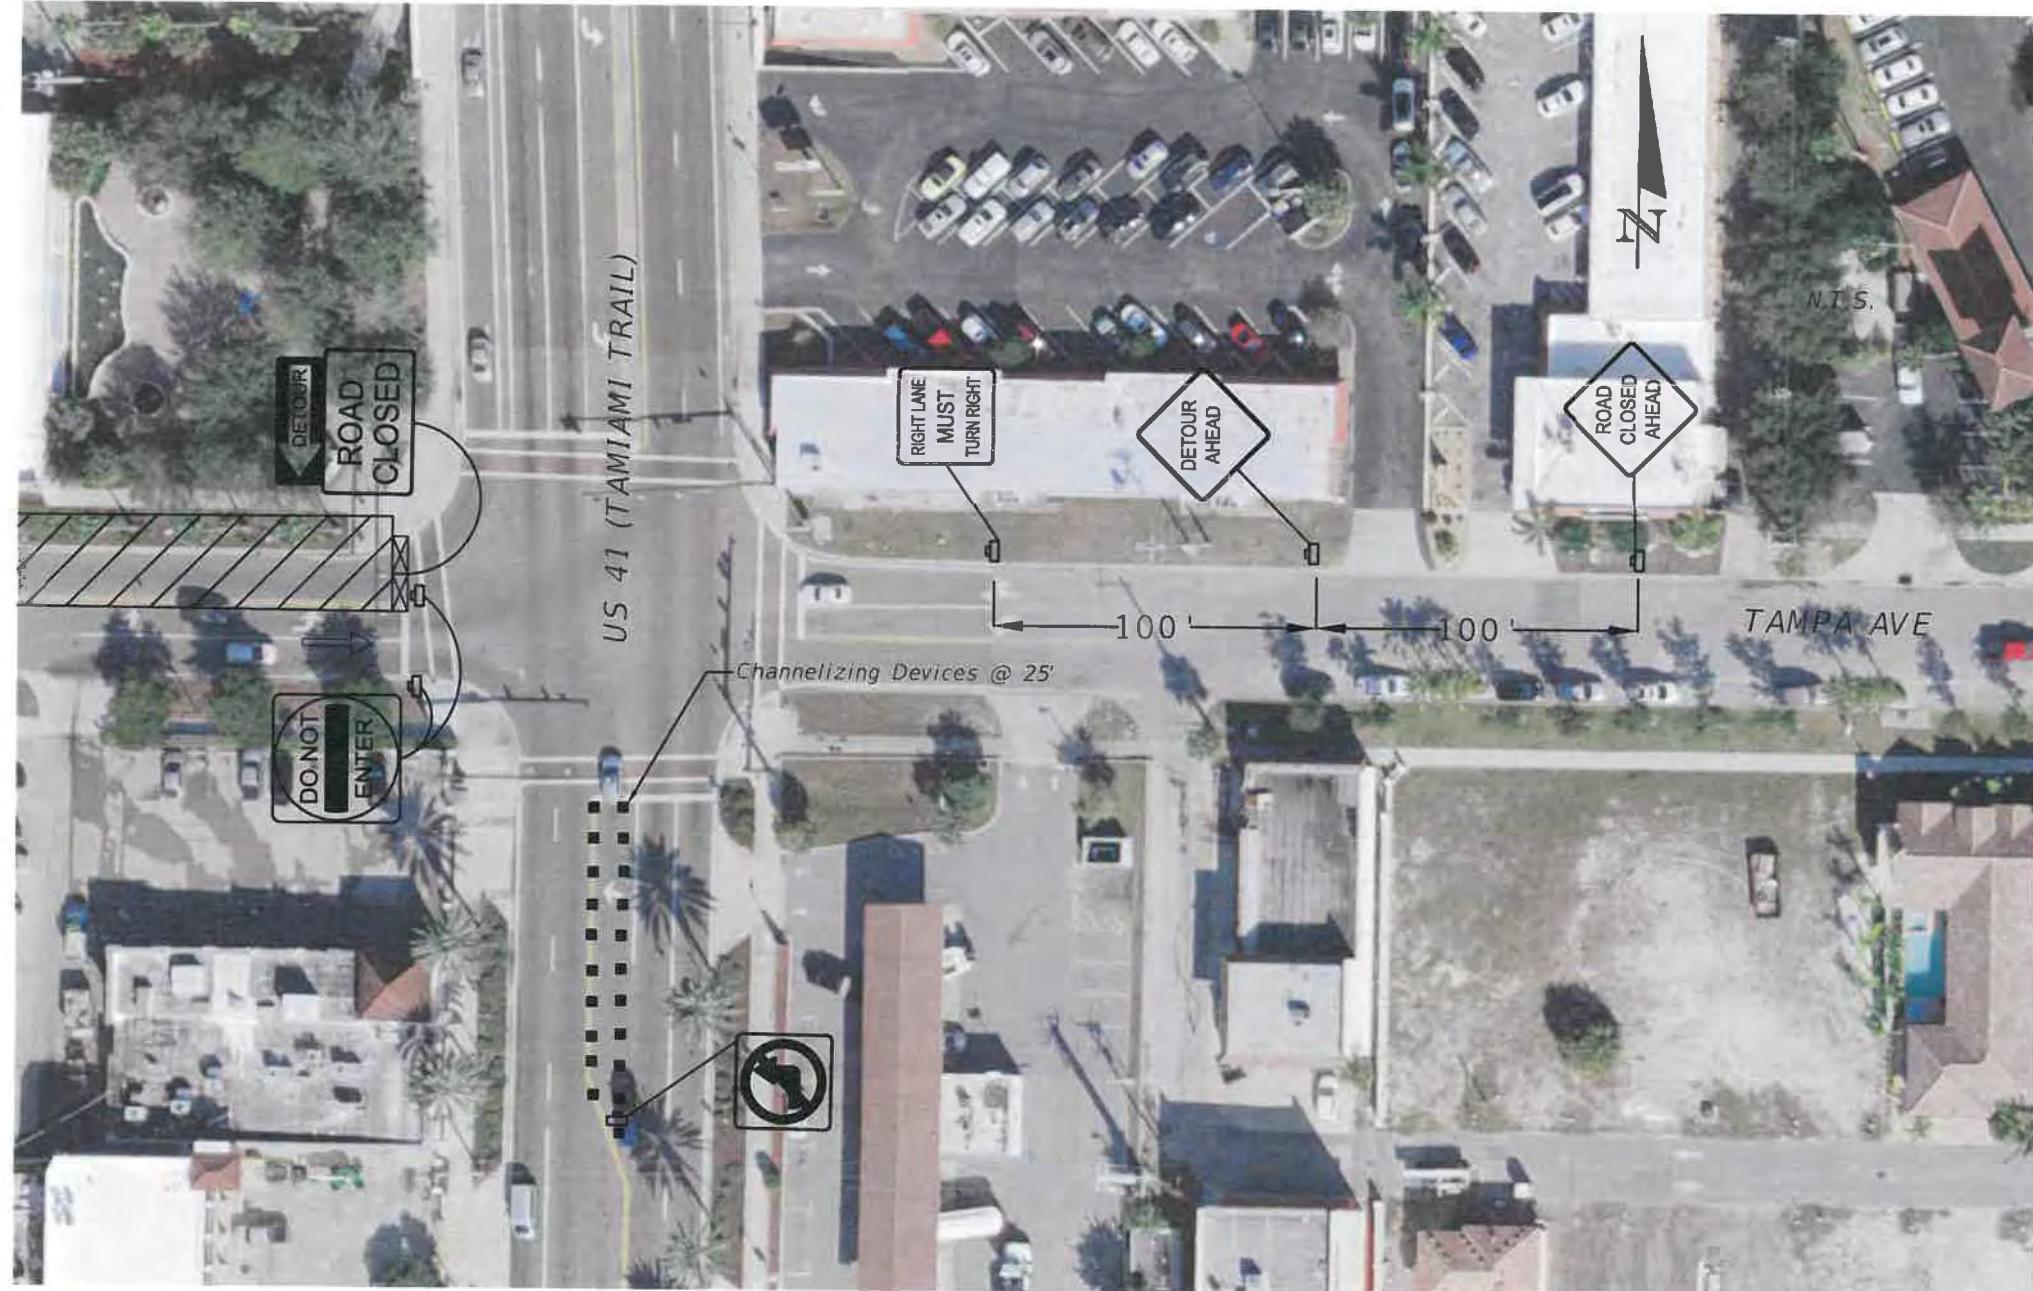


TTCP - PHASE III  
DETAIL 3





			PREPARED FOR:	PREPARED BY:	PROJECT:	DESCRIPTION:	APPROVED BY:	DATE:
			DESIGNED MLM	Venice, FL City on the Gulf	ATKINS	CITY OF VENICE DOWNTOWN ROADWAY CORRIDOR IMPROVEMENTS	TTCP Tampa Ave. - East Leg Detail	JOHN SALATINO, P.E. P.E. LICENSE NUMBER 60921 ATKINS NORTH AMERICA (CERT. OF AUTH. NO. 24) 4030 WEST BOY SCOUT BOULEVARD, SUITE 700 TAMPA, FL 33607-1712
REV. NO.	Page 982 of 1140	DESCRIPTION	DRAWN MA					2/28/2018
			CHECKED MLM					PROJECT NO.: 100054389 SHEET: 93

OWNER'S REQUIREMENTS		CONTRACTOR'S REQUIREMENTS					
SITE DESCRIPTION	SEQUENCE OF MAJOR ACTIVITIES:	SPILL PREVENTION			SPILL CONTROL PRACTICES		
<p><b>PROJECT NAME AND LOCATION:</b> DOWNTOWN VENICE ROADWAY CORRIDOR IMPROVEMENTS, VENICE, FLORIDA</p> <p>SEE NPDES NOTICE OF INTENT TO USE GENERIC PERMIT</p> <p><b>OWNER NAME AND ADDRESS:</b> CITY OF VENICE 401 W. VENICE AVENUE VENICE, FLORIDA 34285</p> <p>SEE NPDES NOTICE OF INTENT TO USE GENERIC PERMIT</p> <p><b>DESCRIPTION:</b></p> <p>THIS PROJECT WILL CONSIST OF:</p> <p>RESTRUCTURING OR MILLING AND RESURFACING THE NETWORK OF EXISTING STREETS, SIDEWALKS, AND LANDSCAPING WITHIN THE PROJECT LIMITS IN DOWNTOWN VENICE WITH NO ANTICIPATED INCREASE IN IMPERVIOUS AREA. THE RECONSTRUCTION WILL BE ACCOMPANIED BY SIGNIFICANT CLOSED COLLECTION AND CONVEYANCE SYSTEM UPDATES TO ALLEVIATE FLOODING AND IMPROVE LEVEL OF SERVICE.</p> <p>SOIL DISTURBING ACTIVITIES WILL INCLUDE: INSTALLING A PERIMETER, AND OTHER EROSION AND SEDIMENT CONTROLS; GRADING, PAVEMENT CUTTING FOR PIPE/CULVERT REPLACEMENTS; AND RECONSTRUCTION OF LANDSCAPE AREAS WITHIN THE CORRIDOR.</p> <p>RUNOFF COEFFICIENT : VARIES</p> <p>SEE NPDES NOTICE OF INTENT TO USE GENERIC PERMIT</p> <p>SOILS:</p> <p>SEE NPDES NOTICE OF INTENT TO USE GENERIC PERMIT</p> <p>SITE MAPS:</p> <p>* SEE CONSTRUCTION PLANS AND DRAINAGE REPORT</p> <p>GRADES, AREAS OF SOILS, DISTURBANCE, LOCATION OF SURFACE WATERS, WETLANDS, PROTECTED AREAS, MAJOR STRUCTURAL AND NONSTRUCTURAL CONTROLS AND STORM WATER DISCHARGE POINTS.</p> <p>* SEE CONSTRUCTION PLANS FOR LOCATION OF TEMPORARY STABILIZATION PRACTICES, AND TURBIDITY BARRIERS</p> <p>SITE AREA:</p> <p>1. TOTAL AREA OF SITE = 12.7 Acres 2. TOTAL AREA TO BE DISTURBED = 9.7 Acres</p> <p>SEE NPDES NOTICE OF INTENT TO USE GENERIC PERMIT</p> <p>(1) A DRAINAGE REPORT MAY BE OBTAINED FROM ATKINS (SEE TITLE BLOCK FOR ADDRESS)</p>	<p>THE ORDER OF ACTIVITIES WILL BE AS FOLLOWS:</p> <ol style="list-style-type: none"> <li>1. INSTALL SILT FENCES TURBIDITY BARRIERS, AND INLET PROTECTION AS REQUIRED</li> <li>2. PERFORM PRELIMINARY GRADING ON SITE AS REQUIRED</li> <li>3. STABILIZE DENUDED AREAS AND STOCKPILES AS SOON AS PRACTICAL</li> <li>4. INSTALL PIPING, CULVERTS, CURBS &amp; GUTTERS</li> <li>5. COMPLETE GRADING AND INSTALL PERMANENT SEEDING/SOD AND PLANTING</li> <li>6. COMPLETE FINAL PAVING</li> <li>7. REMOVE ACCUMULATED SEDIMENT FROM BASINS</li> <li>8. WHEN ALL CONSTRUCTION ACTIVITY IS COMPLETE AND THE SITE IS STABILIZED, REMOVE ANY TEMPORARY DIVERSION SWALES/DIKES AND RESEED/SOD AS REQUIRED</li> </ol>	<p>9. TEMPORARY GRASSING: THE SEDED OR SEEDED AND MULCHED AREA (SI) SHALL BE ROLLED AND WATERED OR HYDROMULCHED OR OTHER SUITABLE METHODS IF REQUIRED TO ASSURE OPTIMUM GROWING CONDITIONS FOR THE ESTABLISHMENT OF A GOOD GRASS COVER.</p> <p>10. TEMPORARY REGRASSING: IF, AFTER 14 DAYS FROM SEEDING, THE TEMPORARY GRASSED AREAS HAVE NOT ATTAINED A MINIMUM OF 75 PERCENT GOOD GRASS COVER, THE AREA WILL BE REWORKED AND ADDITIONAL SEED APPLIED SUFFICIENT TO ESTABLISH THE DESRED VEGETATIVE COVER.</p> <p>11. MAINTENANCE: ALL FEATURES OF THE PROJECT DESIGNED AND CONSTRUCTED TO PREVENT EROSION AND SEDIMENT SHALL BE MAINTAINED DURING THE LIFE OF THE CONSTRUCTION SO AS TO FUNCTION AS THEY WERE ORIGINALLY DESIGNED AND CONSTRUCTED.</p> <p>12. PERMANENT EROSION CONTROL: THE EROSION CONTROL FACILITIES OF THE PROJECT SHOULD BE DESIGNED TO MINIMIZE THE IMPACT ON THE OFFSITE FACILITIES.</p> <p>13. PERMANENT SEEDING: ALL AREAS WHICH HAVE BEEN DISTURBED BY CONSTRUCTION WILL, AT MINIMUM, BE SEDED. THE SEEDING MIX MUST PROVIDE BOTH LONG-TERM VEGETATION AND RAPID GROWTH SEASONAL VEGETATION. SLOPES STEEPER THAN 4:1 SHALL BE SEDED AND MULCHED OR SODDED.</p>	<p>MATERIAL MANAGEMENT PRACTICES</p> <p>THE FOLLOWING ARE THE MATERIAL MANAGEMENT PRACTICES THAT WILL BE USED TO REDUCE THE RISK OF SPILLS OR OTHER ACCIDENTAL EXPOSURE OF MATERIALS AND SUBSTANCES TO STORMWATER RUNOFF.</p> <p>GOOD HOUSEKEEPING</p> <p>THE FOLLOWING GOOD HOUSEKEEPING PRACTICES WILL BE FOLLOWED ONSITE DURING THE CONSTRUCTION PROJECT.</p> <ul style="list-style-type: none"> <li>* AN EFFORT WILL BE MADE TO STORE ONLY ENOUGH PRODUCT REQUIRED TO DO THE JOB.</li> <li>* ALL MATERIALS STORED ONSITE WILL BE STORED IN A NEAT, ORDERLY MANNER IN THEIR APPROPRIATE CONTAINERS AND, IF POSSIBLE, UNDER A ROOF OR OTHER ENCLOSURE.</li> <li>* PRODUCTS WILL BE KEPT IN THEIR ORIGINAL CONTAINERS WITH THE ORIGINAL MANUFACTURER'S LABEL.</li> <li>* SUBSTANCES WILL NOT BE MIXED WITH ONE ANOTHER UNLESS RECOMMENDED BY THE MANUFACTURER.</li> <li>* WHENEVER POSSIBLE, ALL OF A PRODUCT WILL BE USED UP BEFORE DISPOSING OF THE CONTAINER.</li> <li>* MANUFACTURER'S RECOMMENDATIONS FOR PROPER USE AND DISPOSAL WILL BE FOLLOWED.</li> <li>* THE SITE SUPERINTENDENT WILL INSPECT DAILY TO ENSURE MATERIALS ONSITE RECEIVE PROPER USE AND DISPOSAL.</li> </ul>	<p>EROSION AND SEDIMENT CONTROL INSPECTION AND MAINTENANCE PRACTICES</p> <p>THE FOLLOWING ARE INSPECTION AND MAINTENANCE PRACTICES THAT WILL BE USED TO MAINTAIN EROSION AND SEDIMENT CONTROLS.</p> <ul style="list-style-type: none"> <li>* NO MORE THAN 10 ACRES OF THE SITE WILL BE DENUDED AT ONE TIME WITHOUT WRITTEN PERMISSION FROM THE ENGINEER.</li> <li>* ALL CONTROL MEASURES WILL BE INSPECTED BY THE SUPERINTENDENT, THE PERSON RESPONSIBLE FOR THE DAY TO DAY SITE OPERATION OR SOMEONE APPOINTED BY THE SUPERINTENDENT, AT LEAST ONCE A WEEK AND FOLLOWING ANY STORM EVENT OF 0.25 INCHES OR GREATER.</li> <li>* ALL TURBIDITY CONTROL MEASURES WILL BE MAINTAINED IN GOOD WORKING ORDER; IF REPAIR IS NECESSARY, IT WILL BE INITIATED WITHIN 24 HOURS OF REPORT.</li> <li>* BUILT UP SEDIMENT WILL BE REMOVED FROM SILT FENCE WHEN IT HAS REACHED ONE-THIRD THE HEIGHT OF THE FENCE.</li> <li>* SILT FENCE WILL BE INSPECTED FOR DEPTH OF SEDIMENT, TEARS, TO SEE THAT THE FENCE POSTS ARE FIRMLY IN THE GROUND.</li> <li>* THE SEDIMENT BASINS WILL BE INSPECTED FOR THE DEPTH OF SEDIMENT, AND BUILD UP SEDIMENT WILL BE REMOVED WHEN IT REACHES 10 PERCENT OF THE SEEDING CAPACITY OR AT THE END OF THE JOB.</li> <li>* DIVERSION DIKES/SWALES WILL BE INSPECTED AND ANY BREACHES PROMPTLY REPAIRED.</li> <li>* TEMPORARY AND PERMANENT SEEDING AND PLANTING WILL BE INSPECTED FOR BARE SPOTS, WASHOUTS, AND HEALTHY GROWTH.</li> <li>* A MAINTENANCE INSPECTION REPORT WILL BE MADE AFTER EACH INSPECTION. A COPY OF THE REPORT FORM TO BE COMPLETED BY THE INSPECTOR IS ATTACHED. THE REPORTS WILL BE KEPT ON SITE DURING CONSTRUCTION AND AVAILABLE UPON REQUEST TO THE OWNER, ENGINEER OR ANY FEDERAL, STATE OR LOCAL AGENCY APPROVING SEDIMENT AND EROSION PLANS, OR STORMWATER MANAGEMENT PLANS. THE REPORTS SHALL BE MADE AND RETAINED AS PART OF THE STORMWATER POLLUTION PREVENTION PLAN FOR AT LEAST THREE YEARS FROM THE DATE THAT THE SITE IS FINALLY STABILIZED AND THE NOTICE OF TERMINATION IS SUBMITTED. THE REPORTS SHALL IDENTIFY AND INCIDENTS OF NON-COMPLIANCE.</li> <li>* THE SITE SUPERINTENDENT WILL SELECT UP TO THREE INDIVIDUALS WHO WILL BE RESPONSIBLE FOR INSPECTIONS, MAINTENANCE AND REPAIR ACTIVITIES, AND FILLING OUT THE INSPECTION AND MAINTENANCE REPORT.</li> </ul>			
<p>TIMING OF CONTROLS/MEASURES</p> <p>AS INDICATED IN THE SEQUENCE OF MAJOR ACTIVITIES, THE SILT FENCES, SYNTHETIC HAY BALES, AND TURBIDITY BARRIERS WILL BE CONSTRUCTED PRIOR TO CLEARING OR GRADING OF ANY OTHER PORTIONS OF THE SITE. STABILIZATION MEASURES SHALL BE INITIATED AS SOON AS PRACTICAL IN PORTIONS OF THE SITE WHERE CONSTRUCTION ACTIVITIES HAVE TEMPORARILY OR PERMANENTLY CEASED. ONCE CONSTRUCTION ACTIVITY CEASES PERMANENTLY IN AN AREA, THAT AREA WILL BE STABILIZED PERMANENTLY IN ACCORDANCE WITH THE PLANS. AFTER THE ENTIRE SITE IS STABILIZED, THE ACCUMULATED SEDIMENT WILL BE REMOVED FROM THE SEDIMENT TRAPS AND THE EARTH DIKE/SWALES WILL BE REGRADED/REMOVED AND STABILIZED IN ACCORDANCE WITH THE SEDIMENT AND EROSION CONTROL PLAN.</p>	<p>STRUCTURAL PRACTICES</p> <ol style="list-style-type: none"> <li>1. TEMPORARY DIVERSION DIKE: TEMPORARY DIVERSION DIKES MAY BE USED TO DIVERT RUNOFF THROUGH A SEDIMENT-TRAPPING FACILITY.</li> <li>2. TEMPORARY SEDIMENT TRAP: A SEDIMENT TRAP IS USUALLY INSTALLED IN A DRAINAGE WAY AT A STORM DRAIN INLET OR AT OTHER POINTS OF DISCHARGE FROM A DISTURBED AREA WITH THE FOLLOWING LIMITATIONS:             <ol style="list-style-type: none"> <li>A. THE SEDIMENT TRAP MAY BE CONSTRUCTED EITHER INDEPENDENTLY OR IN CONJUNCTION WITH A TEMPORARY DIVERSION DIKE.</li> </ol> </li> <li>3. OUTLET PROTECTION: APPLICABLE TO THE OUTLETS OF ALL PIPES AND PAVED CHANNEL SECTION WHERE THE VELOCITY OF FLOW AT DESIGN CAPACITY OF THE OUTLET WILL EXCEED THE PERMISSIBLE VELOCITY OF THE RECEIVING CHANNEL OR AREA.</li> <li>4. ALL SEDIMENT COLLECTED IN TEMPORARY SEDIMENT TRAPS MUST BE REMOVED UPON FINAL STABILIZATION.</li> </ol>	<p>HAZARDOUS PRODUCTS</p> <p>THESE PRACTICES ARE USED TO REDUCE THE RISKS ASSOCIATED WITH HAZARDOUS MATERIALS.</p> <ul style="list-style-type: none"> <li>* PRODUCTS WILL BE KEPT IN ORIGINAL CONTAINERS UNLESS THEY ARE NOT RESEALABLE.</li> <li>* ORIGINAL LABELS AND MATERIAL SAFETY DATA SHEET WILL BE RETAINED; THEY CONTAIN IMPORTANT PRODUCT INFORMATION.</li> <li>* IF SURPLUS PRODUCT MUST BE DISPOSED OF, MANUFACTURER'S OR LOCAL AND/OR STATE RECOMMENDED METHOD FOR PROPER DISPOSAL WILL BE FOLLOWED.</li> </ul>	<p>PRODUCT SPECIFIC PRACTICES</p> <p>THE FOLLOWING PRODUCT SPECIFIC PRACTICES WILL BE FOLLOWED ONSITE:</p> <p>PETROLEUM PRODUCTS</p> <p>ALL ONSITE VEHICLES WILL BE MONITORED FOR LEAKS AND RECEIVE REGULAR PREVENTIVE MAINTENANCE TO REDUCE THE CHANCE OF LEAKAGE. PETROLEUM PRODUCTS WILL BE STORED IN TIGHTLY SEALED CONTAINERS WHICH ARE CLEARLY LABELED. ANY ASPHALT SUBSTANCES USED ONSITE WILL BE APPLIED ACCORDING TO THE MANUFACTURER'S RECOMMENDATIONS.</p>				
<p>CONTROLS</p> <p>IT IS THE CONTRACTOR'S RESPONSIBILITY TO IMPLEMENT THE EROSION AND TURBIDITY CONTROLS AS SHOWN IN THE SEDIMENT AND EROSION CONTROL PLAN. IT IS ALSO THE CONTRACTOR'S RESPONSIBILITY TO ENSURE THESE CONTROLS ARE PROPERLY INSTALLED, MAINTAINED AND FUNCTIONING PROPERLY TO PREVENT TURBID OR POLLUTED WATER FROM LEAVING THE PROJECT SITE. THE CONTRACTOR WILL ADJUST THE EROSION AND TURBIDITY CONTROLS SHOWN ON THE SEDIMENT AND EROSION CONTROL PLAN AND ADD ADDITIONAL CONTROL MEASURES, AS REQUIRED TO ENSURE THE SITE MEETS ALL FEDERAL, STATE AND LOCAL EROSION AND TURBIDITY CONTROL REQUIREMENTS IMPOSED ON THE PROJECT SITE BY THE REGULATORY AGENCIES.</p>	<p>EROSION AND SEDIMENT CONTROLS</p> <p>STABILIZATION PRACTICES</p> <ol style="list-style-type: none"> <li>1. FILTER FABRIC BARRIER: FILTER FABRIC BARRIERS CAN BE USED BELOW DISTURBED AREAS SUBJECT TO SHEET AND RILL EROSION WITH THE FOLLOWING LIMITATIONS:             <ol style="list-style-type: none"> <li>A. WHERE THE MAXIMUM SLOPE BEHIND THE BARRIER IS 33 PERCENT. IN MINOR SWALES OR DITCH LINES WHERE THE MAXIMUM CONTRIBUTING B. DRAINAGE AREA IS NO GREATER THAN 2 ACRES.</li> </ol> </li> <li>2. BRUSH BARRIER WITH FILTER FABRIC: BRUSH BARRIER MAY BE USED BELOW DISTURBED AREAS SUBJECT TO SHEET AND RILL EROSION WHERE ENOUGH RESIDUE MATERIAL IS AVAILABLE ON SITE.</li> <li>3. LEVEL SPREADER: A LEVEL SPREADER MAY BE USED WHERE SEDIMENT-FREE STORM RUNOFF IS INTERCEPTED AND DIVERTED AWAY FROM THE GRADED AREAS INTO UNDISTURBED STABILIZED AREAS. THIS PRACTICE APPLIES ONLY IN THOSE SITUATIONS WHERE THE SPREADER CAN BE CONSTRUCTED ON UNDISTURBED SOIL AND THE AREA BELOW THE LEVEL RECONCENTRATE AFTER RELEASE.</li> <li>4. STOCKPILING MATERIAL: NO EXCAVATED MATERIAL SHALL BE STOCKPILED IN SUCH A MANNER AS TO DIRECT RUNOFF DIRECTLY OFF THE PROJECT SITE INTO ANY ADJACENT WATER BODY OR STORM WATER COLLECTION FACILITY.</li> </ol>	<p>OTHER CONTROLS</p> <p>WASTE DISPOSAL</p> <p>WASTE MATERIALS</p> <p>ALL WASTE MATERIALS EXCEPT LAND CLEARING DEBRIS SHALL BE COLLECTED AND STORED IN A SECURELY LIODED METAL DUMPSTER. THE DUMPSTER WILL MEET ALL LOCAL AND STATE SOLID WASTE MANAGEMENT REGULATIONS. THE DUMPSTER WILL BE EMPTIED AS NEEDED AND THE TRASH WILL BE HAULED TO A STATE APPROVED LANDFILL. ALL PERSONNEL WILL BE INSTRUCTED REGARDING THE CORRECT PROCEDURE FOR WASTE DISPOSAL. NOTICES STATING THESE PRACTICES WILL BE POSTED AT THE CONSTRUCTION SITE BY THE CONSTRUCTION SUPERINTENDENT. THE INDIVIDUAL WHO MANAGES THE DAY-TO-DAY SITE OPERATIONS WILL BE RESPONSIBLE FOR SEEING THAT THESE PROCEDURES ARE FOLLOWED.</p>	<p>FERTILIZERS</p> <p>SEE LANDSCAPE SPECIFICATIONS.</p> <p>PAINTS</p> <p>ALL CONTAINERS WILL BE TIGHTLY SEALED AND STORED WHEN NOT REQUIRED FOR USE. EXCESS PAINT WILL NOT BE DISCHARGED TO THE STORM SEWER SYSTEM BUT WILL BE PROPERLY DISPOSED OF ACCORDING TO MANUFACTURER'S INSTRUCTIONS OR STATE AND LOCAL REGULATIONS.</p>				
<p>TIMING OF CONTROL MEASURES</p> <p>REFER TO "CONTRACTOR'S REQUIREMENTS" FOR THE TIMING OF CONTROL/MEASURES.</p>	<p>HAZARDOUS WASTE</p> <p>ALL HAZARDOUS WASTE MATERIALS WILL BE DISPOSED OF IN THE MANNER SPECIFIED BY LOCAL OR STATE REGULATION OR BY THE MANUFACTURER. SITE PERSONNEL WILL BE INSTRUCTED IN THESE PRACTICES BY THE SITE SUPERINTENDENT. THE INDIVIDUAL WHO MANAGES DAY-TO-DAY SITE OPERATIONS WILL BE RESPONSIBLE FOR SEEING THAT THESE PRACTICES ARE FOLLOWED.</p>	<p>CONCRETE TRUCKS</p> <p>CONCRETE TRUCKS WILL NOT BE ALLOWED TO WASH OUT OR DISCHARGE SURPLUS CONCRETE OR DRUM WASH WATER ON THE SITE.</p>	<p>NON-STORM WATER DISCHARGES</p> <p>IT IS EXPECTED THAT THE FOLLOWING NON-STORM WATER DISCHARGES WILL OCCUR FROM THE SITE DURING THE CONSTRUCTION PERIOD:</p> <ul style="list-style-type: none"> <li>* WATER FROM WATER LINE FLUSHING.</li> <li>* PAVEMENT WASH WATERS (WHERE NO SPILLS OR LEAKS OF TOXIC OR HAZARDOUS MATERIALS HAVE OCCURRED).</li> <li>* UNCONTAMINATED GROUNDWATER (FROM DEWATERING EXCAVATION).</li> </ul> <p>ALL NON-STORM WATER DISCHARGES WILL BE DIRECTED TO A TEMPORARY SEDIMENT TRAP PRIOR TO DISCHARGE.</p>				
<p>CERTIFICATION OF COMPLIANCE WITH FEDERAL, STATE AND LOCAL REGULATIONS</p> <p>IN AN EFFORT TO ENSURE COMPLIANCE WITH FEDERAL, STATE AND LOCAL LAWS REGARDING EROSION AND TURBIDITY CONTROLS, THE FOLLOWING PERMITS HAVE BEEN OBTAINED.</p> <p>FDOT DRAINAGE CONNECTION PERMIT ACOE DREDGE/FILL PERMIT SWFWMD ERP PERMIT</p>	<p>GENERAL</p> <p>THE CONTRACTOR SHALL AT A MINIMUM IMPLEMENT THE CONTRACTOR'S REQUIREMENT OUTLINED IN THIS NARRATIVE AND THOSE MEASURES SHOWN ON THE EROSION AND TURBIDITY CONTROL PLAN. IN ADDITION, THE CONTRACTOR SHALL UNDERTAKE ADDITIONAL MEASURES REQUIRED TO BE IN COMPLIANCE WITH APPLICABLE PERMIT CONDITIONS AND STATE WATER QUALITY STANDARDS.</p>	<p>SANITARY WASTE</p> <p>ALL SANITARY WASTE WILL BE COLLECTED FROM THE PORTABLE UNITS AS NEEDED TO PREVENT POSSIBLE SPILLAGE. THE WASTE WILL BE COLLECTED AND DISPOSED OF IN ACCORDANCE WITH STATE AND LOCAL WASTE DISPOSAL REGULATIONS FOR SANITARY SEWER OR SEPTIC SYSTEMS.</p> <p>ALL SPILLS WILL BE CLEANED UP IMMEDIATELY AFTER DISCOVERY.</p> <p>THE SPILL AREA WILL BE KEPT WELL VENTILATED AND PERSONNEL WILL WEAR APPROPRIATE PROTECTIVE CLOTHING TO PREVENT INJURY FROM CONTACT WITH A HAZARDOUS SUBSTANCE.</p> <p>SPILL OF TOXIC OR HAZARDOUS MATERIAL WILL BE REPORTED TO THE APPROPRIATE STATE OR LOCAL GOVERNMENT AGENCY, REGARDLESS OF THE SIZE OF THE SPILL.</p>	<p>SPILL CONTROL PRACTICES</p> <p>I CERTIFY UNDER PENALTY OF LAW THAT I UNDERSTAND THE TERMS AND CONDITIONS OF THE GENERAL NATIONAL POLLUTANT DISCHARGE ELIMINATION SYSTEM (NPDES) PERMIT THAT AUTHORIZES THE STORMWATER DISCHARGE ASSOCIATED WITH INDUSTRIAL ACTIVITY FROM THE CONSTRUCTION SITE IDENTIFIED AS PART OF THIS CERTIFICATION.</p>				
<p>STATE OF FLORIDA PROFESSIONAL ENGINEER</p>		<p>SIGNATURE</p> <p>BUSINESS NAME AND ADDRESS OF CONTRACTOR &amp; ALL SUBS</p> <p>RESPONSIBLE FOR/DUTIES</p>					
<p>PREPARED FOR:</p> <p>DESIGNED MLM</p> <p>DRAWN MA</p> <p>CHECKED MLM</p> <p>Venice, FL City on the Gulf</p>	<p>PREPARED BY:</p> <p>ATKINS</p>	<p>PROJECT:</p> <p>CITY OF VENICE DOWNTOWN ROADWAY CORRIDOR IMPROVEMENTS</p>	<p>DESCRIPTION:</p> <p>STORMWATER POLLUTION PREVENTION PLAN (SWPPP)</p>	<p>APPROVED BY:</p> <p>JOHN SALATINO, P.E. P.E. LICENSE NUMBER 60921 ATKINS NORTH AMERICA (CERT. OF AUTH. NO. 24) 4030 WEST BOY SCOUT BOULEVARD, SUITE 700 TAMPA, FL 33607-1712</p>			
REV. NO.	DATE	DESCRIPTION		DATE: 2/28/2018 PROJECT NO.: 100054389 SHEET: 94			

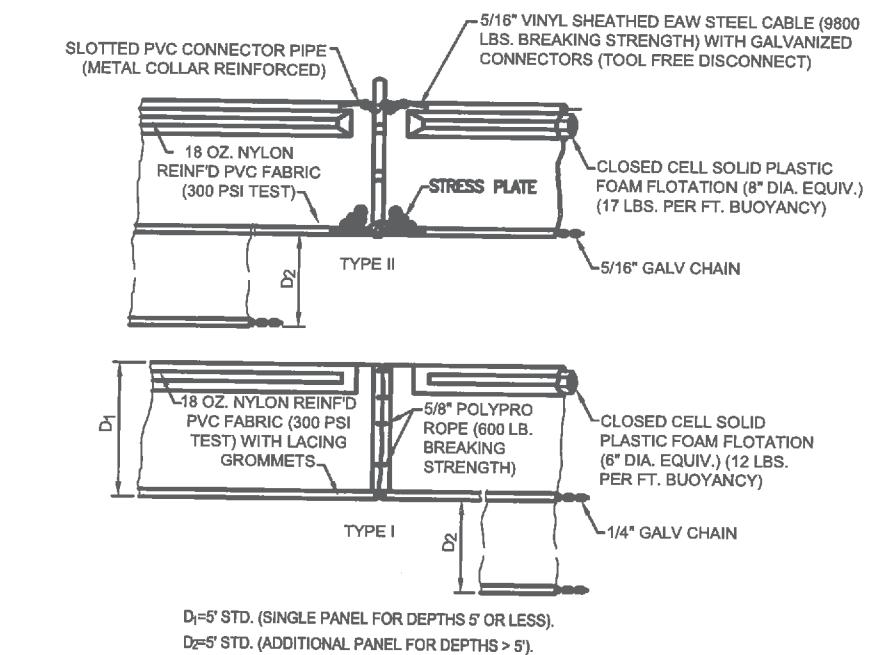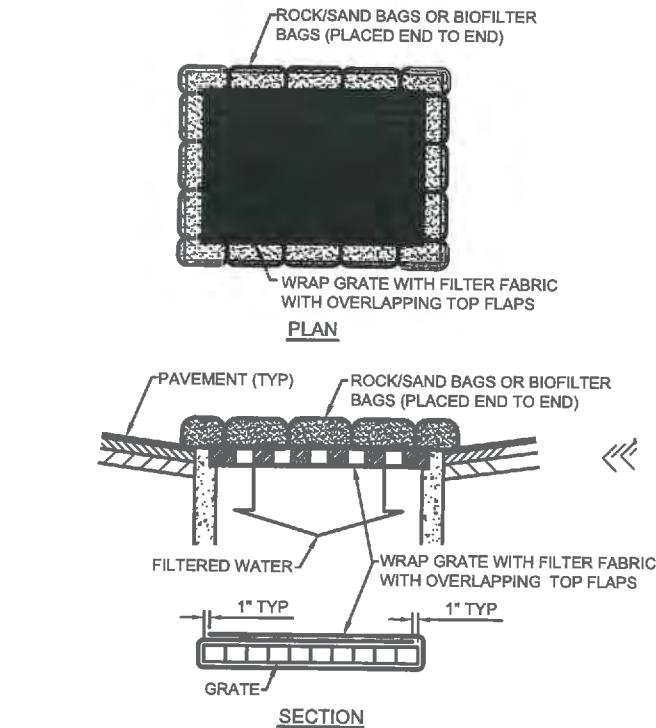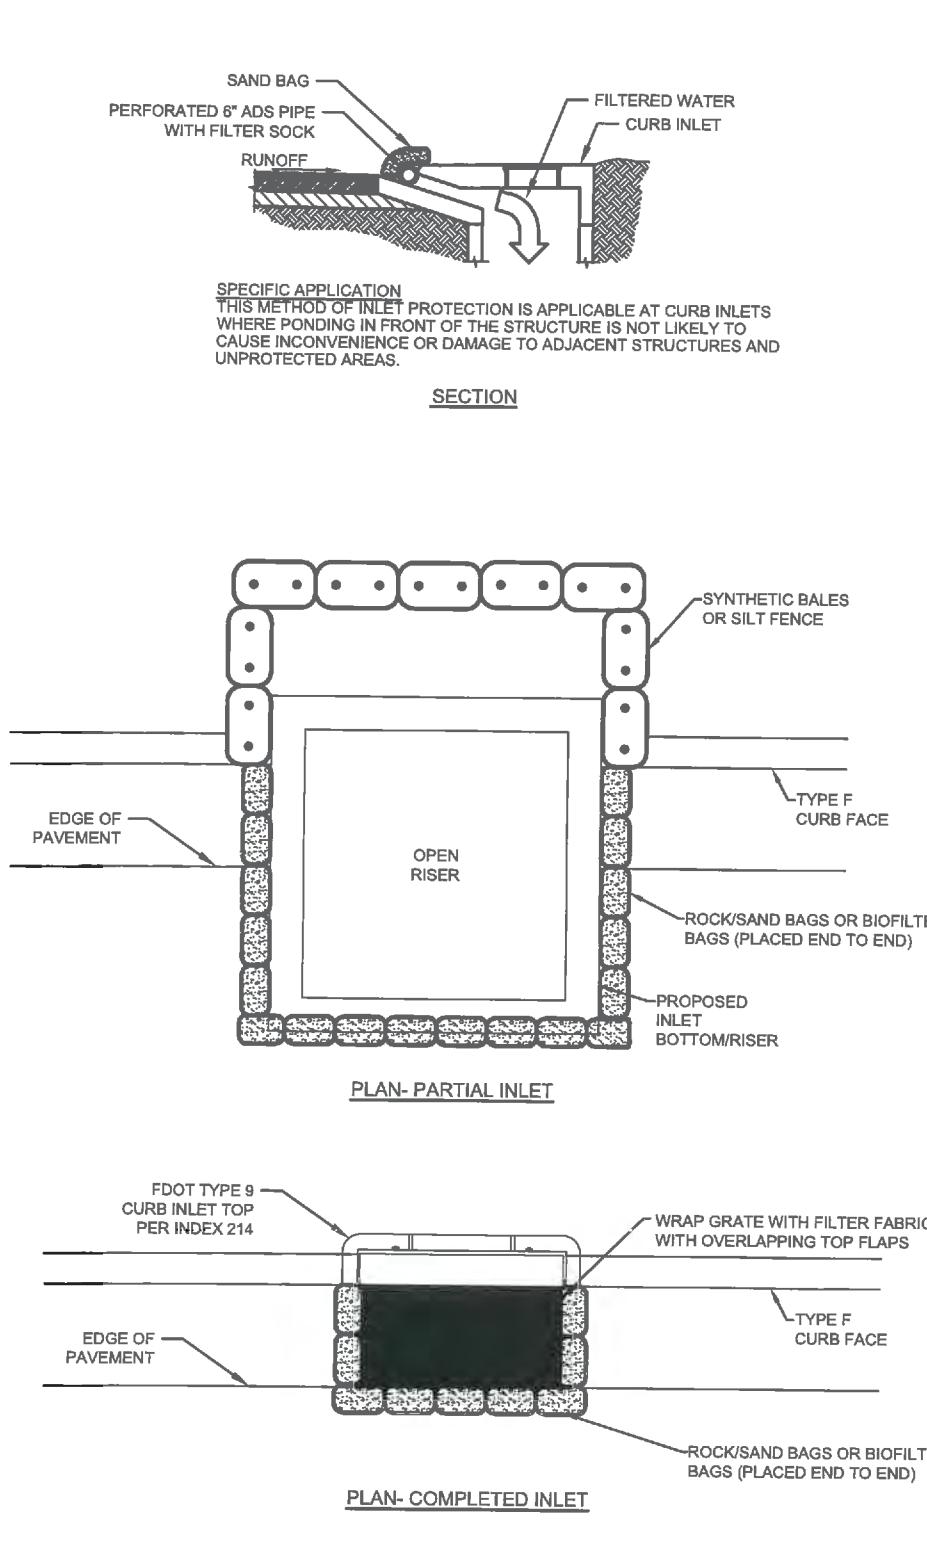

CURTAIN TO REACH BOTTOM UP TO DEPTHS OF TEN FEET. TWO(2) PANELS TO BE USED FOR DEPTHS GREATER THAN TEN FEET UNLESS SPECIAL DEPTH CURTAINS SPECIFICALLY CALLED FOR IN THE PLANS OR AS DETERMINED BY THE ENGINEER.

NOTICE: COMPONENTS OF TYPES I AND II MAY BE SIMILAR OR IDENTICAL TO PROPRIETARY DESIGNS. ANY INFRINGEMENT ON THE PROPRIETARY RIGHTS OF THE DESIGNER SHALL BE THE SOLE RESPONSIBILITY OF THE USER. SUBSTITUTIONS FOR TYPES I AND II SHALL BE AS APPROVED BY THE ENGINEER.

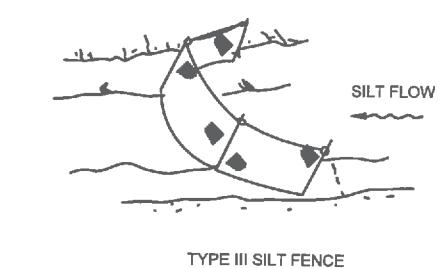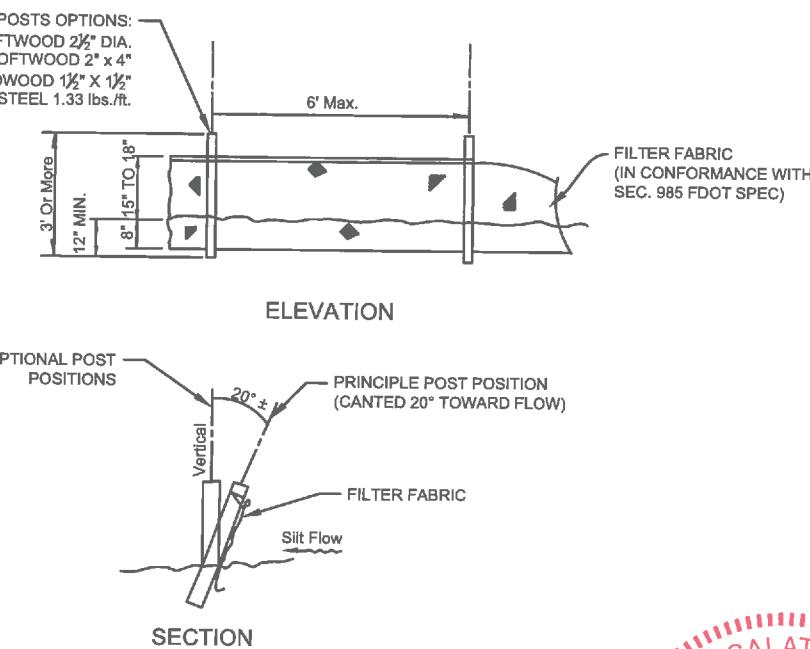

DO NOT DEPLOY IN A MANNER THAT SILT FENCES WILL ACT AS A DAM ACROSS PERMANENT FLOWING WATERCOURSES. SILT FENCES ARE TO BE USED AT UPLAND LOCATIONS AND TURBIDITY BARRIERS USED AT PERMANENT BODIES OF WATER.



PREPARED FOR:	PREPARED BY:	PROJECT:	DESCRIPTION:	APPROVED BY:	DATE:
DESIGNED MLM	ATKINS	CITY OF VENICE DOWNTOWN ROADWAY CORRIDOR IMPROVEMENTS	EROSION CONTROL DETAILS	JOHN SALATINO, P.E. P.E. LICENSE NUMBER 60921 ATKINS NORTH AMERICA (CERT. OF AUTH. NO. 24) 4030 WEST BOY SCOUT BOULEVARD, SUITE 700 TAMPA, FL 33607-1712	2/28/2018
DRAWN MA					PROJECT NO.: 100054389
CHECKED MLM					SHEET: 95