


UTILITY NOTIFICATION

UTILITY LOCATIONS DEPICTED WITHIN THIS
CONSTRUCTION PLAN SET HAVE BEEN
COMPILED FROM FIELD MEASUREMENTS AND
DOCUMENTS SUPPLIED BY THE VARIOUS UTILIT
COMPANIES. THE ENGINEER MAKES NO CLAIM
TO THE ACCURACY OF THE UTILITY LOCATIONS
SHOWN ON THESE PLANS. THE CONTRACTOR
SHALL NOTIFY ALL UTILITIES AND IS
RESPONSIBLE FOR VERIFYING THE DEPTHS ANI
FIELD LOCATIONS OF ALL EXISTING UTILITIES
PRIOR TO COMMENCEMENT OF CONSTRUCTION.
ACTUAL UTILITY LOCATIONS AND DEPTHS MAY
VARY FROM THOSE DEPICTED WITHIN THIS
CONSTRUCTION PLAN SET. PROTECTION OF
ALL UTILITIES WITHIN THE AREA OF
CONSTRUCTION AND ALL COSTS TO REMEDY
DAMAGES TO EXISTING UTILITIES AND
DISTURBED AREAS SHALL BE BORNE BY THE

# CITY OF VENICE MAJOR SITE & DEVELOPMENT AMENDMENT PLANS FOR

# 1460 E VENICE AVE. VENICE, FLORIDA

(APPROVED SITE & DEVELOPMENT PLAN AMENDMENT PETITION NO. 05-25SP)

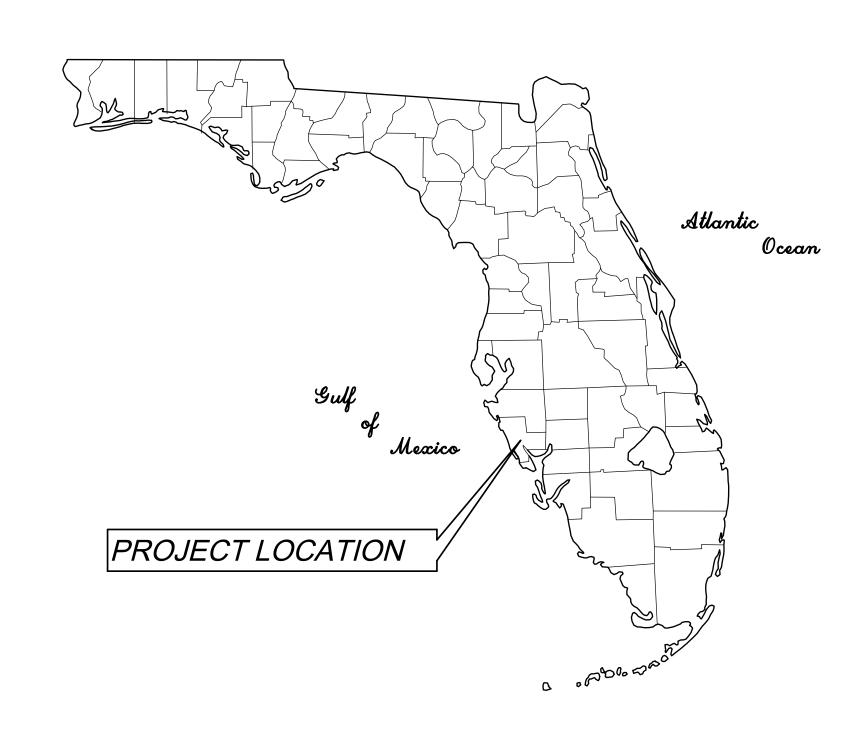


OWNER:

GALLERIA SHOPS, LLC.

1222 SW 47th STREET, SUITE 330

CAPE CORAL, FL 33094

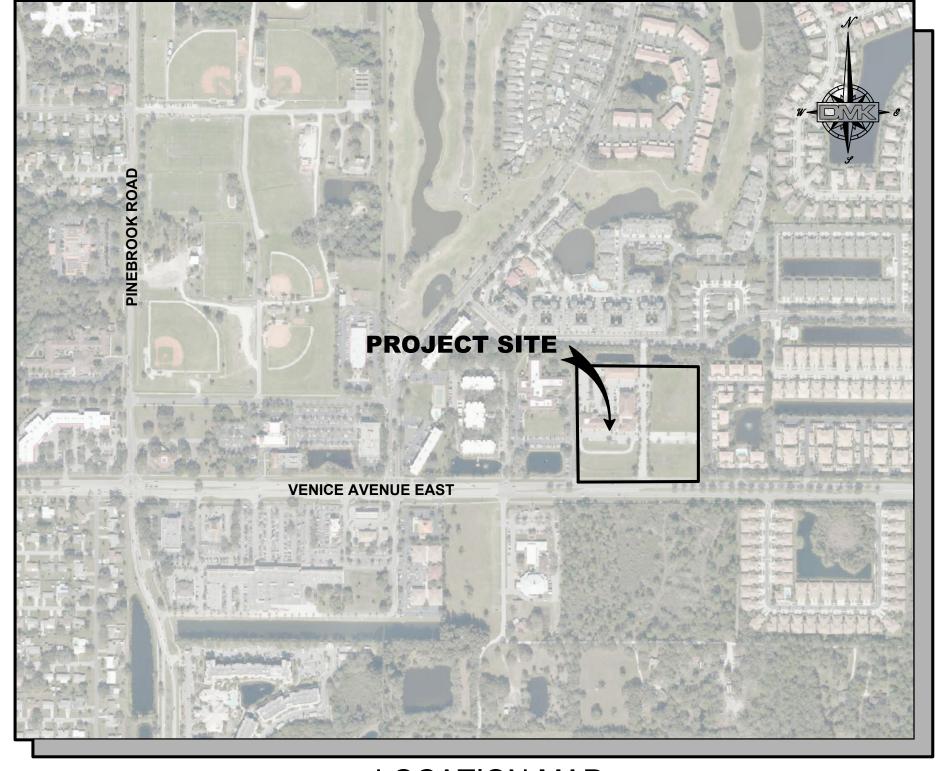

## LOCATION MAP N.T.S. SARASOTA COUNTY, FLORIDA

1460 E. VENICE AVE
VENICE, FL 34292
PARCEL I.D. No. 0412-02-0001
SECTION 9, TOWNSHIP 39S, RANGE 19E

ENGINEER:

SURVEYOR:
BRITT SURVEYING, INC.
606 CYPRESS AVE

VENICE, FL 34285 TEL: (941) 439-1396 ASSOCIATES
ENGINEERS SURVEYORS

A S S O C I A T E S
ENGINEERS SURVEYORS

421 COMMERCIAL COURT, SUITE C
VENICE, FL 34292

TEL: (941) 412-1293 FAX: (941) 412-1043
EMAIL: info@dmkassoc.com
C.A. No. 3943

 LOT COVERAGE TABULATION

 PRE
 POST

 AREA (Ac.)
 PERCENTAGE
 AREA (Ac.)
 PERCENTAGE

 LOT AREA
 10.39
 100%
 10.39
 100%

 BUILDING COVERAGE
 1.71
 16.46%
 2.01
 19.35%

 IMPERMIQUES AREA
 6.95
 66.88%
 7.03
 76.32%

WEST: OFFICE, PROFESSIONAL AND INSTITUTIONAL (OPI)/VG

EXISTING LAND USE: VACANT/COMMERCIAL, RETAIL, OFFICE, MEDICAL

NORTH: PLANNED UNIT DEVELOPMENT (PUD) AND RESIDENTIAL MULTI-FAMILY (RMF-2)

PLANNING UNIT DEVELOPMENT (PUD) / VENETIAN GATEWAY DISTRICT (VG)

FUTURE LAND USE: MIXED USE RESIDENTIAL (MUR)

SOUTH: RIGHT-OF-WAY, E VENICE AVE.

SOUTH: RIGHT-OF-WAY, E VENICE AVE.

EAST: RESIDENTIAL MULTI-FAMILY (RMF-3/VG

EAST: RESIDENTIAL WEST: NURSING HOME

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#### CONSTRUCTION STANDARDS NOTE:

- 1. ALL CONSTRUCTION MUST MEET THE MINIMUM DESIGN STANDARDS OF THE LATEST VERSION OF THE CITY STANDARD DETAILS. WHERE CONFLICTS EXIST BETWEEN THE APPROVED CONSTRUCTION PLANS AND THE SPECIFICATIONS, IT IS THE CONTRACTOR'S RESPONSIBILITY TO NOTIFY THE ENGINEER FOR CLARIFICATION PRIOR TO ORDERING MATERIALS OR INITIATING CONSTRUCTION OF THE ITEM WITH POTENTIAL CONFLICTS
- 2. STATEMENT OF OWNERSHIP AND CONTROL: THE SUBJECT PARCELS ARE UNDER THE UNIFIED OWNERSHIP AND CONTROL OF THE OWNER, GALLERIA SHOPS, LLC. OPERATION AND MAINTENANCE RESPONSIBILITY WILL BE THAT OF THE OWNER.

#### **REQUIRED NOTES:**

- 1. A SEPARATE BUILDING PERMIT MUST BE APPLIED FOR AND ISSUED FOR EVERY SIGN, WALL, OUTDOOR LIGHTING AND STRUCTURE ON THE SITE. THE APPROVAL OF THESE CONSTRUCTION PLANS DOES NOT EXEMPT THE CONTRACTOR FROM OBTAINING THE NECESSARY BUILDING PERMITS.
- 2. ALL WORK CONDUCTED IN THE CITY OF VENICE RIGHT-OF-WAY (ROW) WILL REQUIRE THE ISSUANCE OF A ROW PERMIT. ALL WORK CONDUCTED IN THE SARASOTA COUNTY RIGHT-OF-WAY WILL REQUIRE ISSUANCE OF A SARASOTA COUNTY RIGHT-OF-WAY PERMIT.
- 3. TREE REMOVAL PERMIT MUST BE OBTAINED FROM CITY OF VENICE.
- 4. POST DEVELOPMENT RUNOFF DOES NOT EXCEED PRE-DEVELOPMENT RUNOFF VOLUME OR RATE FOR A 24-HOUR, 25-YEAR STORM EVENT.
- 5. ALL FIRE SERVICE BACKFLOW ASSEMBLIES SHALL BE INSTALLED BY A CERTIFIED CONTRACTOR WITH A CLASS I, II, OR V CERTIFICATE OF COMPETENCY ISSUED BY THE STATE FIRE MARSHALL AS PER F.S. 633.521.
- 6. CONSTRUCTION SITE MUST BE POSTED WITH 24-HOUR CONTACT INFORMATION.
- 7. ALL UTILITIES, WHETHER PUBLIC OR PRIVATE, SHALL MEET CITY OF VENICE STANDARDS.
- 8. CONTACT PUBLIC WORKS SOLID WASTE DIVISION (941-486-2422) FOR APPROVAL OF DUMPSTER LOCATION AND LAYOUT PRIOR TO CONSTRUCTION.
- 9. THIS SITE AND DEVELOPMENT PLAN AMENDMENT DOES NOT AUTHORIZE DEVELOPMENT OUTSIDE THE LIMITS OF DEVELOPMENT AS DEPICTED ON THE SITE DEVELOPMENT PLAN SHEET.

DMK PROJECT No. 19-0127

#### **UTILITY PROVIDERS**

WATER & SEWER:
CITY OF VENICE UTILITIES DEPT.
200 N. WARFIELD AVE
VENICE, FL 34285

#### ELECTRICITY:

FLORIDA POWER & LIGHT (FP&L) 425 ALBEE FARM ROAD VENICE, FLORIDA, 34285

#### PHONE:

VERIZON FLORIDA, INC. 1909 US HIGHWAY 301 N. BLDG D TAMPA, FL 33619


#### CABLE:

COMCAST CABLEVISION OF WEST FLORIDA 5202 FRUITVILLE ROAD SARASOTA, FL 34232

ENGINEER OF RECORD

TIMOTHY E. ROANE, P.E. STATE OF FLORIDA NO. 63113

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- 2. THE CONTRACTOR SHALL PROVIDE CERTIFIED RECORD DRAWING INFORMATION THAT MEET THE CITY OF VENICE PERMIT REQUIREMENTS TO THE ENGINEER.
- 3. ALL WORK SHALL BE PERFORMED IN ACCORDANCE WITH THE REQUIREMENTS OF THE CITY OF VENICE, FLORIDA, AND THE CITY STANDARD DETAIL SUPERSEDE.
- 4. THERE SHALL BE NO CHANGE OR DEVIATION OF THESE PLANS OR SPECIFICATIONS UNLESS PRIOR WRITTEN APPROVAL FROM THE CITY OF VENICE IS OBTAINED.
- 5. THE CONTRACTOR SHALL NOTIFY THE ENGINEER IMMEDIATELY IF AND WHEN A POSSIBLE ERROR IS FOUND IN THE PLANS OR STAKED ALIGNMENT AND/OR GRADES.
- 6. CONTRACTOR SHALL NOTIFY ENGINEER IMMEDIATELY OF ANY AND ALL FIELD CONDITION(S) THAT WILL PREVENT THE CONSTRUCTION OF ANY ELEMENT OF THE PROPOSED PROJECT IN ACCORDANCE WITH THE DESIGN STANDARDS AND APPROVED CONSTRUCTION DOCUMENTS FOR THIS PROJECT. IN ALL INSTANCES, THE CONTRACTOR SHALL NOTIFY THE ENGINEER PRIOR TO ANY INSTALLATION OF WORK. IF CONTRACTOR ELECTS TO INSTALL ANY WORK WHICH DEVIATES FROM THE APPROVED CONSTRUCTION DOCUMENTS WITHOUT PRIOR WRITTEN APPROVAL BY THE ENGINEER, THEN THE COST OF REMOVAL, REPAIR, REDESIGN AND/OR REPLACEMENT WILL BE THE RESPONSIBILITY OF THE CONTRACTOR UNLESS SAID WORK IS ACCEPTED AS AN AS-BUILT DEVIATION BY THE CITY OR THE ENGINEER. IN NO CASE SHALL THE CITY OR ENGINEER BE RESPONSIBLE FOR THE COST OF REMOVAL, REPAIR, REDESIGN AND/OR REPLACEMENT OF ANY WORK THAT DEVIATES FROM THE DESIGN STANDARDS AND APPROVED CONSTRUCTION DOCUMENTS FOR THIS PROJECT.
- 7. CONSTRUCTION OF THE SIDEWALKS SHALL BE IN COMPLIANCE WITH THE AMERICANS WITH DISABILITIES ACT AND THE FLORIDA ACCESSIBILITY CODE, AND THE CITY OF VENICE STANDARD DETAILS.
- 8. THE CONTRACTOR SHALL CONTACT ALL UTILITY COMPANIES PRIOR TO THE BEGINNING OF ANY ON-SITE OR OFF-SITE CONSTRUCTION. THE CONTRACTOR SHALL BE RESPONSIBLE TO IDENTIFY AND REPORT THE EXACT LOCATION OF ALL EXISTING UTILITIES WITHIN THE CONSTRUCTION LIMITS, WHETHER THEY ARE IDENTIFIED ON THE DRAWINGS OR NOT.
- 9. CONTRACTOR SHALL INCLUDE IN HIS BID PRICE THE COST OF EROSION CONTROL. EROSION AND SEDIMENT CONTROL BEST MANAGEMENT SHALL BE OBSERVED DURING CONSTRUCTION BY THE CONTRACTOR. THE METHODS WHICH SHOULD BE USED INCLUDE BUT ARE NOT LIMITED TO:
- a. THE CONTRACTOR SHALL BE RESPONSIBLE FOR ANY SILTATION ENTERING THE STORM DRAINAGE SYSTEM BOTH ON-SITE AND OFF-SITE. THE CONTRACTOR SHALL UTILIZE SAND BAGS AND HAY BALES OR OTHER EROSION CONTROL METHODS TO CONTROL EROSION.
- b. CONTRACTOR SHALL PLACE SOD AROUND ALL INLETS A MINIMUM OF 2 FEET TO MINIMIZE ROAD AND STORM
- c. THE CONTRACTOR SHALL BE RESPONSIBLE FOR THE CONTROL OF DUST AT ALL TIMES DURING CONSTRUCTION BY UTILIZING WATER TRUCKS, ANTI-DRAFT FENCING AND BY COVERING OPEN BODIED TRUCKS TRANSPORTING DEBRIS.
- 10. WHERE EXCAVATIONS ARE IN CLOSE PROXIMITY OF TREES, THE CONTRACTOR SHALL USE EXTREME CARE NOT TO DAMAGE THE ROOT SYSTEMS OF TREES AND OTHER LANDSCAPE FEATURES WHICH ARE TO BE SAVED AND/OR SALVAGED FOR RESTORATION PURPOSES. NO EQUIPMENT, SUPPLIES OR VEHICLES SHALL BE STORED OR PARKED WITHIN THE DRIP LINE OF TREES TO REMAIN AND BE PRESERVED. IT SHALL BE THE RESPONSIBILITY OF THE CONTRACTOR TO INFORM ALL EMPLOYEES AND SUBCONTRACTORS OF THIS REQUIREMENT AND TO ENFORCE SAME.
- 11. CONTRACTOR SHALL TAKE ALL NECESSARY PRECAUTIONS DURING CONSTRUCTION TO CONTROL EROSION AND PREVENT THE TRANSPORT OF SEDIMENT TO SURFACE WATERS, STORM DRAINS AND/OR ADJACENT PROPERTIES. SILT SCREENS, AND/OR FILTER FABRIC, OR OTHER STANDARD EROSION CONTROL DEVICES SHALL BE PROVIDED IN ACCORDANCE WITH F.D.O.T. STANDARDS. EROSION CONTROL DEVICES (E.G. SILT SCREENS, TURBIDITY CURTAINS) SHALL BE INSTALLED AND MAINTAINED IN LOCATIONS INDICATED ON THE CONSTRUCTION PLANS OR ADDITIONALLY AT LOCATIONS WHERE CONSTRUCTION ACTIVITIES OR UNSTABILZED SOILS HAVE THE POTENTIAL TO BE TRANSPORTED INTO AND/OR RESULT IN SEDIMENTATION OR TURBIDITY ENTERING WATERWAYS, WATER BODIES, WETLANDS, OR PRIVATE PRÓPERTIES.
- 12. CONTRACTOR SHALL MAINTAIN TRAFFIC IN ACCORDANCE WITH FDOT INDEX 600 (LATEST) STANDARDS.
- 13. CONTRACTOR SHALL SPRINKLE OR OTHERWISE APPLY WATER TO EXPOSED CONSTRUCTION AREAS TO CONTROL SIGNIFICANT EROSION AND FUGITIVE DUST.
- 14. ALL CLEARING, GRUBBING AND CONSTRUCTION DEBRIS TO BE REMOVED FROM SITE AND PROPERLY DISPOSED.
- 15. THE REMOVAL OF ANY EXISTING STRUCTURES OR STORM SEWERS, HEADWALLS ETC., SHALL BE CONSIDERED
- INCIDENTAL WORK AND NO ADDITIONAL COMPENSATION SHALL BE MADE FOR THESE ITEMS. 16. THE CONTRACTOR SHALL BE RESPONSIBLE FOR PROVIDING AREAS FOR STAGING AND STOCKPILING CONSTRUCTION MATERIALS AND WASTE OVERBURDEN INCLUDING APPROPRIATE EROSION AND SEDIMENTATION
- 17. THE CONTRACTOR SHALL BE RESPONSIBLE FOR THE PROPER HANDLING AND DISPOSAL OF CONTAMINATED SOILS IN ACCORDANCE WITH ALL STATE AND FEDERAL LAWS.

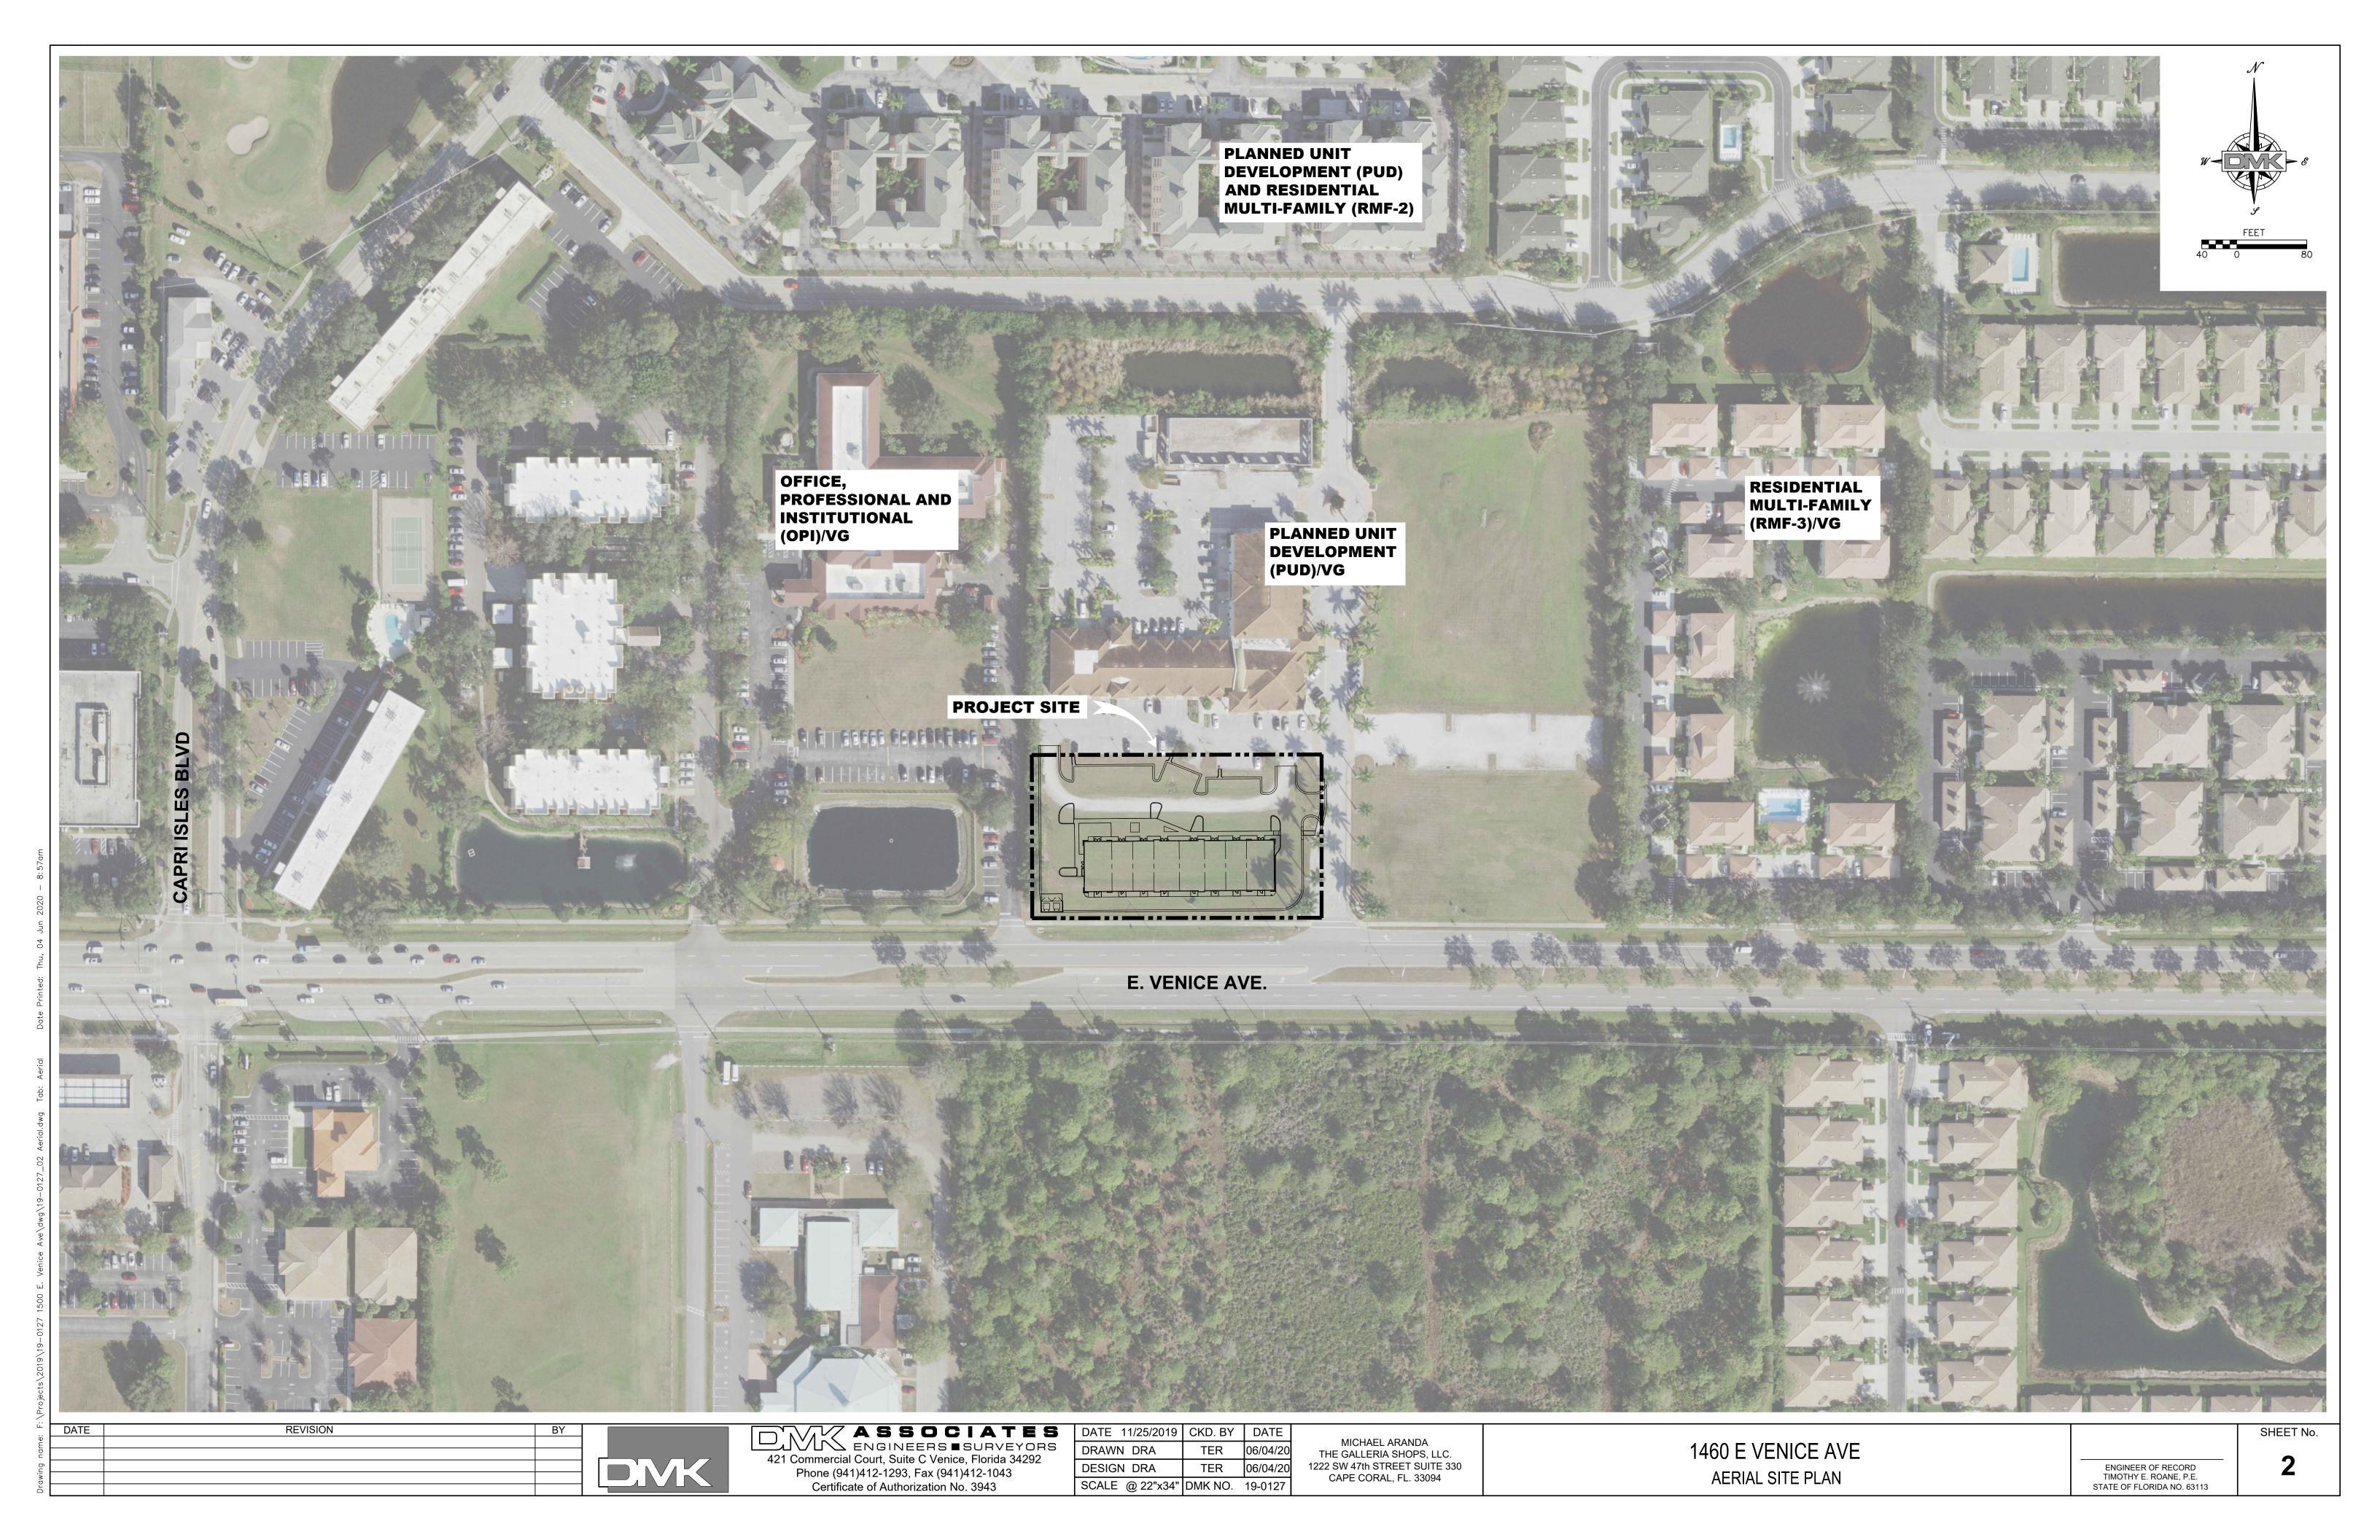CONTROL DEVICES AND BEST MANAGEMENT PRACTICES.

- 18. THE ONLY ACCEPTABLE METHODS FOR REMOVAL OF PAVEMENT MARKINGS ARE HYDRO-BLASTING OR GRINDING. EXISTING MARKINGS SHALL NO LONGER BE VISIBLE UPON COMPLETION OF THE REMOVAL, AS DEEMED BY THE ASSIGNED THE CITY OF VENICE PROJECT INSPECTOR / ENGINEER.
- 19. CONTRACTOR SHALL BE RESPONSIBLE FOR OBTAINING DEWATERING PERMIT BY SWFWMD (IF REQUIRED) AND SHALL ALLOW 45 DAYS FOR APPROVAL PROCESS. THE CONTRACTOR SHALL BE RESPONSIBLE FOR FOLLOWING ALL PERMIT REQUIREMENTS RELATED TO DEWATERING. ALL WORK PERFORMED, INCLUDING PERMITTING, WILL BE INCIDENTAL TO THE PAYMENT ITEMS OF STANDARD SPECIFICATIONS, SECTION 120, EXCAVATION AND **FMBANKMFNT**
- 20. SOD SHALL BE LAID AT BACK OF CURB, PAVEMENT EDGES, SWALES, INLETS, MITERED ENDWALLS, AND DETENTION AREAS AS SHOWN IN DETAILS OR AS DIRECTED BY THE ENGINEER, AND IN ALL AREAS DISTURBED BY THE WORK THAT IS NOT UNDER PROPOSED HARDSCAPE IMPROVMENTS
- 21. ALL AREAS DISTURBED BY CONSTRUCTION ARE TO BE SODDED WITHIN 7 CALENDAR DAYS TO PREVENT EROSION
- 22. ALL PROPOSED GROUND ELEVATIONS ARE FINISHED SOD ELEVATIONS. FINISH GRADING SHALL BE 0.2 FEET LESS THAN ELEVATIONS SHOWN TO ALLOW FOR THICKNESS OF SOD.
- 23. ALL TYPE B (CONCRETE, BROKEN ASPHALT, ROCKS), TYPE C (VEGETATIVE LAND CLEARING DEBRIS), OR TYPE D (REFUSE, PLASTIC, WOOD, METAL, ETC.) FILLS GENERATED BY THE PROJECT SHALL BE DISPOSED OF AT A PERMITTED LANDFILL OR RECYCLE FACILITY. ALL EXCESS TYPE A (CLEAN EARTHEN MATERIAL) SHALL BE HAULED TO A PERMITTED LANDFILL, CITY OWNED PROPERTY, OR SITE AUTHORIZED UNDER A BUILDING PERMIT, EARTH MOVING PERMIT, OR CONSTRUCTION PLAN APPROVAL TO RECEIVE FILL.
- 24. DURING THE PROJECT, ALL CLEARING AND STOCKPILING OF FILLS SHALL BE CONTAINED WITHIN THE PROJECT LIMITS. TEMPORARY STOCKPILING OF ANY TYPE A, B, C, OR D FILLS UPON PRIVATE PROPERTIES REQUIRES AUTHORIZATION FROM THE CITY OF VENICE IN THE FORM OF AN EARTH MOVING PERMIT OR TEMPORARY CONSTRUCTION EASEMENT.
- 25. ALL EARTHWORK AND COMPACTION SHALL BE INSPECTED BY THE ENGINEER OR HIS DULY APPOINTED REPRESENTATIVE, PRIOR TO FILLING OR CONSTRUCTION.
- 26. CONTRACTOR SHALL MAINTAIN SLOPES AND SOD UNTIL COMPLETION AND ACCEPTANCE OF TOTAL PROJECT OR GROWTH IS ESTABLISHED. UNTIL ACCEPTANCE, ALL EROSION, SILTATION AND MAINTENANCE OF GRADES SHALL BE THE RESPONSIBILITY OF THE CONTRACTOR.
- 27. PLEASE NOTE THAT ON PLANS, POSITIVE DRAINAGE SHALL BE PROVIDED FOR ALL ADJACENT PROPERTIES AND MAINTAIN ALL HISTORIC OFFSITE FLOW PATTERNS.
- 28. IT IS THE CONTRACTORS RESPONSIBILITY TO BARRICADE AREAS UNDER CONSTRUCTION PURSUANT TO MAINTENANCE OF TRAFFIC PLANS OR AS OTHERWISE APPROVED FOR USE.
- 29. BOUNDARY TREE PROTECTION. BOUNDARY TREES ARE TREES ON PROPERTY ADJACENT TO THE SUBJECT PROPERTY WITH A CRITICAL ROOT ZONE THAT WILL BE IMPACTED BY THE PROPOSED ACTIVITY. BOUNDARY TREES SHALL BE REQUIRED TO HAVE A TREE PROTECTION ZONES ESTABLISHED AND BARRICADED PRIOR TO ANY LAND DISTURBANCE ACTIVITY.

#### **GENERAL NOTES (CONTINUED):**

- 29. A TREE PERMIT WILL BE REQUIRED PRIOR TO ANY CONSTRUCTION, NATIVE VEGETATIVE REMOVAL WITHIN THE DRIPLINE OF A TREE, AND/OR TREE REMOVAL.
- 30. ANY WELLS DISCOVERED DURING EXCAVATION, EARTHMOVING OR CONSTRUCTION MUST BE REPORTED TO THE SARASOTA COUNTY HEALTH DEPARTMENT ENVIRONMENTAL HEALTH WITHIN 24 HOURS OF DISCOVERY.
- 31. ALL WELLS ON SITE SHALL BE PLUGGED BY A LICENSED WELL DRILLING CONTRACTOR IN ACCORDANCE WITH ALL APPLICABLE STATE AND LOCAL REGULATIONS.
- 32. IN ADDITION TO THE CONCRETE SIDEWALK SHOWN TO BE REMOVED AND REPLACED. ANY EXISTING SIDEWALK PANELS ALONG THE PERIMETER OF THE SITE THAT IS DAMAGED OR CRACKED SHALL ALSO BE REMOVED AND REPLACED.
- 33. STANDARD PARKING LOT STRIPING SHALL COMPLY WITH SECTION 710 OF THE FDOT STANDARD SPECIFICATIONS FOR ROAD AND BRIDGE CONSTRUCTION, LATEST EDITION.

#### **GENERAL SIGNAGE AND PAVEMENT MARKING NOTES:**

- 1. SIGNAGE AND PAVEMENT MARKING TO BE IN ACCORDANCE WITH THE LATEST EDITION OF THE FDOT "ROADWAY AND TRAFFIC DESIGN STANDARDS". EXCEPT NO COLORS OTHER THEN WHITE AND BLUE SHALL BE USED.
- 2. THE STOP BARS SHALL BE STRIPED WITH 4 MIL THERMOPLASTIC PAINT. PARKING LOT STRIPING SHALL BE TRAFFIC RATED PAVEMENT PAINT.
- 3. ALL CITY STREET SIGNS WILL BE BLUE BACKGROUND WITH 6" WHITE LETTERS AND CONSTRUCTED WITH HIGH INTENSITY REFLECTORIZED MATERIAL. LOCAL ROAD SIGNS SHALL BE 9 INCHES WIDE. ALL STREET SIGNS DESIGNS TO BE APPROVED BY THE DIRECTOR OF PUBLIC WORKS PRIOR TO INSTALLATION.
- 4. IF A CITY OF VENICE—OWNED SIGN IS TO BE REMOVED, COORDINATE RETURNING THE CITY OF VENICE PROPERTY WITH THE PUBLIC WORKS DEPARTMENT AT 941-486-2626.
- 5. ALL SIGNS SHALL BE CONSTRUCTED IN ACCORDANCE WITH MUTCD CRITERIA FOR SIGN SIZE, SHAPE, LETTERING DIMENSIONS AND REFLECTIVITY.
- 6. ALL STREET LIGHT SPLICES SHALL BE MADE USING "RAYCHEM GHFC-2" OR APPROVED EQUAL, AND BE LOCATED IN THE PULL BOX.

#### **GENERAL DRAINAGE PIPE NOTES:**

- 1. ALL NEW STORM DRAIN LINES AND ASSOCIATED COMPONENTS SHALL BE CONSTRUCTED TO ALIGNMENT AND LOCATION AS SHOWN IN THE PLANS UNLESS OTHERWISE DIRECTED BY ENGINEER.
- 2. ALL CONCRETE DRAINAGE STRUCTURES AND PIPES SHALL BE CONSTRUCTED WITH 3,000 PSI CONCRETE.
- 3. ALL DRAINAGE PIPE JOINTS SHALL BE WRAPPED PER FDOT INDEX 280.
- 4. ALL REINFORCED CONCRETE PIPE (RCP), & ELLIPTICAL REINFORCED CONCRETE PIPE (ERCP) SHALL BE CLASS III PIPE PER FDOT INDEX 205.
- 5. ALL ERCP SHALL BE INSTALLED WITH THE LONGITUDINAL AXIS PLACED HORIZONTALLY UNLESS NOTED OTHERWISE.
- 6. OR STORM WATER DRAINAGE PIPES AND FITTINGS, HANCOR HI-q HIGH DENSITY POLYETHYLENE (HDPE) (OR APPROVED EQUAL), MEETING THE FOLLOWING REQUIREMENTS AND APPROVED BY CITY OF VENICE, CITY ENGINEERS.
  - a. AASHTO M252 SPECIFICATIONS FOR CORRUGATED POLYETHYLENE DRAINAGE TUBING, 3 INCH - 10 INCH DIAMETER.
  - b. AASHTO M294 SPECIFICATIONS FOR CORRUGATED POLYETHYLENE PIPE, 12 INCH 36 INCH DIA.
  - c. ASTM D1056 SPECIFICATIONS FOR FLEXIBLE CELLULAR MATERIAL SPONGE OR EXPANDED RUBBER.
  - d. ASTM D1248 SPECIFICATIONS FOR POLYETHYLENE PLASTIC MOLDING AND EXTRUSION MATERIALS.
  - e. ASTM D2321 PRACTICE FOR UNDERGROUND INSTALLATION OF FLEXIBLE THERMOPLASTIC SEWER PIPE.

#### CITY of VENICE STORMWATER GENERAL NOTES:

- 1. ALL STORMWATER STRUCTURES SHALL BE BEDDED ON 6" MIN. COMPACTED GRAVEL OR CRUSHED STONE.
- 2. STORMWATER PIPES INSTALLED BELOW THE WATER TABLE, WITHIN WET CONDITIONS WILL REQUIRED 6" MIN COMPACTED GRAVEL OR CRUSHED STONE BEDDING.
- 3. ALL STORMWATER PIPES AND STRUCTURES WITHIN PUBLIC TRAFFICABLE AREAS SHALL BE REINFORCED CONCRETE UNLESS OTHERWISE APPROVED BY THE CITY ENGINEER.
- 4. STORMWATER PIPES WITHIN PRIVATE PROPERTY MAY BE SMOOTH WALLED HDPE OR A-2000 PVC WITH WATERTIGHT CONNECTIONS AND SUFFICIENT COVER AS CALCULATED BY THE EOR. ROOF DRAINAGE PIPE MAY BE C900 DR-25 PVC WHITE COLOR OR BLUE COLOR WITH WHITE TAPE.
- 5. NO LIFTING HOLES OR OTHER SIMILAR PENETRATIONS OF STORMWATER PIPING PERMITTED. ALL PIPING SHALL BE WRAPPED WITH MIRIEI FILTER FABRIC OR FOUAL.
- 6. ALL PIPE JOINTS WILL BE GASKETED ACCORDING TO THE MANUFACTURE, FDOT AND ASTM STANDARDS TO PROVIDE A
- 7. ALL PRE-CAST STRUCTURES SHALL MEET FDOT AND ASTM C-478 STANDARDS.
- 8. INLET GRATINGS IN AREAS ACCESSIBLE TO BICYCLE OR TO PEDESTRIAN USE MUST BE RETICULINE OR OF SIMILAR MANUFACTURE.
- 9. INLET GRATING IN CORROSIVE AREAS SHALL BE GALVANIZED.
- 10. STORMWATER INLETS SHOULD BE DESIGNED TO REJECT DEBRIS , TRASH, AND OTHER POLUTANTS FROM ENTERING INTO PUBLIC STRORMWATER CONVEYANCES.
- 11. OUTFALL INTO SURFACE WATERS SHOULD BE DESIGNED WITH DEVICES TO REDUCE THE DISCHARGE OF FOREIGN MATERIAL.

#### MAINTENANCE REQUIREMENT NOTES:

- 1. REMOVE ANY TRASH OR DEBRIS FROM SWALES, INLET STRUCTURE AND PIPES. SPECIAL CARE SHOULD BE TAKEN TO INSPECT THE CONTROL STRUCTURE ON A REGULAR BASIS TO REMOVE TRASH AND OR GRASS CLIPPINGS WHICH MAY INHIBIT PROPER SURFACE DRAINAGE.
- 2. INSPECT ANY AREAS SUBJECT TO EROSION AND SEED OR SOD AS NECESSARY.
- 3. INSPECT THE CONDITION OF THE WATER CONTROL STRUCTURES ON A REGULAR BASIS AND REPAIR AS NEEDED. IF THE DRAWDOWN SYSTEM OF THE WATER MANAGEMENT AREA DOES NOT FUNCTION AS ORIGINALLY DESIGNED, DETERMINE WHERE THE SYSTEM HAS FAILED AND REPAIR OR REPLACE AS REQUIRED TO MEET CHAPTERS 40D-4 AND 62-65, F.A.C. REQUIREMENTS.
- 4. ALL STORMWATER RETENTION FACILITY SHOULD BE INSPECTED ANNUALLY FOR THE PRESENCE OF ANY EXOTIC PLANTS SHOULD BE REMOVED AND MEASURES TAKEN TO PREVENT THEIR RETURN AND REPLACED WITH NATIVE
- 5. ADHERE TO ALL SPECIAL MAINTENANCE INSTRUCTION AS PROVIDED BY THE VARIOUS MATERIAL SUPPLIERS/MANUFACTURERS, AND MADE AVAILABLE VIA THE GENERAL CONTRACTOR UPON PROJECT COMPLETION.
- 6. COMPLY WITH ALL MAINTENANCE, INSPECTION AND REPORTING REQUIREMENTS AS SPECIFIED IN ANY REGULATORY AGENCY PERMITS (I.E. FDEP SURFACE WATER MANAGEMENT PERMIT).

MICHAEL ARANDA

THE GALLERIA SHOPS, LLC.

1222 SW 47th STREET SUITE 330

CAPE CORAL, FL. 33094

#### **EROSION CONTROL MAINTENANCE SCHEDULE:**

- 1. THE CONTRACTOR SHALL INSTALL SILT FENCE, AND OTHER EROSION CONTROL DEVICES AS SHOWN ON THE DRAWINGS PRIOR TO BEGINNING CONSTRUCTION. THESE INSTALLATIONS AS SHOWN ON THE DRAWINGS SHALL BE CONSIDERED THE MINIMUM EROSION/SILTATION PROTECTION REQUIRED FOR THE SITE.
- 2. IN ADDITION THE ENGINEER, OWNER, OR OWNER'S REPRESENTATIVE MAY DEEM IT NECESSARY TO INSTALL PROTECTIVE FACILITIES ELSEWHERE ON THE SITE. THE CONTRACTOR SHALL BE RESPONSIBLE FOR MAINTAINING THE EROSION PROTECTION FACILITIES THROUGH COMPLETION OF CONSTRUCTION. THE CONTRACTOR SHALL PERFORM DAILY INSPECTIONS OF THE FACILITIES TO ENSURE THAT THE EROSION PROTECTION FACILITIES ARE MAINTAINING THEIR PROTECTION FUNCTIONS AND INTEGRITY.
- 3. ALL EROSION PROTECTION FACILITIES SHALL BE REMOVED AFTER CONSTRUCTION COMPLETION, AND WHEN A VEGETATIVE COVER HAS BEEN WELL ESTABLISHED OVER THE CONSTRUCTED AREAS PER THE PLANS. THE CONTRACTOR SHALL REMOVE PROTECTION FACILITIES ONLY UPON APPROVAL BY THE ENGINEER, OWNER, OR OWNER'S REPRESENTATIVE.

#### WATER RESOURCE NOTES:


- 1. EROSION AND SEDIMENT CONTROL BEST MANAGEMENT PRACTICES (BMPS) IN ADDITION TO THOSE PRESENTED ON THE PLANS AND OUTLINED IN THE EROSION AND SEDIMENT CONTROL PLAN (ECP) AND STORMWATER POLLUTION PREVENTION PLAN (SWPPP) SHALL BE IMPLEMENTED AS NECESSARY TO PREVENT TURBID DISCHARGES FROM FLOWING ONTO ADJACENT PROPERTIES OR ROADWAYS, OFF SITE STORMWATER CONVEYANCES OR RECEIVING WATERS, OR ON SITE WETLANDS AND SURFACE WATERS. BMPS SHALL BE DESIGNED, INSTALLED, AND MAINTAINED BY THE SITE OPERATOR TO ENSURE THAT OFF SITE SURFACE WATER QUALITY REMAINS CONSISTENT WITH STATE AND LOCAL REGULATIONS. THE OPERATOR IS THE ENTITY THAT OWNS OR OPERATES THE CONSTRUCTION ACTIVITY AND HAS AUTHORITY TO CONTROL THOSE ACTIVITIES AT THE PROJECT NECESSARY TO ENSURE COMPLIANCE.]
- 2. THE OPERATOR SHALL ENSURE THAT ADJACENT PROPERTIES ARE NOT IMPACTED BY WIND EROSION, OR EMISSIONS OF UNCONFINED PARTICULATE MATTER IN ACCORDANCE WITH RULE 62-296.320(4)(C)1, F.A.C., BY TAKING APPROPRIATE MEASURES TO STABILIZE AFFECTED AREAS.
- 3. FUEL AND OTHER PETROLEUM PRODUCT SPILLS THAT ENTER STORMWATER DRAINS OR WATERBODIES, OR FUEL AND OTHER PETROLEUM PRODUCT SPILLS THAT ARE IN EXCESS OF 25 GALLONS SHALL BE CONTAINED, CLEANED UP, AND IMMEDIATELY REPORTED TO PUBLIC WORKS (941) 240-8050. SMALLER GROUND SURFACE SPILLS SHALL BE CLEANED UP AS SOON AS PRACTICAL.
- 4. IF CONTAMINATED SOIL AND/OR GROUNDWATER IS DISCOVERED DURING DEVELOPMENT OF THE SITE, ALL ACTIVITY IN THE VICINITY OF THE CONTAMINATION SHALL IMMEDIATELY CEASE, AND PUBLIC WORKS SHALL BE CONTACTED (941) 240.8050.


#### POLLUTION PREVENTION NOTES

- 1. EROSION AND SEDIMENT CONTROL BMPS IN ADDITION TO THOSE PRESENTED ON THE PLANS AND OUTLINED IN THE EROSION AND SEDIMENT CONTROL PLAN (ECP), BEST MANAGEMENT PRACTICES (BMP) PLAN, OR STORMWATER POLLUTION PREVENTION PLAN (SWPPP) SHALL BE IMPLEMENTED AS NECESSARY TO PREVENT TURBID DISCHARGES FROM FLOWING ONTO ADJACENT PROPERTIES OR ROADWAYS, OFF SITE STORMWATER CONVEYANCES OR RECEIVING WATERS, OR ON SITE WETLANDS AND SURFACE WATERS. BMPS SHALL BE DESIGNED, INSTALLED, AND MAINTAINED BY THE SITE OPERATOR TO ENSURE THAT OFF SITE SURFACE WATER QUALITY REMAINS CONSISTENT WITH STATE AND LOCAL REGULATIONS. [THE OPERATOR IS THE ENTITY THAT OWNS OR OPERATES THE CONSTRUCTION ACTIVITY AND HAS AUTHORITY TO CONTROL THOSE ACTIVITIES AT THE PROJECT NECESSARY TO ENSURE COMPLIANCE.]
- THE OPERATOR SHALL ENSURE THAT ADJACENT PROPERTIES ARE NOT IMPACTED BY WIND EROSION, OR EMISSIONS OF UNCONFINED PARTICULATE MATTER IN ACCORDANCE WITH RULE 62-296.320(4)(C)1, F.A.C., BY TAKING APPROPRIATE MEASURES TO STABILIZE AFFECTED AREAS.
- 3. FUEL AND OTHER PETROLEUM PRODUCT SPILLS THAT ENTER STORMWATER DRAINS OR WATERBODIES, OR FUEL AND OTHER PETROLEUM PRODUCT SPILLS THAT ARE IN EXCESS OF 25 GALLONS SHALL BE CONTAINED. CLEANED UP, AND IMMEDIATELY REPORTED TO THE CITY OF VENICE. GROUND SURFACE SPILLS SHALL BE CLEANED UP AS SOON AS PRACTICAL.
- 4. IF PREVIOUSLY UNKNOWN RECOGNIZED ENVIRONMENTAL CONDITIONS (E.G. CONTAMINATED SOIL AND/OR GROUNDWATER, BURIED WASTES, ETC.) ARE DISCOVERED DURING DEVELOPMENT OF THE SITE, ALL ACTIVITY IN THE IMMEDIATE VICINITY SHALL CEASE, AND THE CITY OF VENICE SHALL BE CONTACTED.
- 5. NATIONAL POLLUTANT DISCHARGE ELIMINATION SYSTEM STORMWATER:
- a. NPDES CONSTRUCTION GENERIC PERMIT COVERAGE SHALL BE OBTAINED AT LEAST 48 HOURS IN ADVANCE OF CONSTRUCTION COMMENCEMENT IN ACCORDANCE WITH THE REQUIREMENTS OF THE NATIONAL POLLUTANT DISCHARGE ELIMINATION SYSTEM (NPDES) GENERIC PERMIT FOR STORMWATER DISCHARGE FROM LARGE AND SMALL CONSTRUCTION ACTIVITIES (AKA. CONSTRUCTION GENERIC PERMIT, OR CGP).
- b. A COPY OF THE CERTIFIED NPDES NOI. OR A COPY OF THE FDEP COVERAGE CONFIRMATION LETTER SHALL BE POSTED AT THE SITE IN ACCORDANCE WITH PART 2.6 OF THE GENERIC PERMIT.
- c. A COPY OF THE CERTIFIED NPDES NOI, OR A COPY OF THE FDEP COVERAGE CONFIRMATION LETTER SHALL BE PROVIDED TO THE CITY OF VENICE WITHIN 7 CALENDAR DAYS IN ACCORDANCE WITH PART 2.6 OF THE GENERIC PERMIT.
- d. THE SWPPP SHALL BE CERTIFIED IN ACCORDANCE WITH PART 4.6 OF THE GENERIC PERMIT. AND A COPY OF THE CERTIFIED DOCUMENT SHALL BE SUBMITTED TO THE CITY OF VENICE AT LEAST 48 HOURS PRIOR TO THE COMMENCEMENT OF CONSTRUCTION..
- e. A COPY OF THE SWPPP, AND COPIES OF THE INSPECTION AND MAINTENANCE RECORDS SHALL BE MAINTAINED AT THE PROJECT SITE, AND SHALL BE READILY AVAILABLE TO CITY OR STATE INSPECTORS.
- NATIONAL POLLUTANT DISCHARGE ELIMINATION SYSTEM DEWATERING: IF NOT OTHERWISE COVERED AS OUTLINED UNDER PART 3.4 OF THE GENERIC PERMIT, THE DISCHARGE OF GROUNDWATER PRODUCED THROUGH DEWATERING, TO SURFACE WATERS, OR TO ANY PORTION OF THE MS4 WILL REQUIRE SEPARATE PERMITTING FROM THE FLORIDA DEPARTMENT OF ENVIRONMENTAL PROTECTION (DEP). PERMIT(S) SHALL BE OBTAINED PRIOR TO THE COMMENCEMENT OF DEWATERING. ANALYTICAL RESULTS FROM PRE-DISCHARGE TESTING SHALL BE PROVIDED TO THE CITY OF VENICE.

**GENERAL NOTES** 

DATE

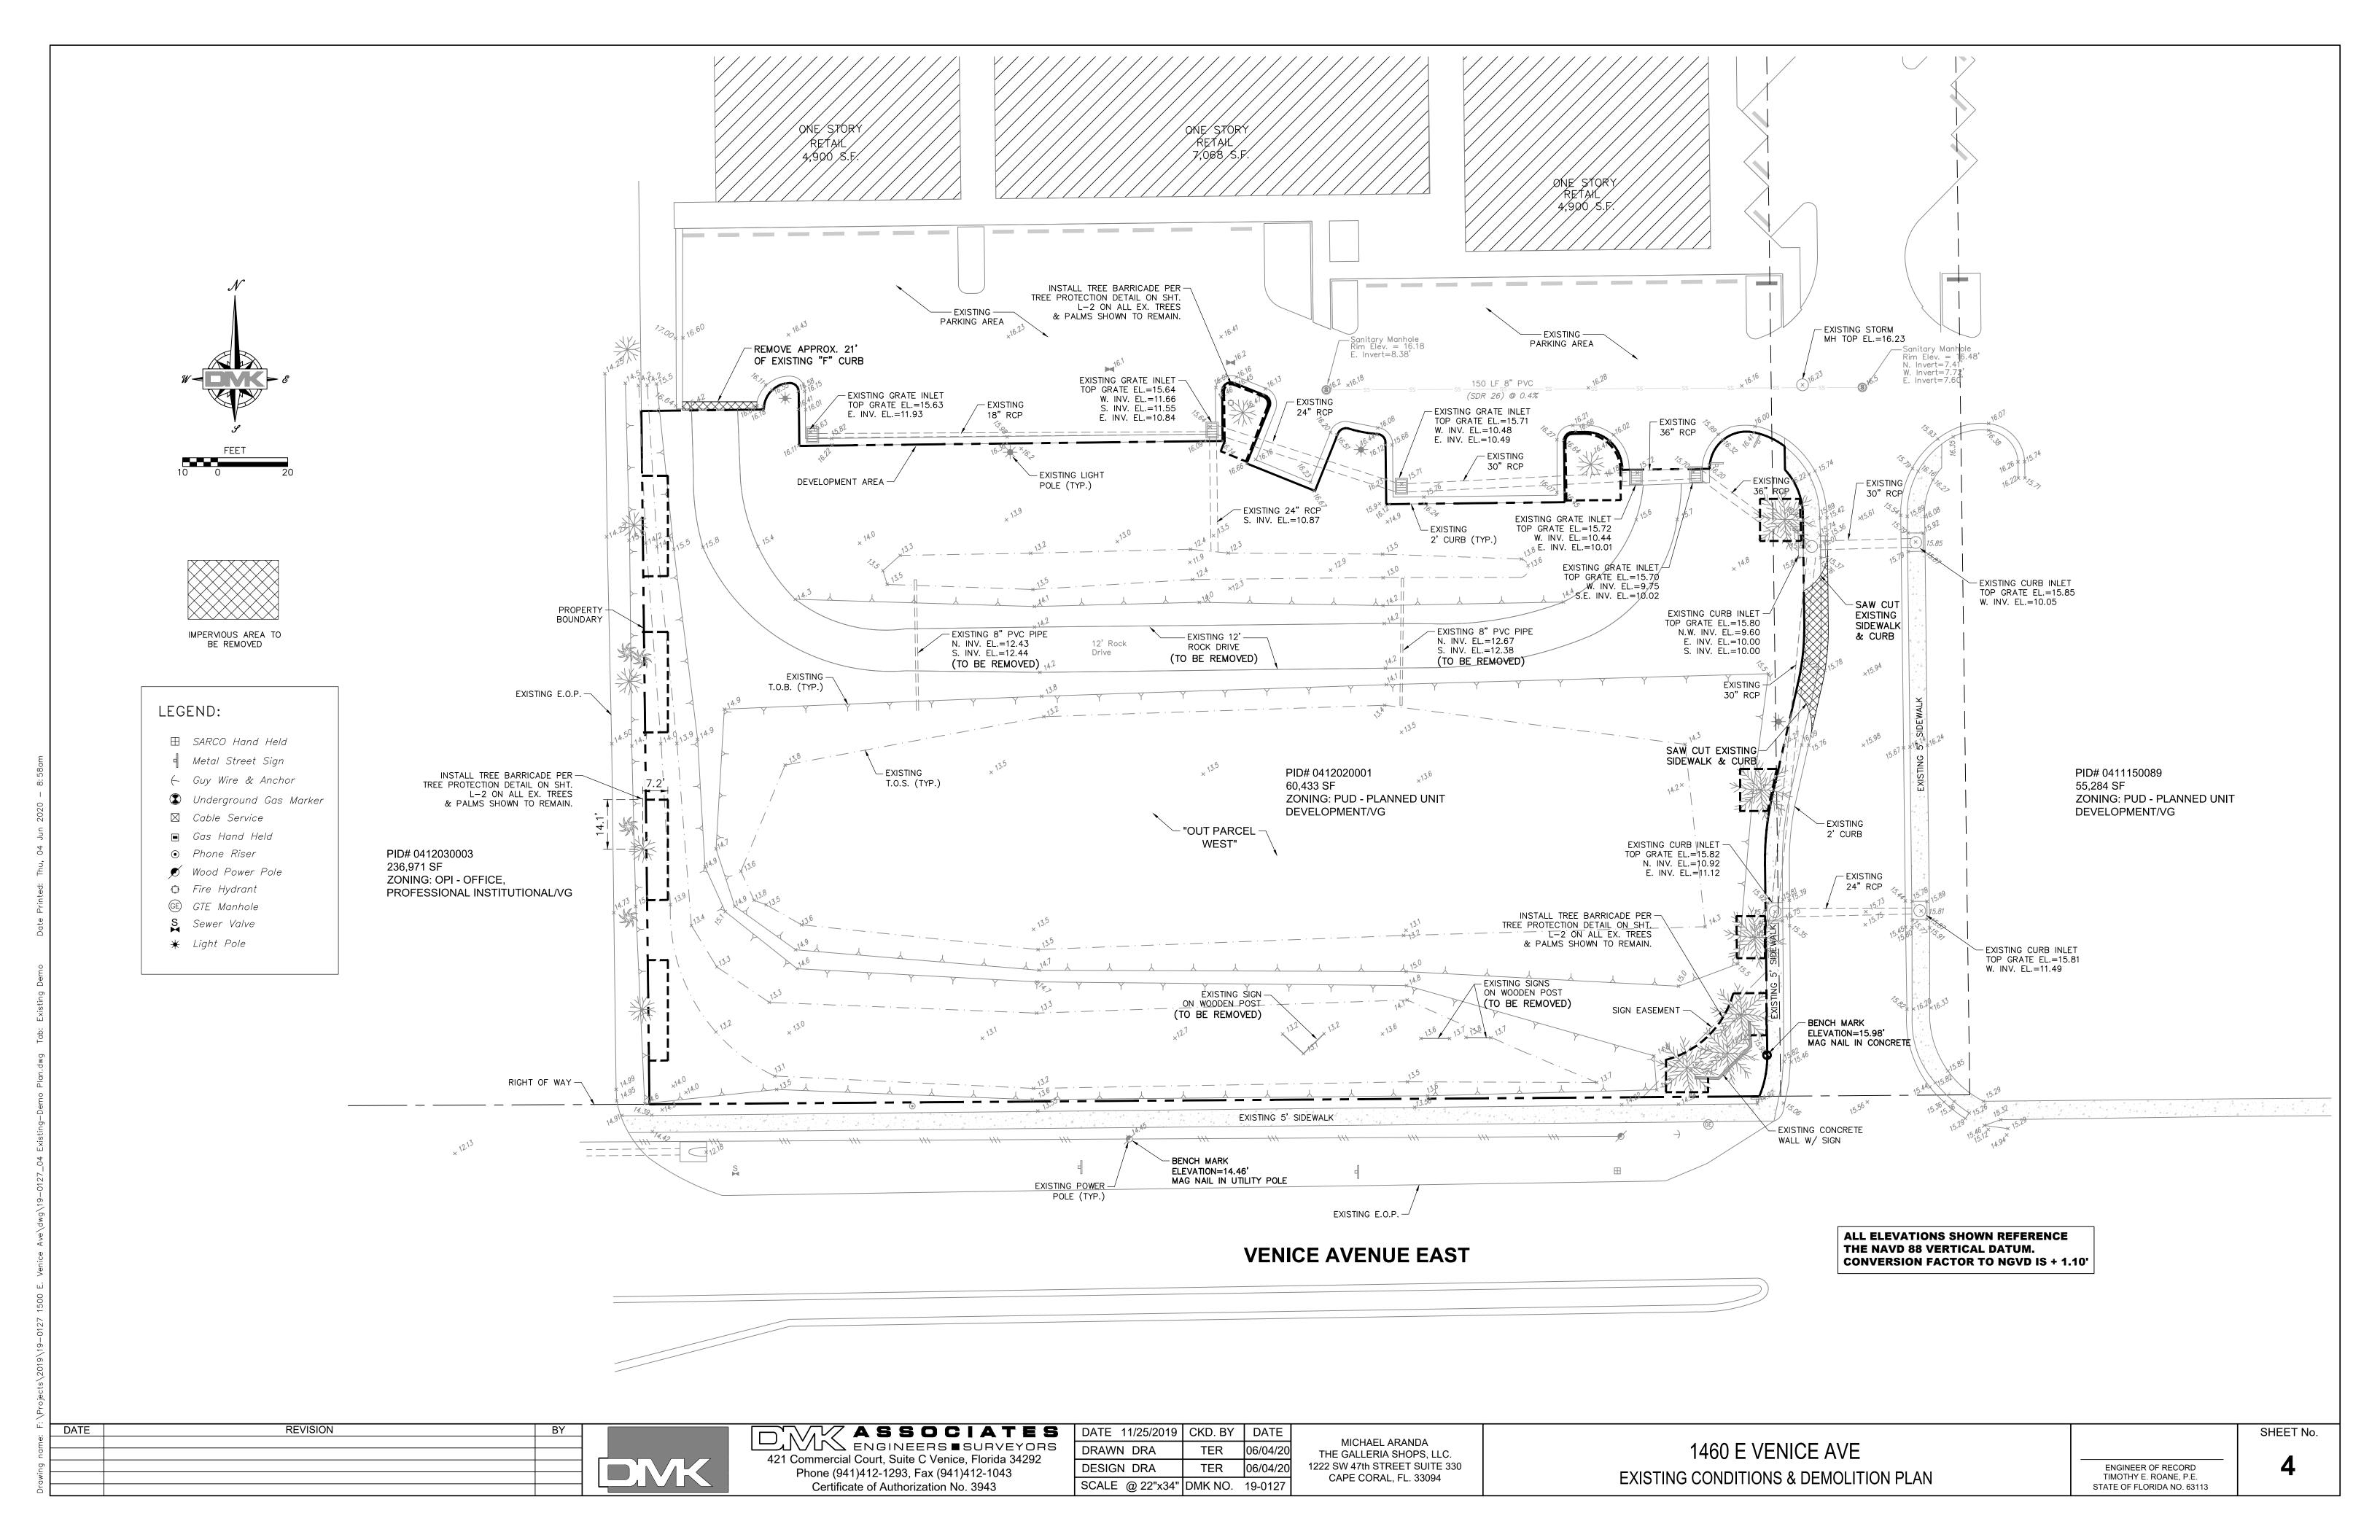

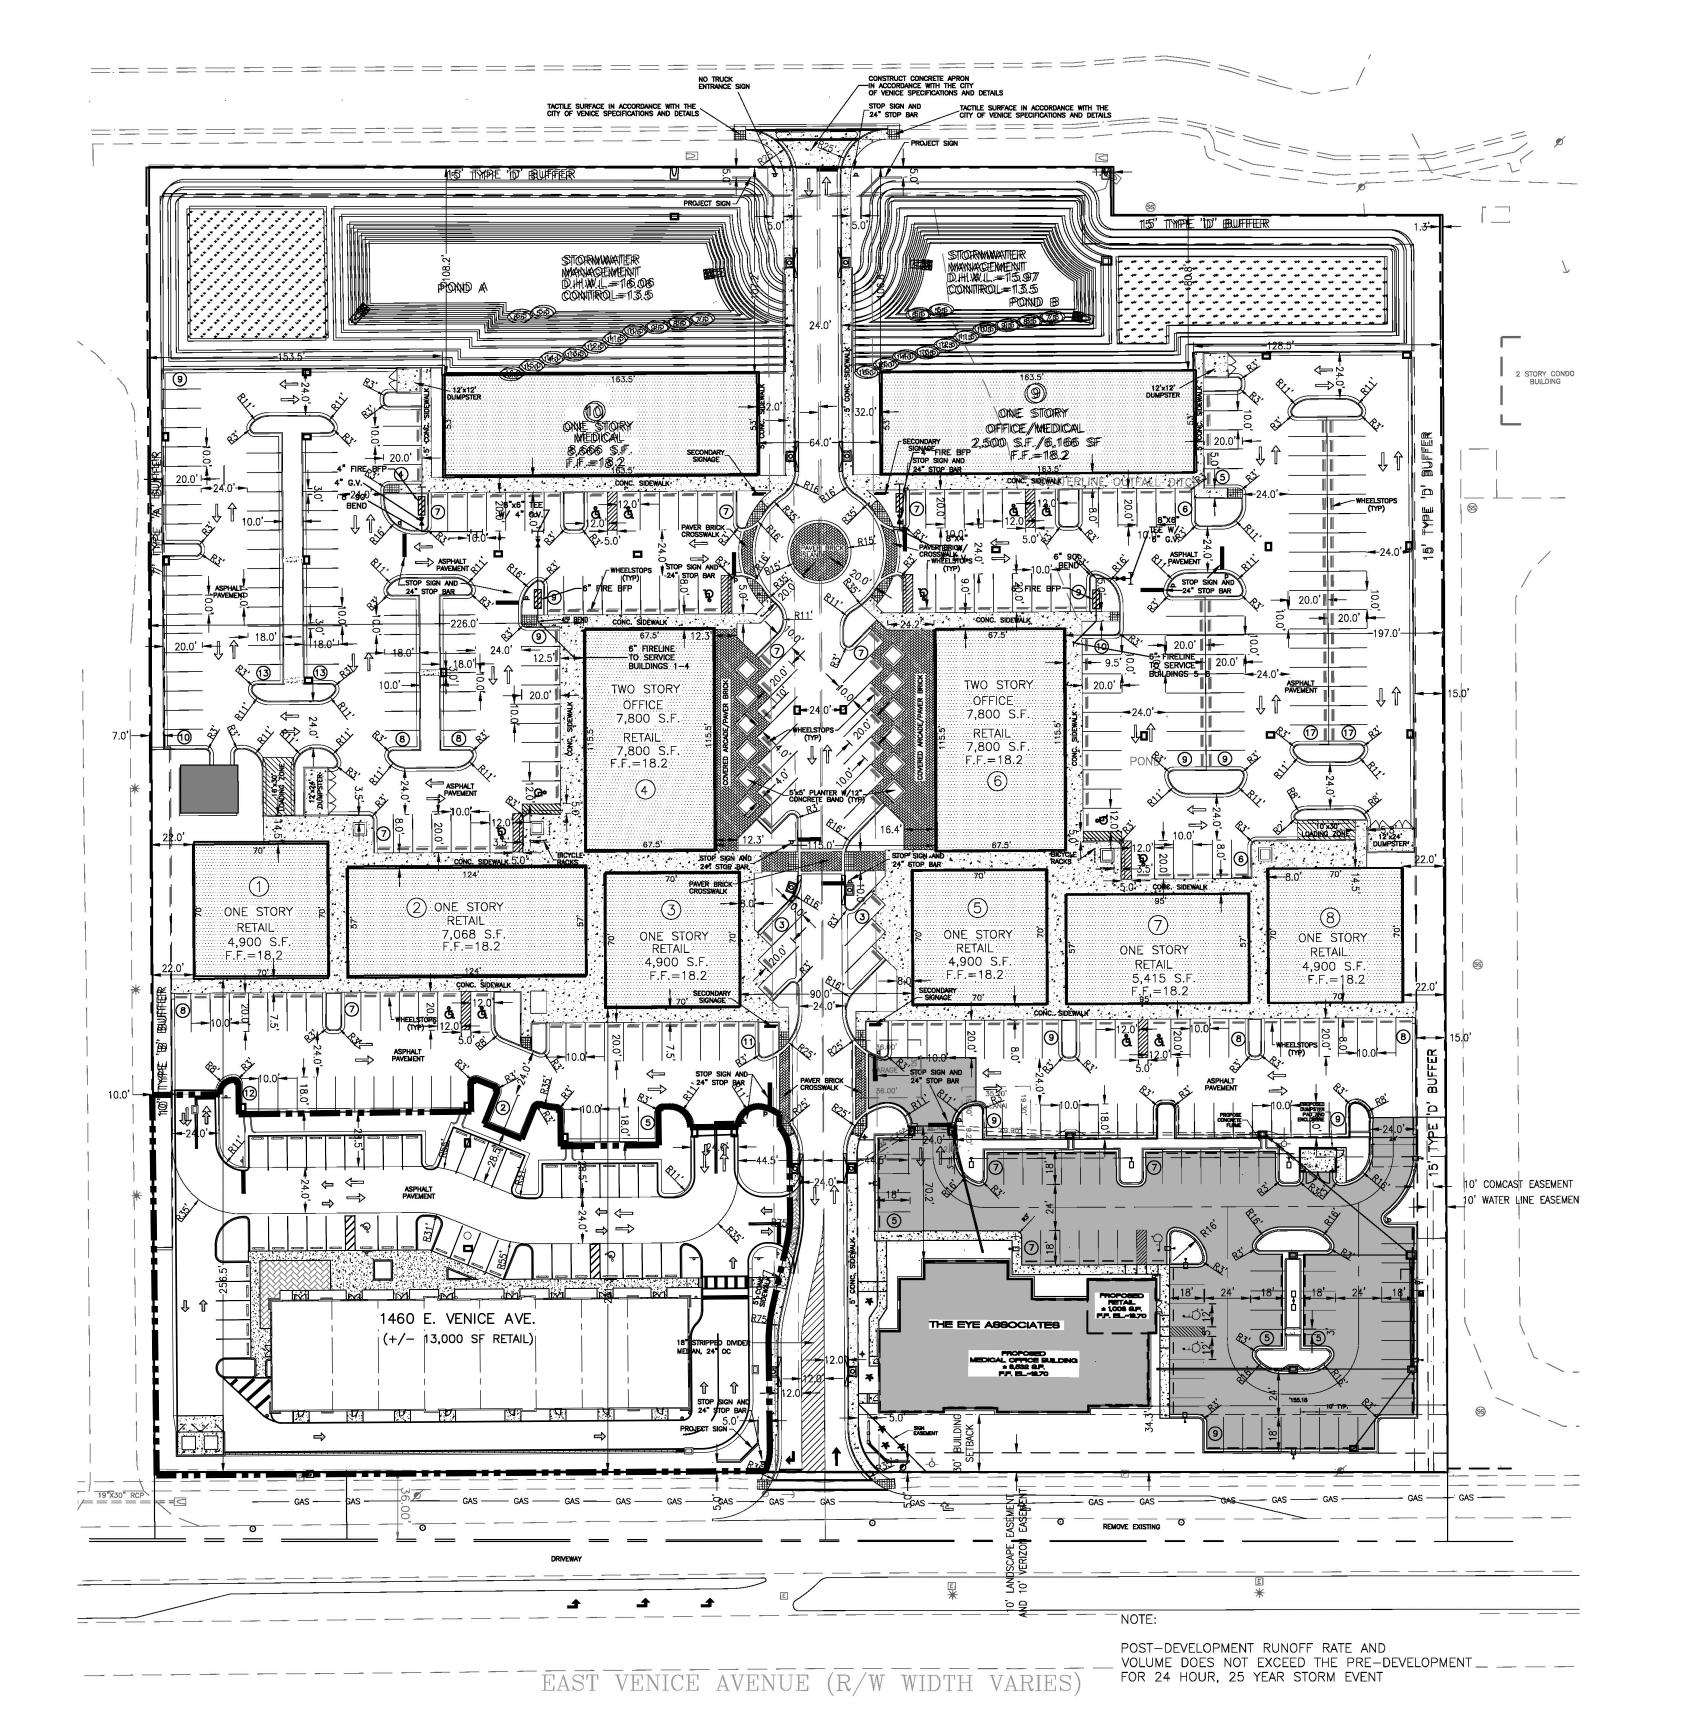

DENOTES CONCRETE WALKS/PATHS

DENOTES TACTILE SURFACE

DENOTES NO. OF PARKING SPACES

DENOTES HANDICAP PARKING

TRAFFIC CIRCULATION (NOT FOR PAINTING)


PAVEMENT MARKING (FOR PAINTING)

DENOTES EXISTING SANITARY SEWER MANHOLE

DENOTES EXISTING STORM DRAIN MANHOLE

C.T. CURB TAPER PER FDOT.

E.S. ELECTRICAL SERVICE

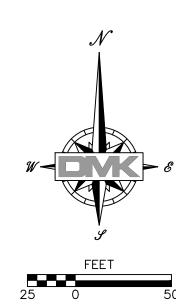

PERMITTED MASTER STORMWATER MANAGEMENT SYSTEM OPERATED AND MAINTAINED BY GALLERIA ON VENICE AVENUE MASTER ASSOCIATION, INC. 121 TRIPLE DIAMOND BOULEVARD, SUITE 8, N. VENICE, FL 34275

#### VENICE ZONING DESIGNATIONS

PROJECT ZONING: PLANNED UNIT DEVELOPMENT (PUD)/VENETIAN GATEWAY DISTRICT (VG)

#### <u>ADJACENT ZÓNING</u>

NORTH: PLANNED UNIT DEVELOPMENT (PUD) AND RESIDENTIAL MULTI-FAMILY (RMF-2)

SOUTH: RIGHT-OF-WAY, E VENICE AVE.

EAST: RESIDENTIAL MULTI-FAMILY (RMF-3)/VG

WEST: OFFICE, PROFESSIONAL AND INSTITUTIONAL (OPI)/VG

		SITE SUMMAR	Y				
SITE AREA	±452	,683.49 SF		±10.39 AC			
	AP	PROVED		PROPO	SED		
	AREA	PERCENTAGE	AREA	TOTAL	PERCENTAGE		
	(SF)		(SF)	AREA (SF)			
BUILDING COVERAGE	74,561	16.5%	13,000	87,561	19.3%		
ASPHALT/CONCRETE PAVEMENT	192,467	42.5%	26,262	218,729	48.3%		
CONCRETE SIDEWALKS	35,678	7.9%	3,372	39,050	8.6%		
TOTAL IMPERVIOUS	302,706	66.9%	42,634	345,340	76.3%		
STORMWATER	39,764	8.8%	0	39,764	8.8%		
LANDSCAPE AND OPEN SPACE	110,213	24.3%	13,483	67,579	14.9%		
TOTAL PERVIOUS	149,977	33.1%	13,483	107,343	23.7%		

\*THE PROPOSED ASPHALT/CONCRETE PAVEMENT AREA ABOVE DOES NOT INCLUI 4,315 SF OF EXISTING PAVEMENT AS IT HAS BEEN ACCOUNTED FOR IN THE APPROVED CALCULATIONS.

MINIMUM REQUIRED PARKING OVERALL SITE					
USE	RATIO	QTY	PARKING SPACES		
RETAIL	1/300 SF	61,335 SF	205		
OFFICE	1/200 SF	18,100 SF	91		
MEDIC AL	1/150 SF	23,364 SF	156		
		TO⊤AL	452 (9 H/C)		

\*ADJUSTED AMOUNT LESS THAN 15% INTERNAL CAPTURE/PEDESTRIAN/BICYCLE TRAFFIC - 68 SPACES = 384 SPACES

PROPOSED PARKING					
USE	RATIO	QTY	PARKING SPACES		
RETAIL	1/300 SF	12,644 SF	43 (2 H/C)		
	PARK	(ING PROVIDED			
PREVIOUSLY AP	PROVED	367 (17 H/C)	)		
PROPOSED		43 (2 H/C)	**		
TOTAL PARKING	SPACES	410 (19 H/C)	)		

NOTE: THIS SITE AND DEVELOPMENT PLAN AMENDMENT DOES NOT AUTHORIZE DEVELOPMENT OUTSIDE THE LIMITS OF DEVELOPMENT AS DEPICTED ON THE SITE DEVELOPMENT PLAN SHEET.

DATE REVISION BY



ASSOCIATES
ENGINEERS SURVEYORS
421 Commercial Court, Suite C Venice, Florida 34292
Phone (941)412-1293, Fax (941)412-1043
Certificate of Authorization No. 3943

 DATE
 11/25/2019
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 06/04/20


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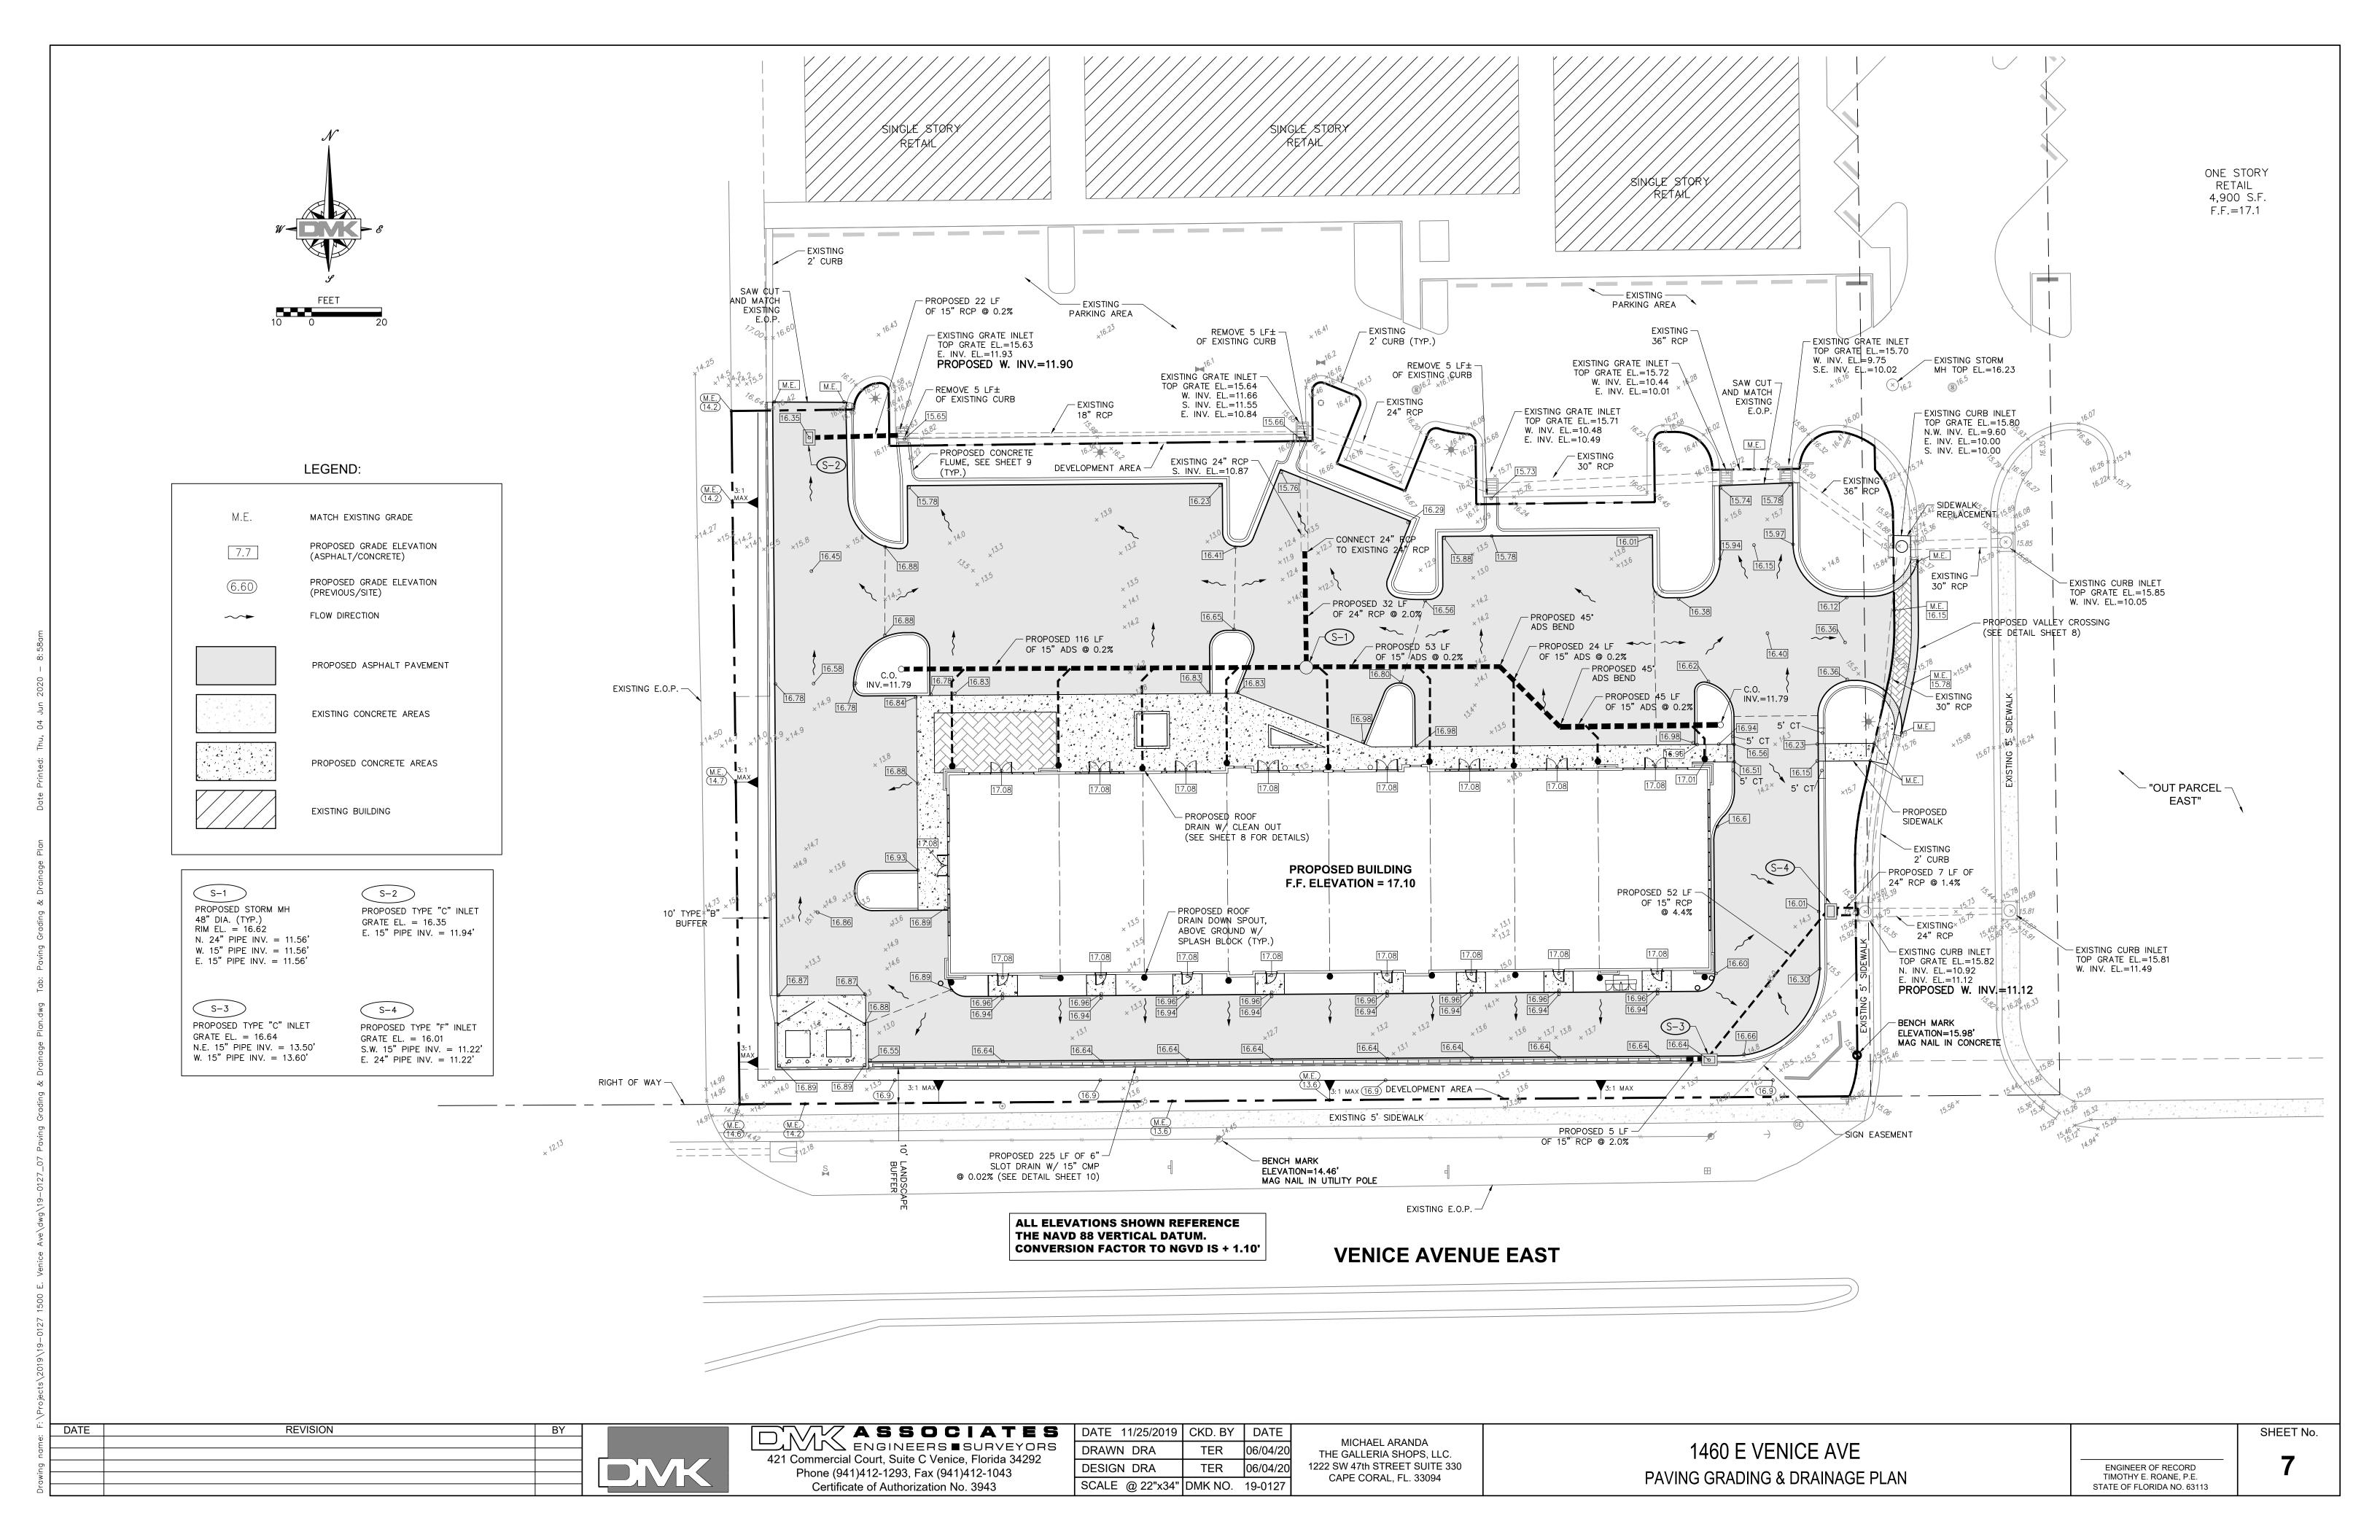
 SCALE @ 22"x34"
 DMK NO.
 19-0127


MICHAEL ARANDA THE GALLERIA SHOPS, LLC. 1222 SW 47th STREET SUITE 330 CAPE CORAL, FL. 33094

1460 E VENICE AVE MASTER SITE PLAN

ENGINEER OF RECORD TIMOTHY E. ROANE, P.E. STATE OF FLORIDA NO. 63113



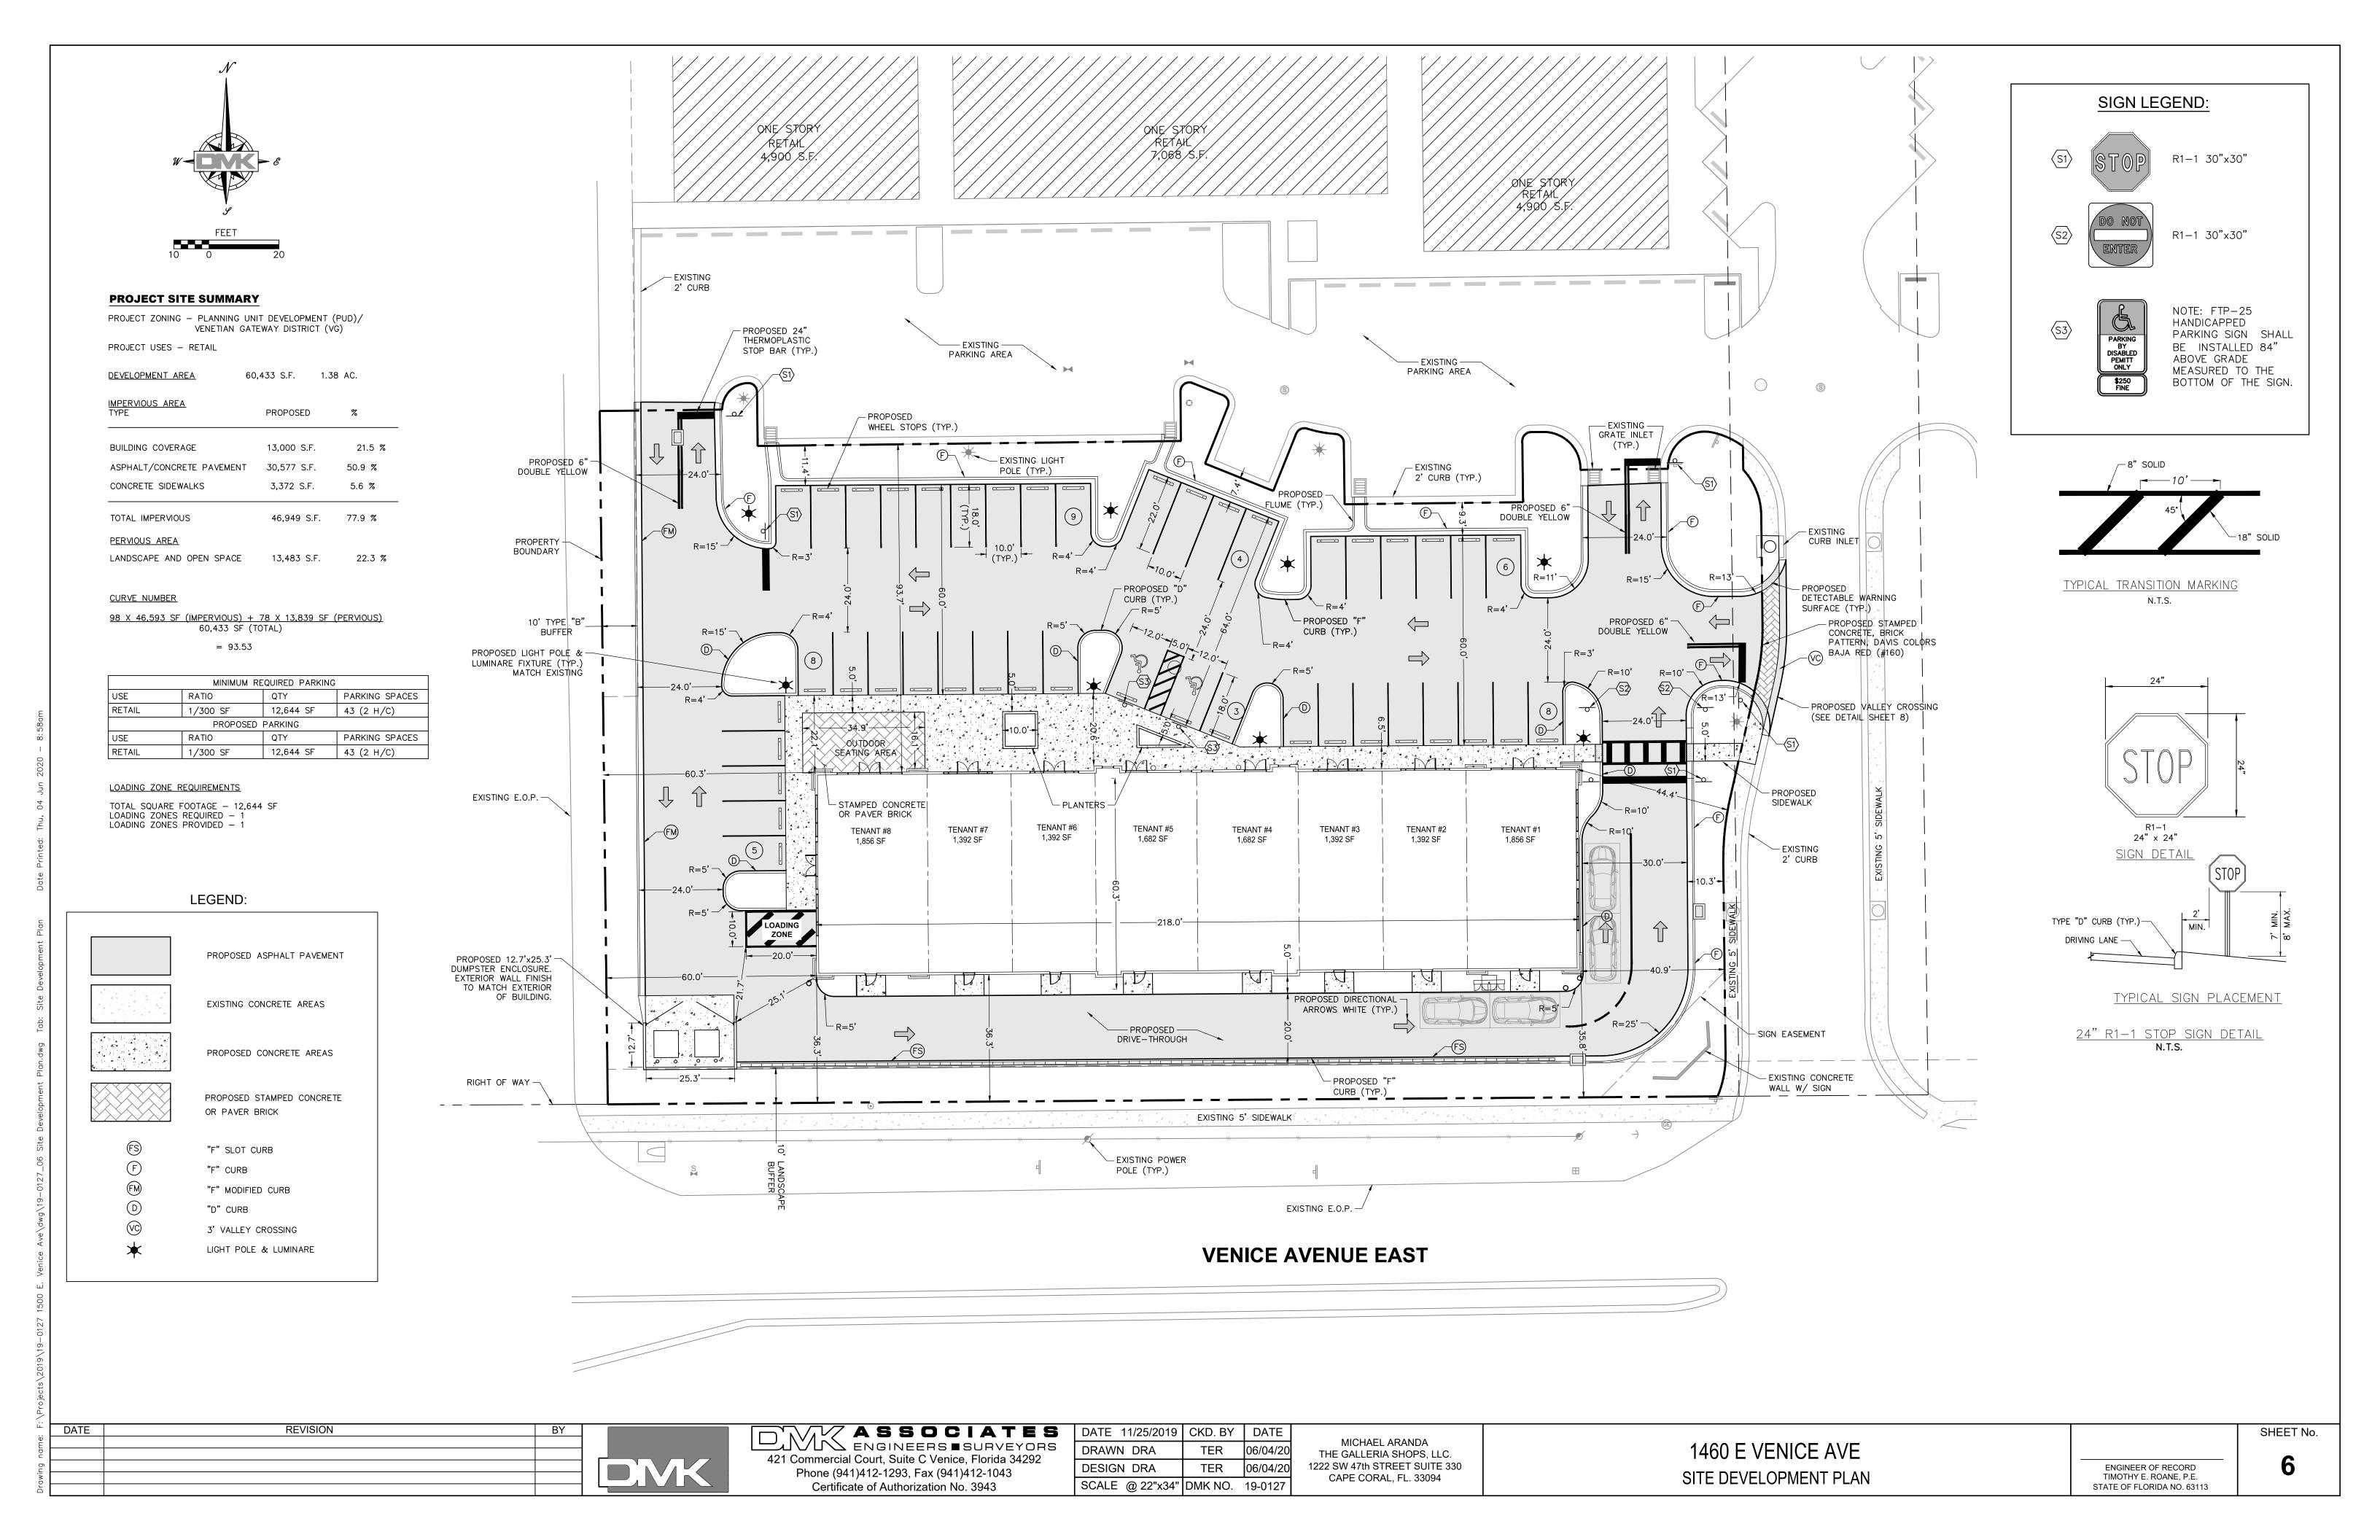

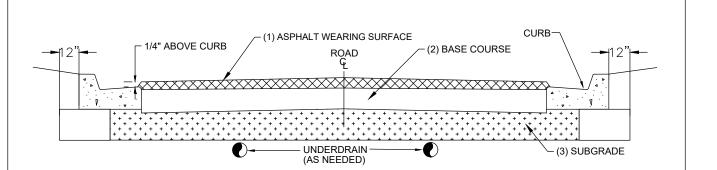

#### **ROADWAY SECTION DESIGN (MINIMUM THICKNESS)**

STREET OF ASSISTANTION	(1) ASPHALT SURFACE:	(2)	BASE	:	(3) SUB-GRADE:	
STREET CLASSIFICATION	(I) ASPHALI SURFACE.	B-12.5	СТВ	CCA	TYPE B STAB.	
RESIDENTIAL STREET (PRIVATE) & LIGHT DUTY PARKING	2" TYPE SP-9.5 (INSTALLED AS TWO 1" LIFTS)	4"	8"	8"	8" MIN 40 LBR	
RESIDENTIAL STREET (PUBLIC)	2" TYPE SP-9.5 (INSTALLED AS TWO 1" LIFTS)	5"	10"	10"	12" MIN 40 LBR	
INDUSTRIAL STREET (PUBLIC/PRIVATE)	2" TYPE SP-12.5 & 1" TYPE FC-9.5	5"	10"	10"	12" MIN 40 LBR	
COLLECTOR / ARTERIAL STREET	3" TYPE SP-12.5 & 1" TYPE FC-9.5	5"	10"	10"	12" MIN 40 LBR	

- 1.) ALL STREETS WITHIN THE CITY LIMITS SHALL MEET THE MINIMUM DESIGN STANDARDS AS ESTABLISHED IN THIS DETAIL. 2.) ALL INSTALLATION METHODS AND MATERIALS SHALL CONFORM WITH THE LATEST EDITION OF THE FDOT STANDARD
- SPECIFICATIONS FOR ROAD AND BRIDGE CONSTRUCTION.
- 3.) CRUSHED CONCRETE AGGREGATE (CCA) MUST HAVE AN LBR ≥150. SHELL IS NOT AN ACCEPTABLE BASE MATERIAL. 4.) CEMENT TREATED BASE:
- a.) THE MATERIAL TO BE USED AS THE FILLER AGGREGATE IN CTB MUST BE LBR TESTED PRIOR TO DESIGN FORMULATION (ADDING CEMENT). THIS MATERIAL MUST ACHIEVE AN LBR VALUE OF ≥ 100. b.) CTB DESIGN CRITERION SHOULD TARGET RANGE FROM 175 TO 275 PSI ON 7 DAY BREAK. TESTING MUST BE
- PROVIDED TO VERIFY THE COMPRESSIVE STRENGTH OF THE MIX. 5.) ALL GRANULAR COURSES OF ROAD CONSTRUCTION MUST BE COMPACTED TO 98% OF ITS OPTIMUM DENSITY AS PER T-180 (AASHTO). CTB SHALL BE COMPACTED TO 98% OF ITS LAB FORMULATION DENSITY (AASHTO T-99).
- 6.) ALL MINERAL MATERIALS USED IN CONSTRUCTION OF ROADWAYS MUST MEET THE FOLLOWING CRITERIA:
- a.) FINES (PASSING # 200 SIEVE) MUST BE LIMITED TO ≤ 12%, ORGANICS LIMITED TO ≤ 5%, NO DELETERIOUS MATERIALS. 7.) SIGNAGE AND PAVEMENT MARKINGS SHALL BE IN ACCORDANCE WITH LATEST EDITION OF THE FDOT ROADWAY AND TRAFFIC DESIGN STANDARDS AND THE MANUAL ON UNIFORM TRAFFIC CONTROL DEVICES (MUTCD MANUAL).
- 8.) ALL CITY STREET SIGNS WILL BE BLUE BACKGROUND WITH 6" WHITE LETTERS AND CONSTRUCTED WITH HIGH INTENSITY REFLECTORIZED MATERIAL. ALL STREET SIGNS SHALL BE 9 INCHES WIDE AND APPROVED BY THE DIRECTOR OF PUBLIC WORKS PRIOR TO INSTALLATION.
- 9.) ALL CURB PADS SHALL MEET THE SAME STRUCTURAL AND COMPACTION STANDARDS AS ROAD SUB GRADE. THESE PADS WILL EXTEND TO AT LEAST 12" BEYOND THE CURB.
- 10.) UNDERDRAINS OR SIDEDRAINS MAY BE INCLUDED WHEN THE GROUND WATER LEVELS MAY AFFECT THE STRUCTURAL INTEGRITY OF THE ROAD. THIS DESIGN SHALL BE THE RESPONSIBILITY OF ENGINEER OF RECORD.
- 11.) ANY PROPOSED TRAFFIC CALMING DEVICES MUST BE APPROVED BY THE CITY ENGINEER & FIRE CHIEF. 12.) ASPHALT COURSES AND CONCRETE SHALL NOT BE PLACED WHILE RAIN IS FALLING, OR WHEN THERE IS STANDING WATER ON THE SURFACE TO BE COVERED.
- 13.) TACK COAT SHALL BE APPLIED BETWEEN ALL ASPHALT LAYERS.

#### TYPICAL ROADWAY SECTION





SECTION

TYPICAL ROADWAY

DATE **ENGINEERING** MAY 2020 SHEET NO. ENG-3

N.T.S.

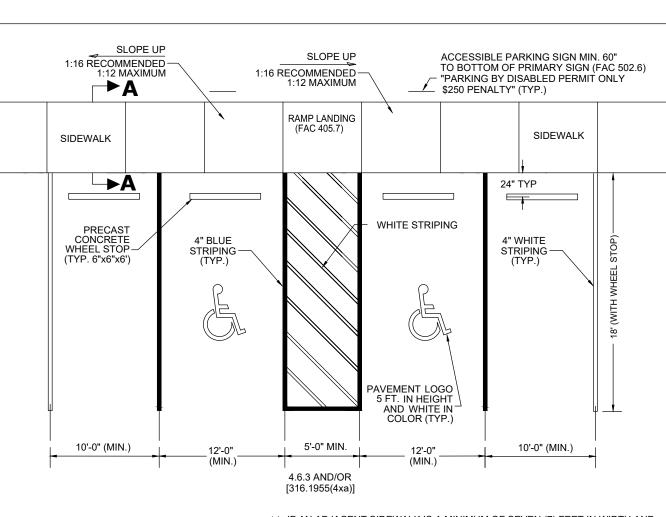

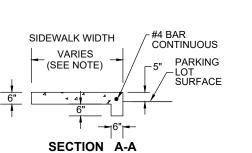

1.) IF AN ADJACENT SIDEWALK IS A MINIMUM OF SEVEN (7) FEET IN WIDTH AND PROVIDES A 5" INCH CURB, THE SIDEWALK MAY SERVE AS THE WHEEL STOP

AND THE STANDARD PARKING SPACE MAY BE 16' DEEP. 2.) IF AN ADJACENT LANDSCAPE AREA IS A MINIMUM OF 3.5' PER ABUTTING PARKING SPACE AND PROTECTED BY CONCRETE CURBING OR WHEEL STOP, 2 FEET OF THE REQUIRED DEPTH MAY ENCROACH INTO THE LANDSCAPE AREA. IF THE REQUIRED DEPTH ENCROACHES INTO THE LANDSCAPE AREA. THE WHEEL STOP MUST BE PLACED AT THE EDGE OF

3.) ACCESSIBLE PARKING SPACES AND ACCESS AISLES SHALL BE CONSTRUCTED WITH SURFACE SLOPES NOT TO EXCEED 1:50 (2%) IN ALL DIRECTIONS AND THE GROUND SURFACE SHALL BE STABLE, FIRM AND

4.) NO COLORS OTHER THAN WHITE AND BLUE SHALL BE USED FOR PARKING SPACE PAVEMENT MARKINGS. 5.) ALL DIMENSIONS SHOWN ARE TO THE CENTERLINE OF PAVEMENT

#### ACCESSIBLE & TYPICAL PARKING SPACE DETAIL

REVISION

E

DATE

CITY OF VENICE NGINEERING DEPARTMENT 401 WEST VENICE AVE. VENICE FL 34285 (941) 486-2626 FAX (941) 480-3031

**ENGINEERING** ACCESSIBLE &

TYPICAL PARKING

MAY 2020 SHEET NO. ENG-5

CITY OF VENICE ENGINEERING DEPARTMENT 401 WEST VENICE AVE. VENICE FL 34285 (941) 486-2626 FAX (941) 480-3031

COMPLIANT AND SHALL BE BRICK RED IN COLOR.

INJECTION MOLDED FITTING ARE

WATERTIGHT (WT) JOINTS SHOWN.

FIÍTINGS ARE ALSO AVAILABLE.

BELL/BELL COUPLERS.

IN TEES, WYES, REDUCERS, 45° BENDS

NYLOPLAST CLEANOUT END CAP -

ADJUST GRADE PER ENGINEERS

INJECTION MOLDED -

- INJECTION MOLDED

/ANCED DRAINAGE SYSTEMS, INC. ("ADS") HAS PREPARED THIS DETAIL BASED ON INFORMATION PROVIDED TO ADS. THIS WING IS INTENDED TO DEPICT THE COMPONENTS AS REQUESTED. ADS HAS NOT PERFORMED ANY ENGINEERING OR DESIGN

RAWING IS INTENDED TO DEPICT THE COMPONENTS AS REQUESTED. ADS HAS NOT PERFORMED ANY ENGINEERING OR DESIGN ERVICES FOR THIS PROJECT, NOR HAS ADS INDEPENDENTLY VERIFIED THE INFORMATION SUPPLIED. THE INSTALLATION DETAILS ROVIDED HEREIN ARE GENERAL RECOMMENDATIONS AND ARE NOT SPECIFIC FOR THIS PROJECT. THE DESIGN ENGINEER SHALL EVIEW THESE DETAILS PRIOR TO CONSTRUCTION. IT IS THE DESIGN ENGINEERS RESPONSIBILITY TO ENSURE THE DETAILS ROVIDED HEREIN MEETS OR EXCEEDS THE APPLICABLE NATIONAL, STATE, OR LOCAL REQUIREMENTS AND TO ENSURE THAT THE ETAILS PROVIDED HEREIN ARE ACCEPTABLE FOR THIS PROJECT.

 $\triangleleft \quad \triangleleft \quad \nabla$ 

EXISTING OR NEW SIDEWALK

TRANSITION -

FLOW LINE FOR

1.) ALL STREETS SHALL HAVE A TWO-FOOT WIDE CONCRETE (3000 PSI AT 28 DAYS WITH FIBER REINFORCEMENT) CURB AND GUTTER,

**CURB DETAIL** 

AND MEET OR EXCEED FDOT SPECIFICATIONS UNLESS OTHERWISE APPROVED BY THE CITY ENGINEER

1.) ALL CONCRETE RAMPS SHALL BE 4" THICK, INCREASING TO 6" THICK WITHIN 48" OF THE CURB

2.) ALL CONNECTIONS TO AN EXISTING SIDEWALK SHALL BE AT AN EXPANSION OR CONTRACTION JOINT

3.) THE MAXIMUM RAMP SLOPE SHALL BE 1:12, FOR A VERTICAL DISTANCE OF NOT MORE THAN 6 INCHES.

4.) THE MAXIMUM RUNNING SIDEWALK SLOPE SHALL BE 1:20, AND MAXIMUM CROSS SLOPE SHALL BE 2%.

5.) ALL SIDEWALK RAMPS AND STREET CONNECTIONS WITHIN THE PUBLIC ROW SHALL HAVE A TACTILE SURFACE.

6.) TACTILE SURFACES SHALL MEET THE MOST CURRENT AMERICANS WITH DISABILITIES ACT STANDARDS, BE FDOT

7.) ALL MATERIALS & METHODS OF CONSTRUCTION SHALL BE IN ACCORDANCE WITH LATEST EDITION OF THE FDOT, "STANDARDS FOR ROAD & BRIDGE CONSTRUCTION". IN ADDITION, CONCRETE SHALL BE 3000 PSI AT 28 DAYS WITH A MAXIMUM 4" SLUMP AND FIBER REINFORCEMENT.

SIDEWALK RAMP DETAIL

AVAILABLE

SOIL-TIGHT (ST)

FINISHED GRADE

INSERT INJECTION MOLDED, -

GASKETED SPIGOT BY

BELL REDUCER

**ENGINEERING** SIDEWALK RAMPS & CURBING

ALL ELEVATIONS ARE RELATIVE TO THIS

POINT BEING 0.0"

SHEET NO. ENG-1

MAY 2020

DOWNSPOUT ADAPTER -

INSERTED IN RISER

PIPE

INJECTION -

MOLDED WT

90° BEND

UPDATED DRAWING

N.T.S.

FOR USE WITH TYPE F CURB

VARIES 5' MINIMUM

6" THICK, 3000 PSI AT 28

DAYS CONCRETE WITH FIBER REINFORCEMENT

 $\nabla \mid$  asphalt

(SECTION A-A)

(SECTION B-B)

DIA. DET/RET SYSTEM

ROOF DRAIN W/TEE

CLEANOUT


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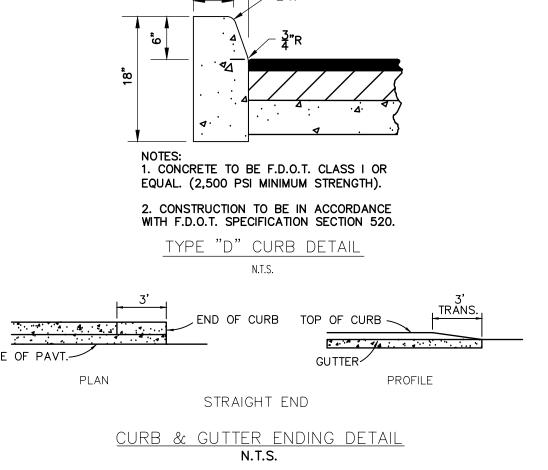
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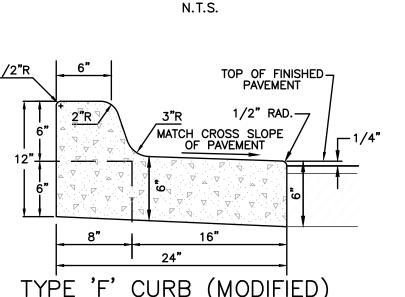
GASKETED

CONNECTION

- HDPE PIPE (TYP)





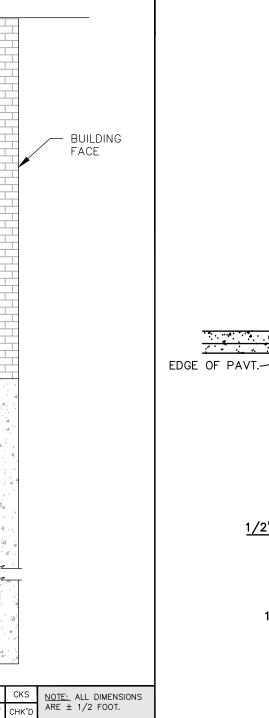

1. CONCRETE SHALL HAVE A COMPRESSIVE STRENGTH OF 3000 PSI IN 28 DAYS UNLESS NOTED OTHERWISE. 2. AN EXPANSION JOINT WILL BE PLACED AT THE END OF ALL RETURNS AT INTERVALS NOT TO EXCEED 50' WITH THE CONTRACTION JOINTS AT 10' INTERVALS BETWEEN. 3. EXPANSION JOINTS SHALL BE CONSTRUCTED WITH 1/2" BITUMINOUS IMPREGNATED EXPANSION JOINT MAT'L.


TOP OF FINISHED-

24"

TYPE 'F' CURB

N.T.S.

**PAVEMENT** 

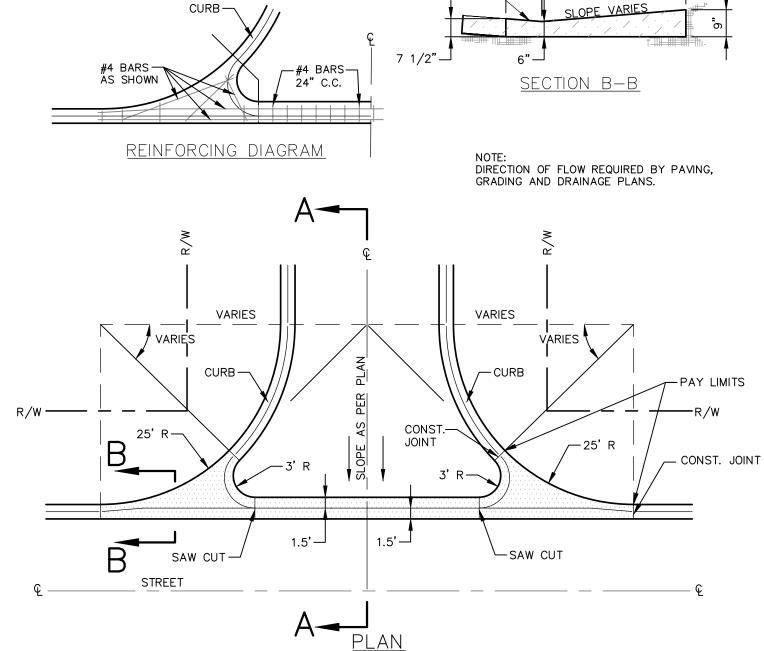

SECTION A-A

VARIES

SLOPE 1":1'-

MEET GRADE AS-

SHOWN ON PLAN

**VARIES** 


**VARIES** 

SLOPE 1":1'-


REINFORCING BARS TO BE PLACED A MINIMUM OF

GUTTER. CONCRETE 3000 P.S.I., "A" GRADE.

2" FROM BOTTOM AND 3" FROM SIDES OF CURB &

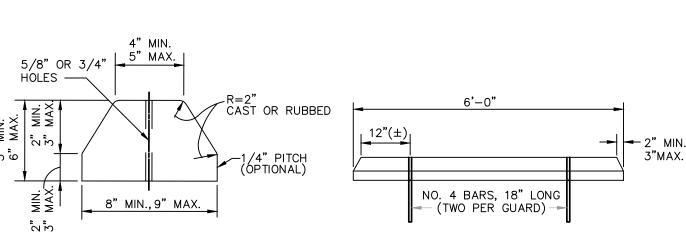

NOTE: CONCRETE TO BE 2,500 PSI STRENGTH MINIMUM.

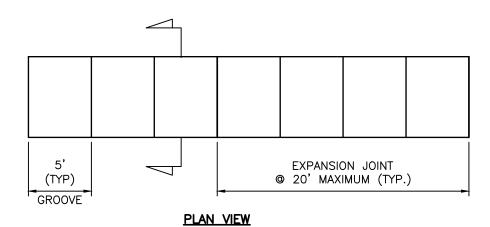

2,500 PSI CONCRETE SIDEWALK | ASPHALT PAVEMENT

CONCRETE SIDEWALK TO ASPHALT SECTION


(FLUSH CONNECTION)

N.T.S.

SLOPE IS 1.5% TO 2% MAX.

12" THICK SUBGRADE COMPACTED TO 98%

AASHTO T-180)

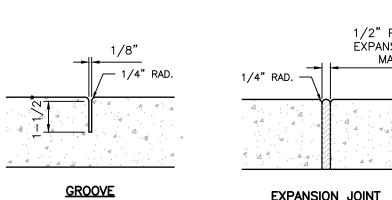

SIDEWALK DETAIL

N.T.S.

1/2" PREMOLDED **EXPANSION JOINT** MATERIAL **EXPANSION JOINT** 

ROOF DRAIN SPLASH BLOCK

> ROOF DRAIN WITH SPLASH BLOCK N.T.S.

ASSOCIATES ENGINEERS SURVEYORS 421 Commercial Court, Suite C Venice, Florida 34292 Phone (941)412-1293, Fax (941)412-1043 Certificate of Authorization No. 3943


DATE 11/25/2019 CKD. BY DRAWN DRA TER 06/04/20 DESIGN DRA TER 06/04/20 SCALE @ 22"x34" DMK NO. 19-0127


MICHAEL ARANDA THE GALLERIA SHOPS, LLC. 1222 SW 47th STREET SUITE 330 CAPE CORAL, FL. 33094


1460 E VENICE AVE PAVING GRADING & DRAINAGE DETAILS

ENGINEER OF RECORD TIMOTHY E. ROANE, P.E. STATE OF FLORIDA NO. 63113


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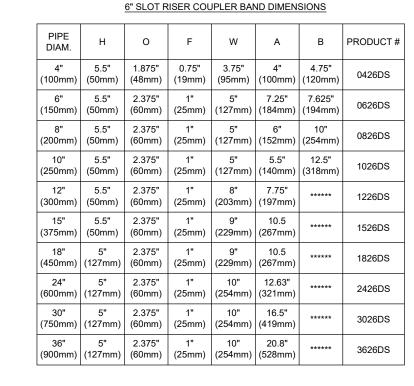
DRAWING NUMBER: STD-1407

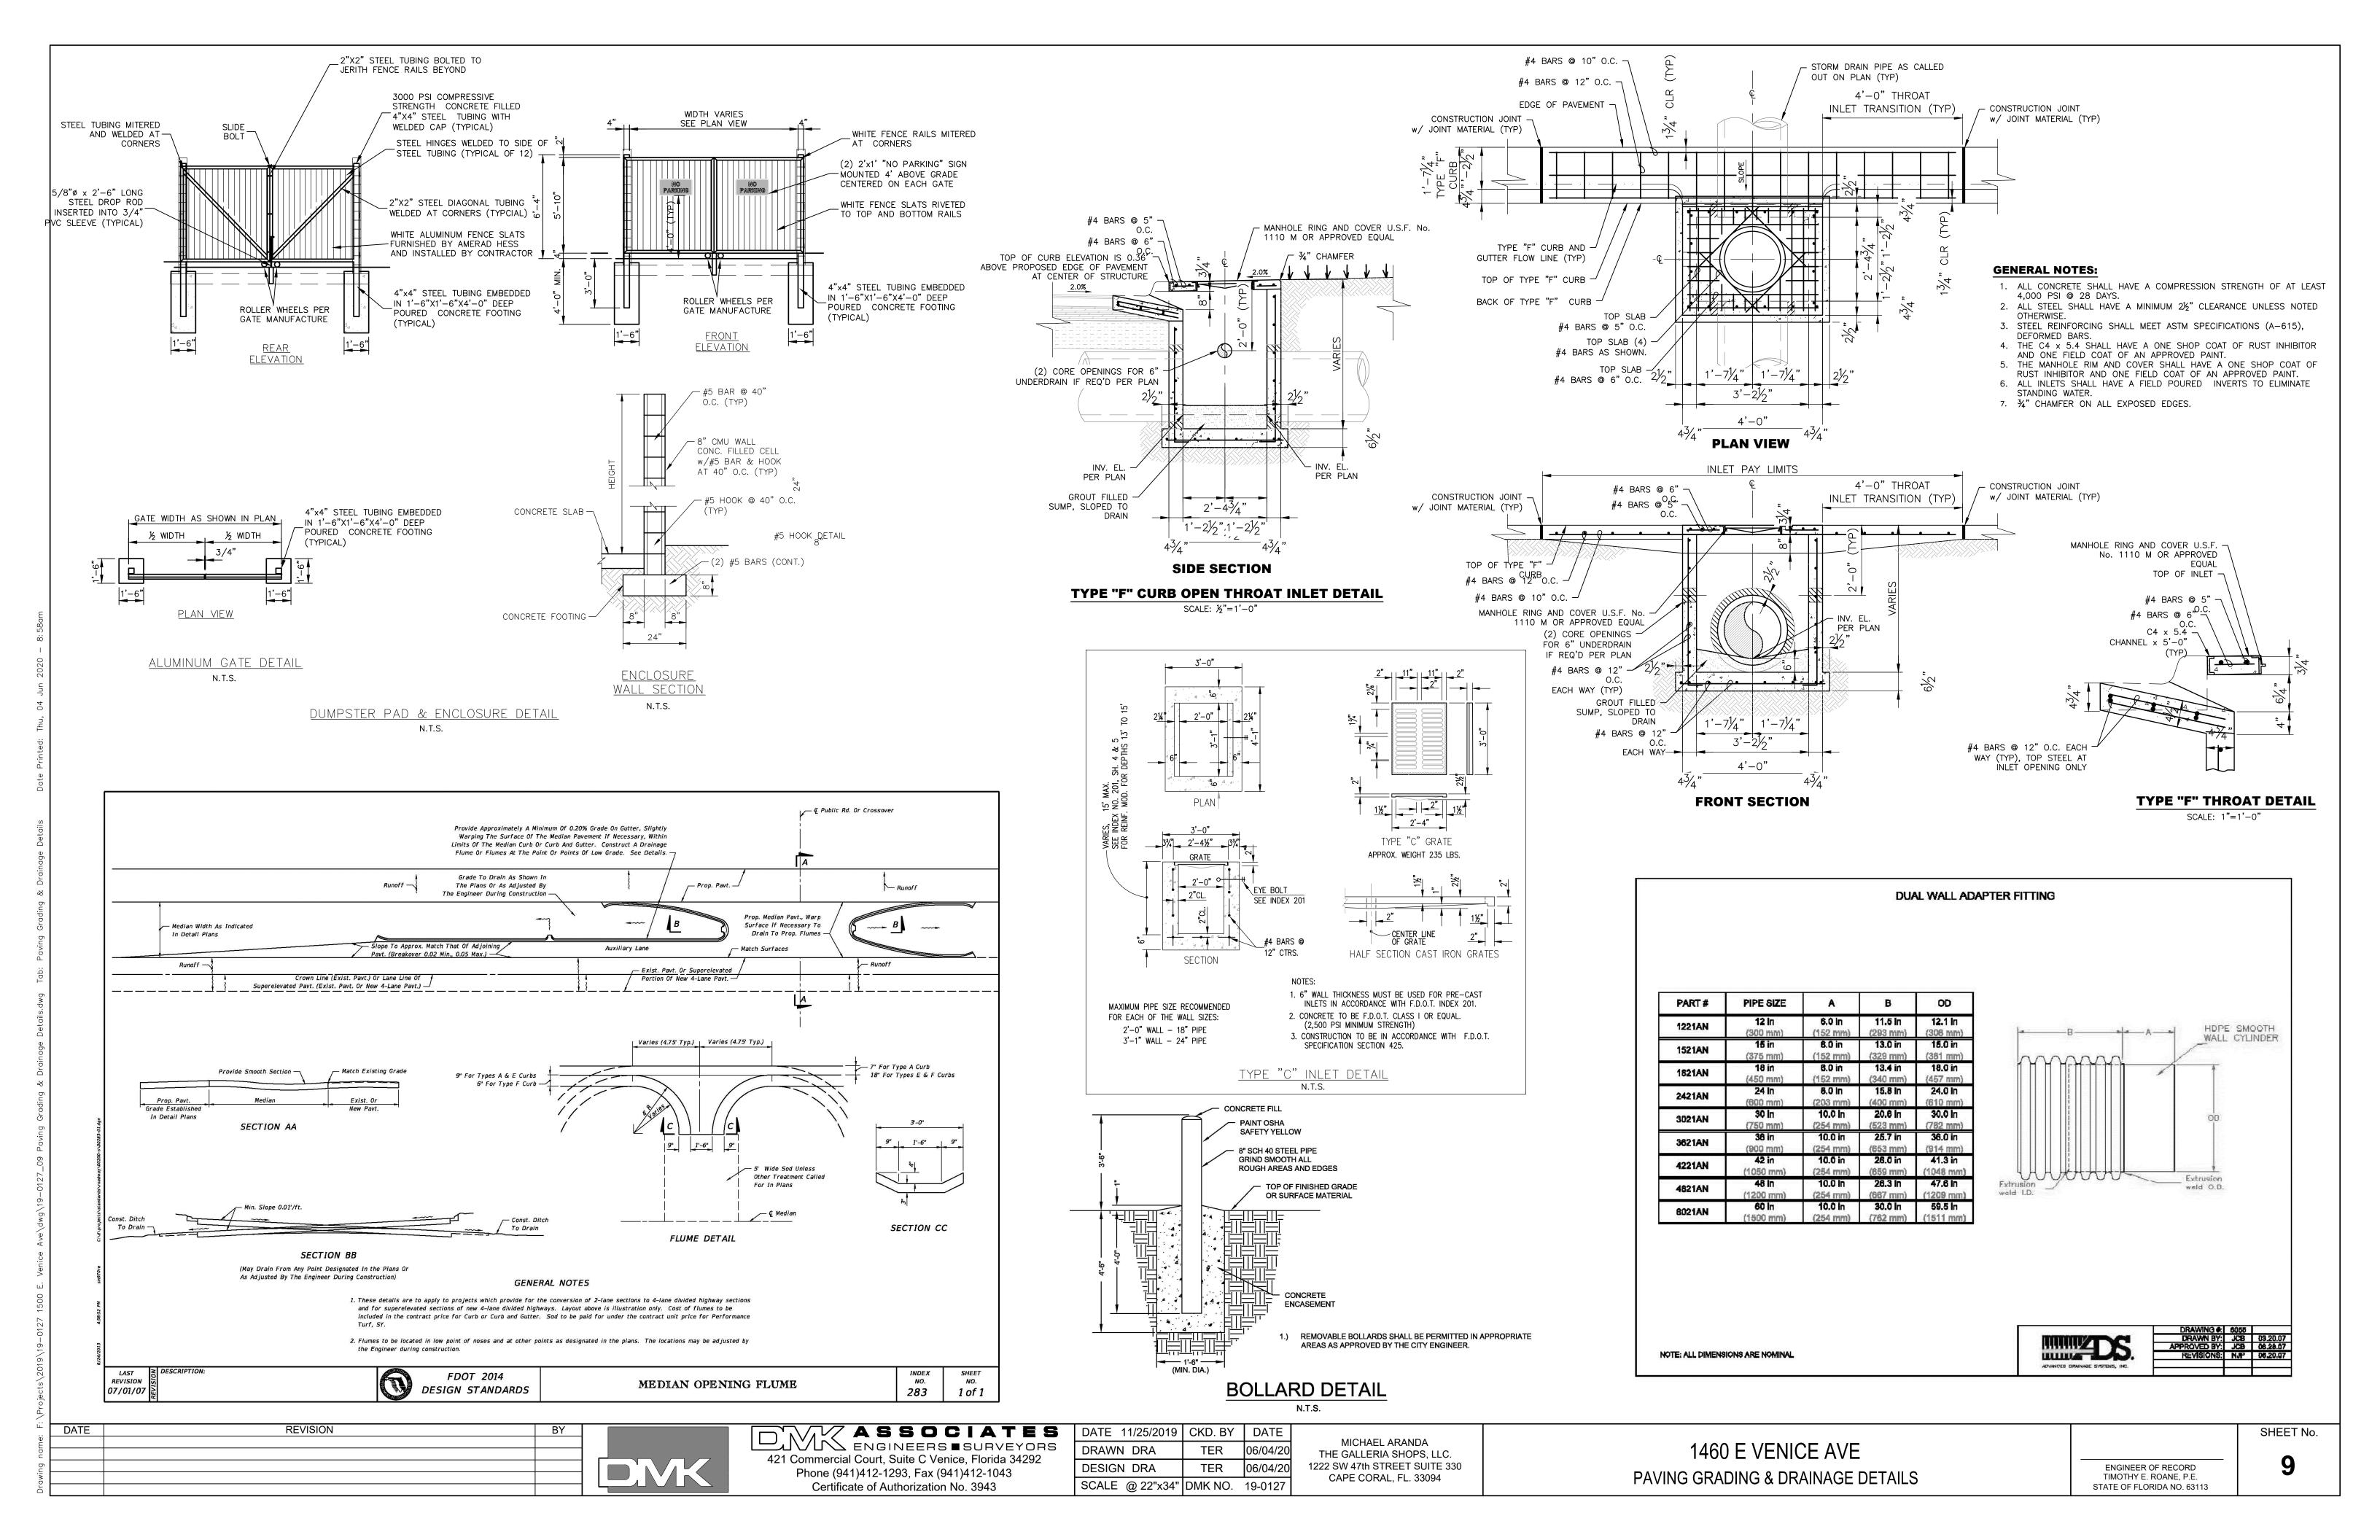

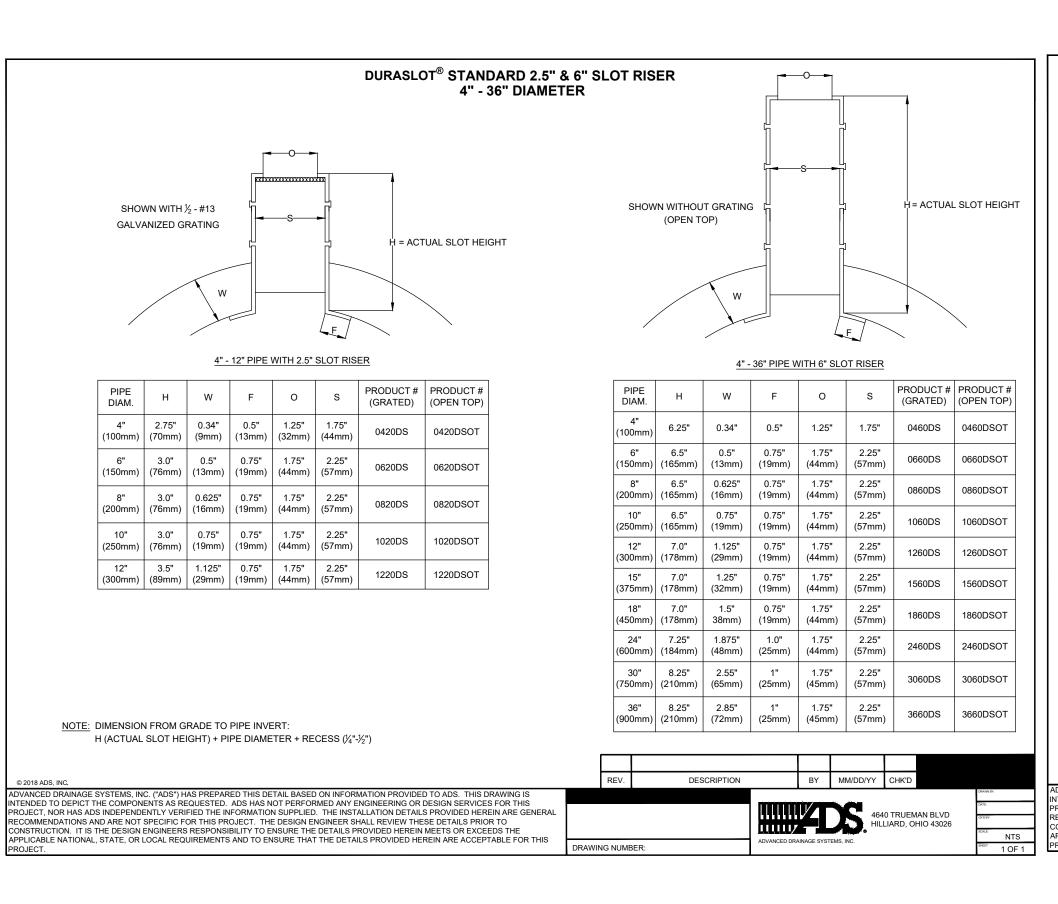END VIEW

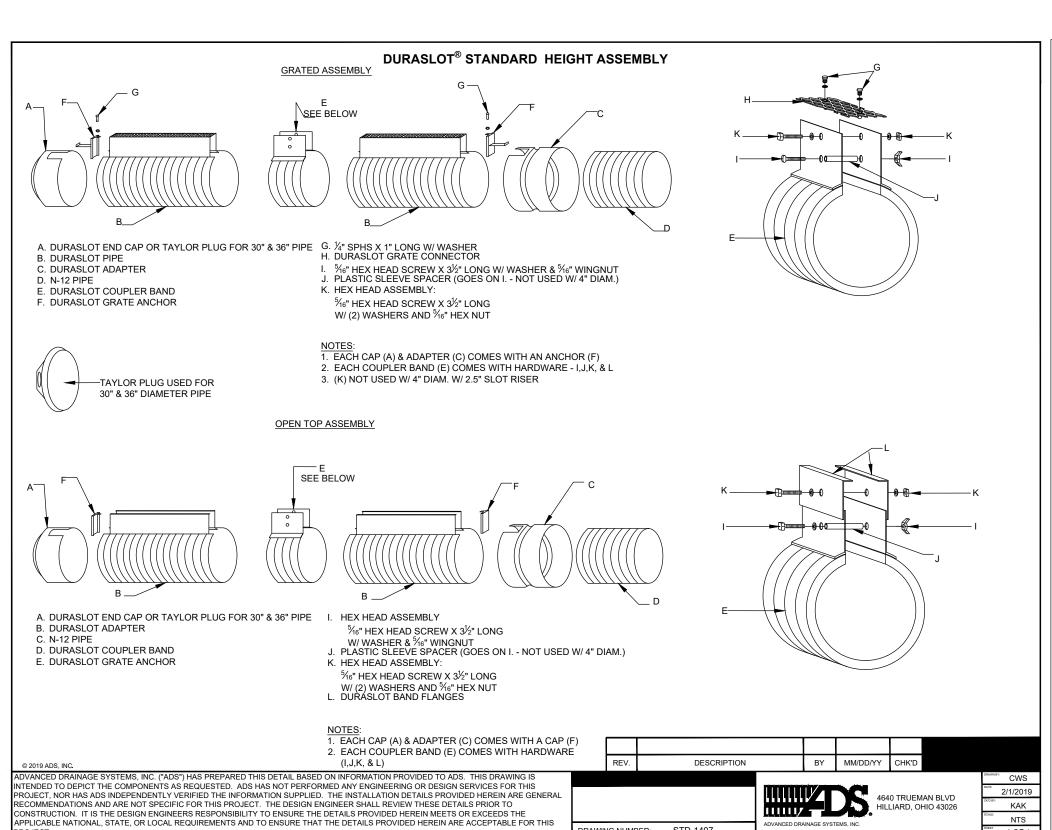NOTES: ALL FITTINGS DIMENSIONS ARE FOR REFERENCE ONLY

SIDE VIEW

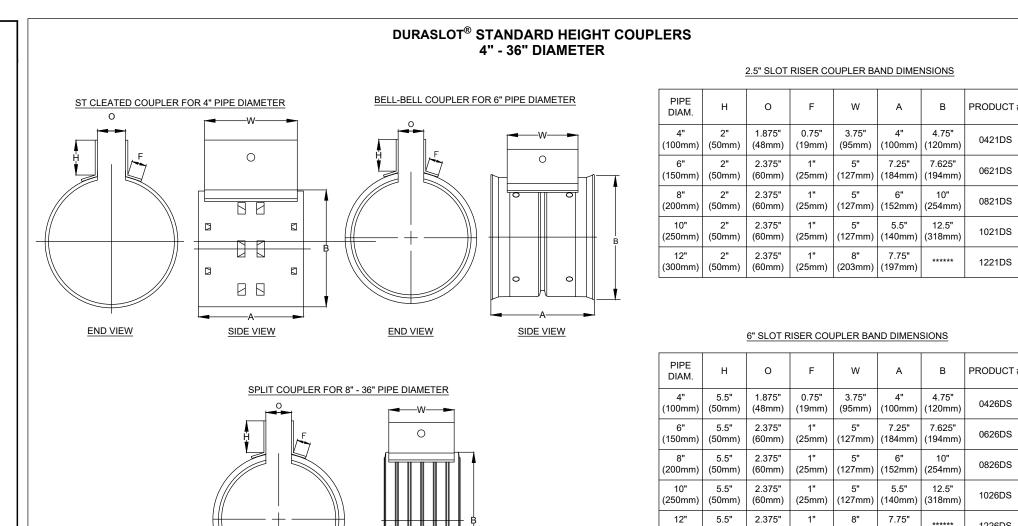

2.5" SLOT RISER COUPLER BAND DIMENSIONS

6" 2" 2.375" 1" 5" 7.25" 7.625"


O F W A B PRODUCT#


0621DS

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1021DS

DRAWN BY: CWS APPROVED BY: KAK REVISIONS: SCALE: NTS



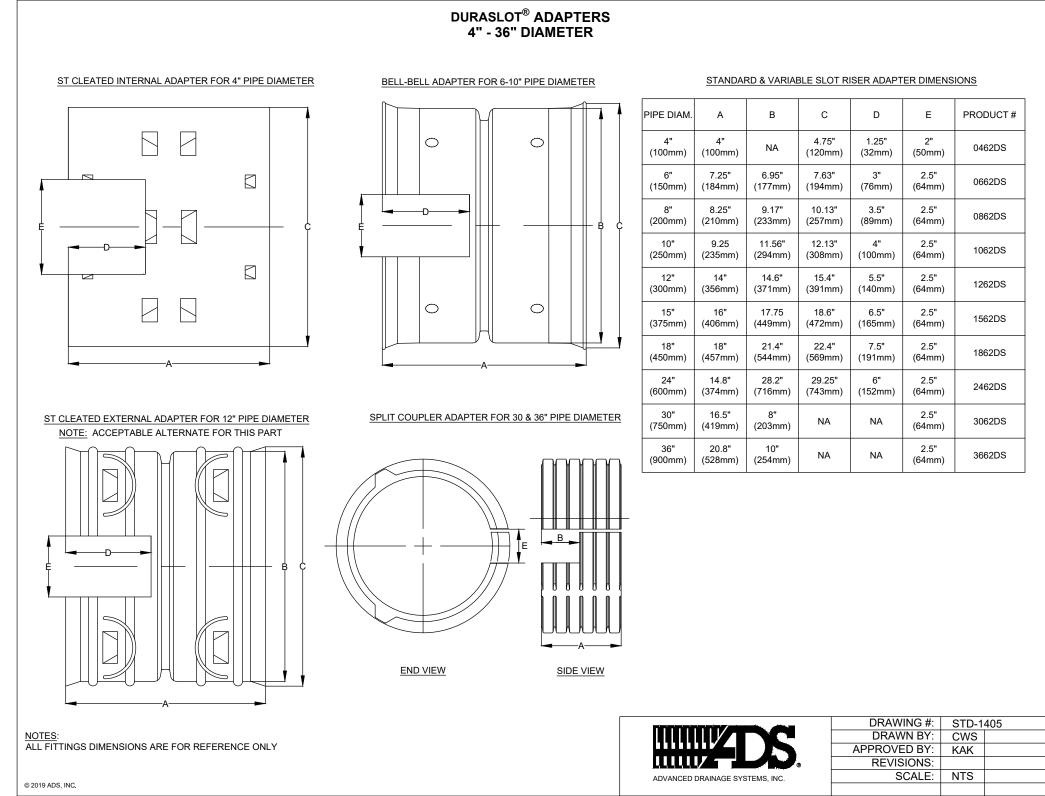

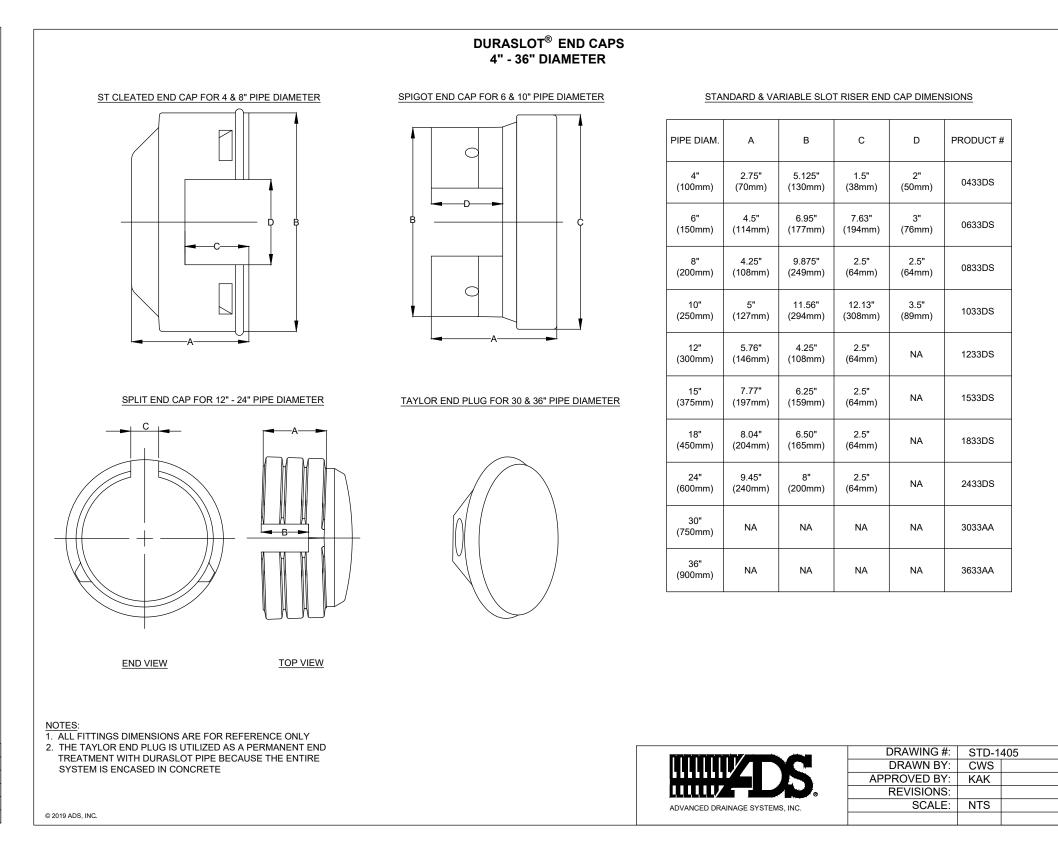-	DATE	REVISION	BY	
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ASSOCIAT ASSOCIATI Engineers I survey 421 Commercial Court, Suite C Venice, Florida 342 Phone (941)412-1293, Fax (941)412-1043 Certificate of Authorization No. 3943

E S	DATE 11/25/2019	CKD. BY	DATE	
ORS 1292	DRAWN DRA	TER	06/04/20	
1292	DESIGN DRA	TER	06/04/20	
	SCALE @ 22"x34"	DMK NO.	19-0127	


MICHAEL ARANDA THE GALLERIA SHOPS, LLC. 1222 SW 47th STREET SUITE 330 CAPE CORAL, FL. 33094


1460 E VENICE AVE SLOT DRAIN DETAILS

ENGINEER OF RECORD

TIMOTHY E. ROANE, P.E.

STATE OF FLORIDA NO. 63113

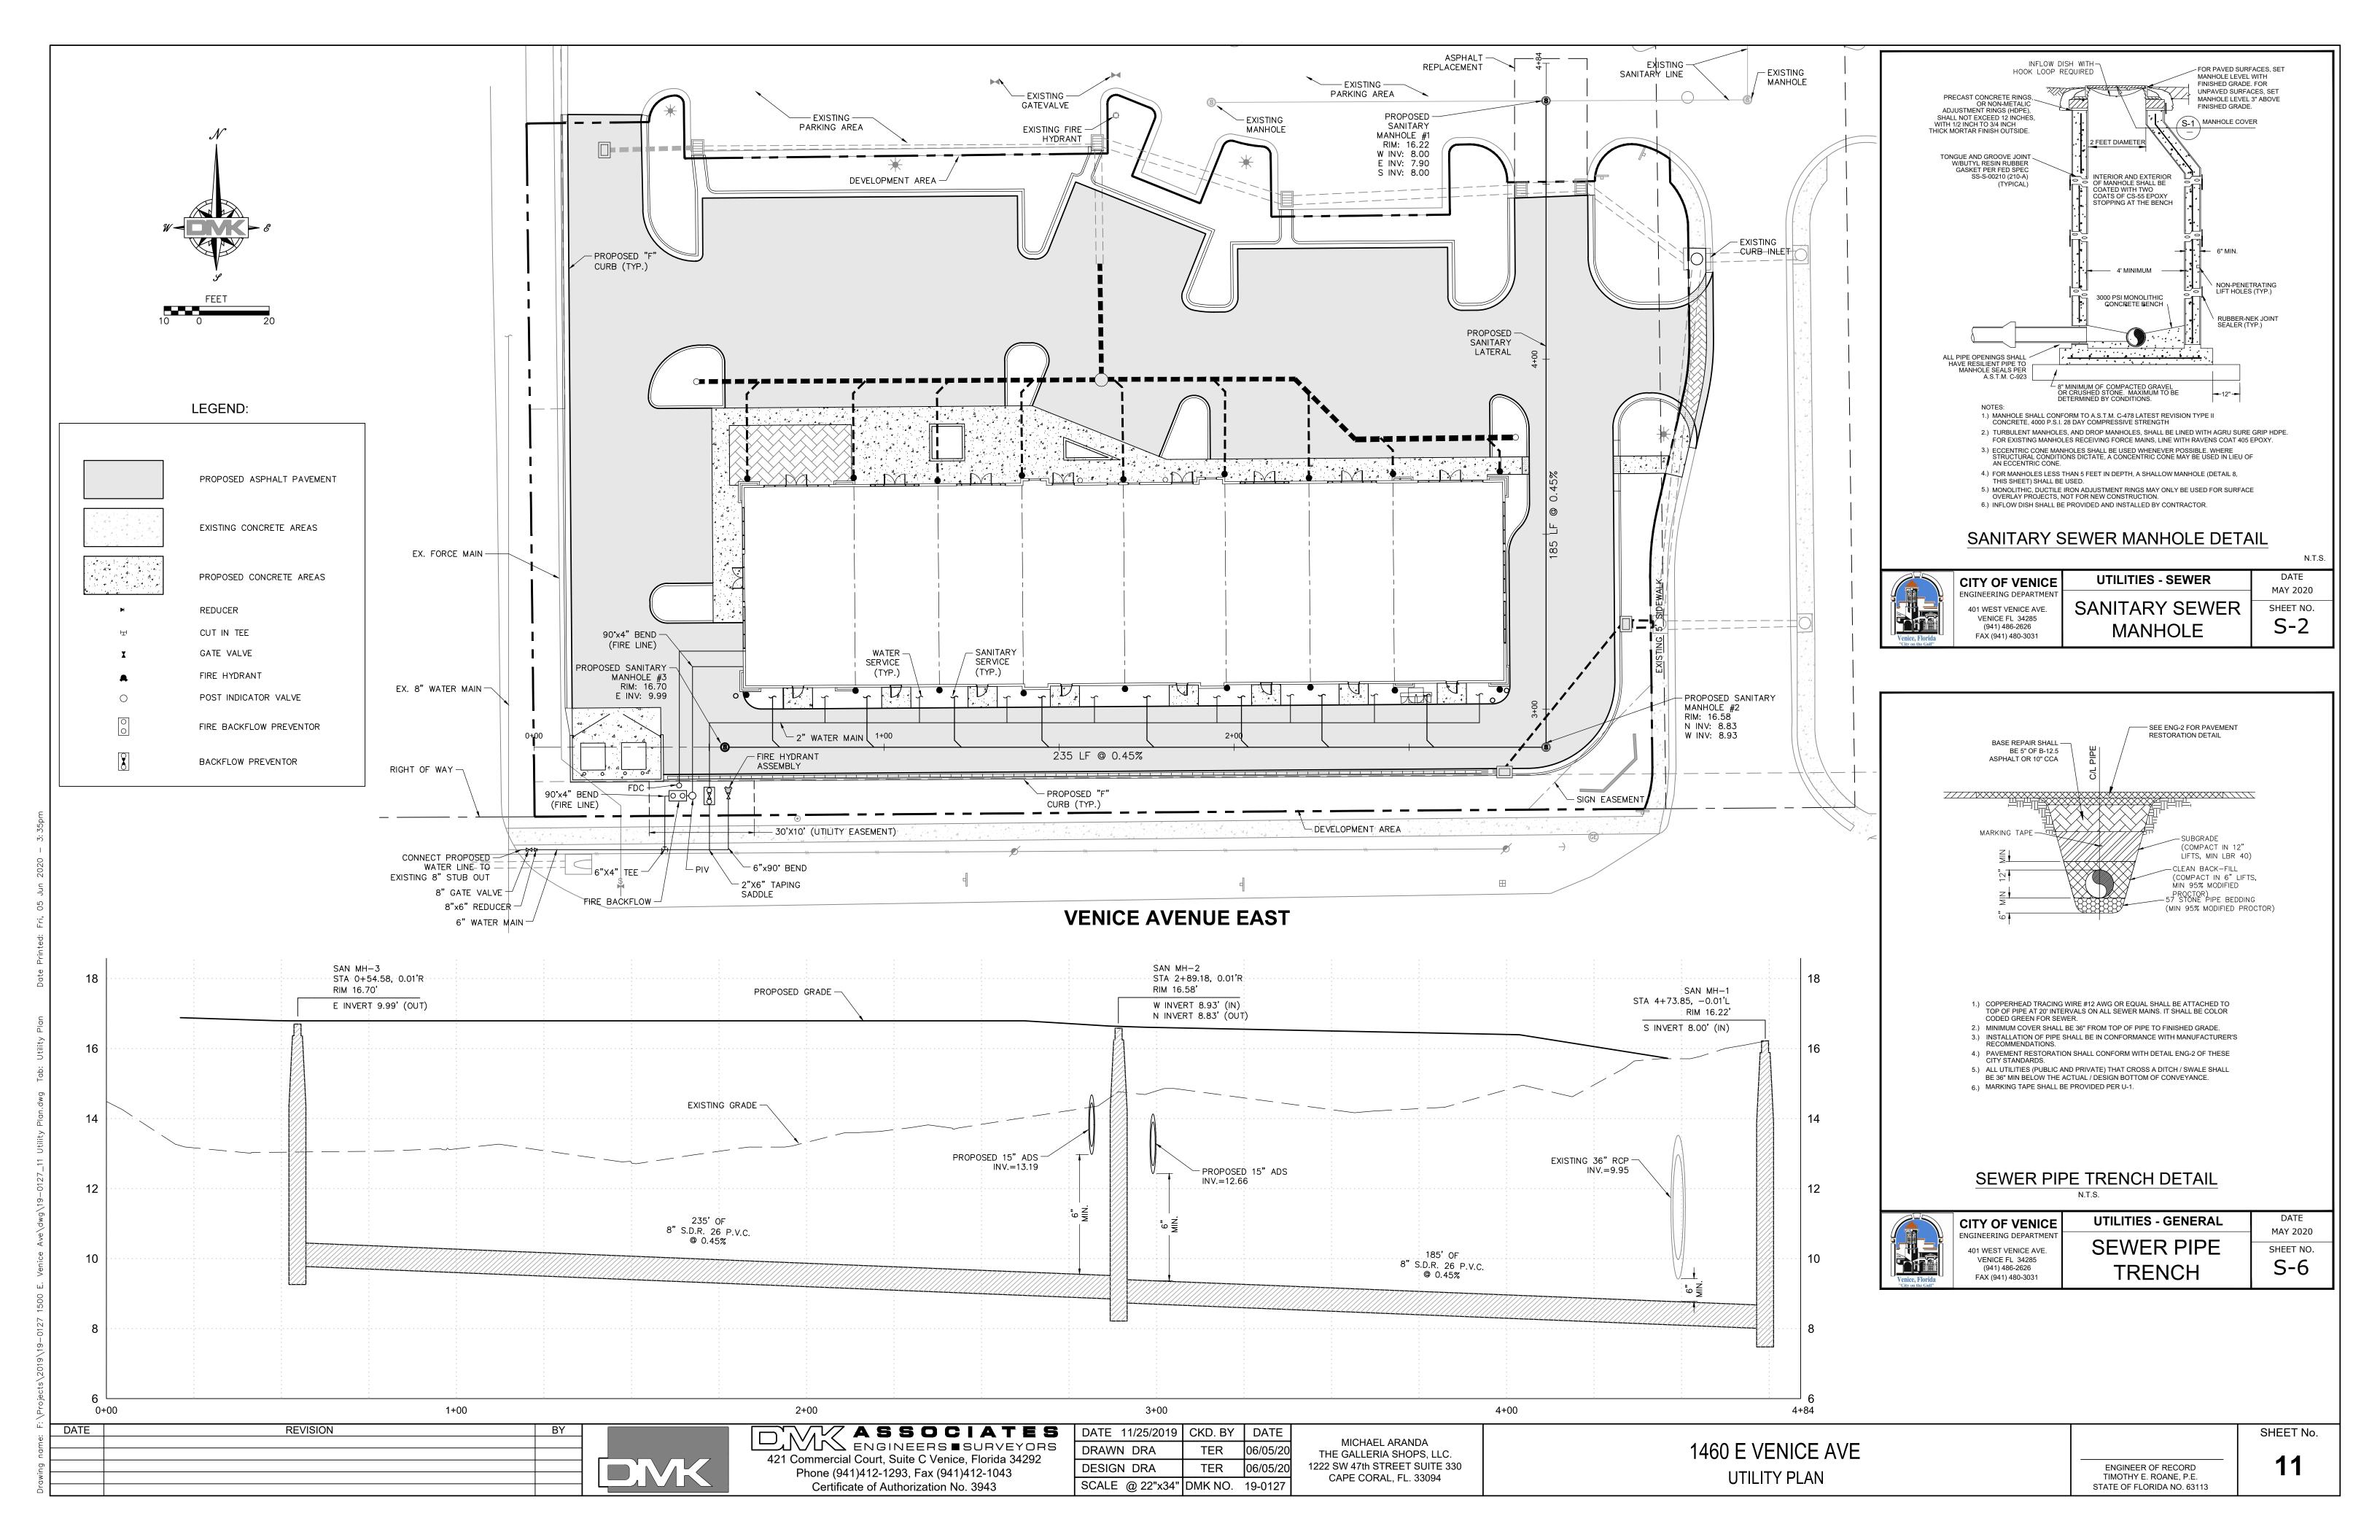

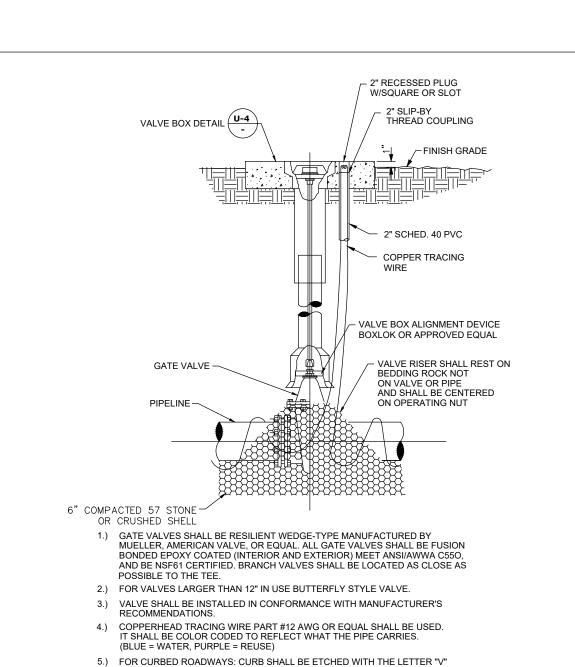

DIRECTLY PERPENDICULAR TO THE VALVE BOX.

GATE VALVE DETAIL

(WATER AND REUSE ONLY) N.T.S.

**UTILITIES - WATER** 

**GATE VALVE** 

MAY 2020

SHEET NO.

6.) ALL BOLTS AND HARDWARE SHALL BE 316 SS.


**CITY OF VENICE** 

401 WEST VENICE AVE.

VENICE FL 34285

(941) 486-2626

FAX (941) 480-3031

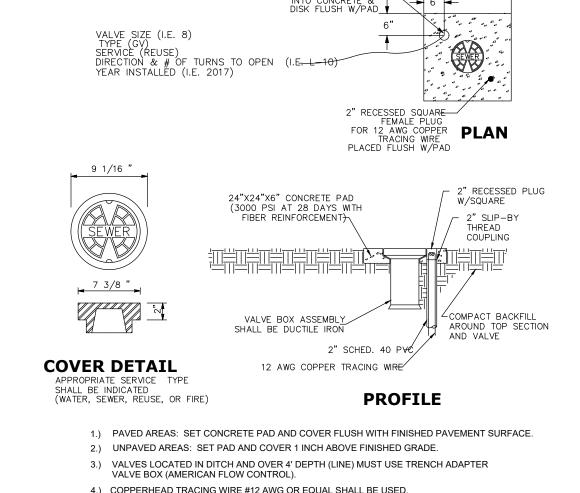

(BLUE = WATER, GREEN = SEWER, PURPLE = REUSE). CONTINUITY TEST SHALL BE PERFORMED ON ALL TRACER WIRES.

5.) PRE-CAST PADS MAY BE USED WITH CITY APPROVAL

CITY OF VENICE

401 WEST VENICE AVE.

VENICE FL 34285

(941) 486-2626

FAX (941) 480-3031

UNDISTURBED

- 6.) FOR CURBED ROADWAYS: CURB SHALL BE ETCHED WITH THE LETTER "V" DIRECTLY PERPENDICULAR TO THE VALVE BOX. 7.) VALVE BOX COVERS SHALL BE PAINTED BLUE FOR POTABLE WATER, PURPLE FOR
- REUSE WATER. AND GREEN FOR SEWER.

VALVE BOX DETAIL

TEST PLUG (1/2" NST)

2500 PSI

1.) EXISTING MAIN SHALL NOT BE TAPPED UNTIL THE ASSEMBLED SLEEVE

ND VALVE ARE TESTED IN PLACE AT A MINIMUM OF 150 PSI FOR

2.) UPON SUCCESSFUL TAPPING SLEEVE PRESSURE TEST (NOTE 1), THE THRUST BLOCK SHALL BE POURED AND HAVE SET FOR 24 HRS PRIOR

4.) GATE VALVES SHALL BE RESILIENT WEDGE-TYPE MANUFACTURED BY

MUELLER OR AMERICAN VALVE. ALL GATE VALVES SHALL BE FUSION

5.) TAPPING SLEEVES MAY ONLY BE USED WHEN THE TAP DIAMETER IS AT LEAST

ONE PIPE SIZE SMALLER THAN THE DIAMETER OF THE MAIN BEING TAPPED.

6.) VALVE BOX ALIGNMENT DEVICE SHALL BE INSTALLED IN ACCORDANCE WITH W-1

TAPPING SLEEVE & VALVE DETAIL

3.) STAINLESS STEEL TAPPING SLEEVE SHALL BE FORD. ALL

TO TAPPING. READY-MADE THRUST BLOCKS CAN BE USED WITH CITY APPROVAL

HARDWARE SHALL BE 316 STAINLESS STEEL. GASKETS SHALL BE VIRGIN SBR COMPOUND.


WRÀP IN VISQUEEN OR EQUAL TAPPING VALVE

**UTILITIES - GENERAL** 

VALVE BOX

PROPOSED MAIN OR SERVICE LINE

PROPOSED MAIN OR SERVICE LINE

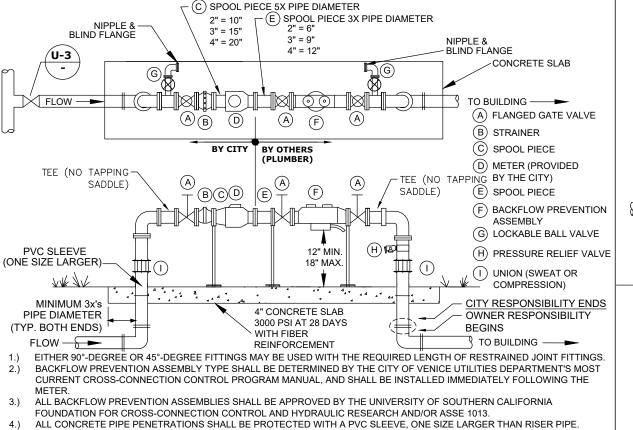

VALVES SHALL BE FULL PORTED FULL FLOW BALL VALVES OR RESILIENT WEDGE NON-RISING STEM GATE VALVES. PIPE BETWEEN TAP & ISOLATION VALVE SHALL BE C900 PVC. METER SIZE BY-PASS SIZE THE WATER METER SHALL MATCH THE BACKFLOW AND ASSEMBLY PIPE SIZE METERS 1-1/2" AND UP WILL HAVE FLANGES. LAY LENGTHS MUST BE VERIFIED PRIOR TO CONSTRUCTION OF ASSEMBLIES. ASSEMBLIES 2" AND UP REQUIRE ONE UNION ON THE UPSTREAM RISER (0.) ASSEMBLIES 1-1/2" AND SMALLER REQUIRE TWO UNIONS. 1 1/2" 1" I.) METERS 1-1/2" AND SMALLER REQUIRE A LOCKABLE CURB STOP 2.) NO SPOOL PIECE REQUIRED FOR 3/4", 1", OR 1 1/2".

13.) ALL COMMERCIAL AND MULTI FAMILY UNIT METERS MUST BE ABOVE GRADE. REUSE

CITY OF VENICE

401 WEST VENICE AVE.

VENICE FL 34285

(941) 486-2626

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POTABLE WATER MAIN

RECLAIMED WATER MAIN

METERS 2" AND LESS MAY BE BELOW GROUND. 4.) BACKFLOW PREVENTION ASSEMBLY AND BYPASS ARE NOT REQUIRED FOR REUSE METER ONLY 5.) BACKFLOW PREVENTION ASSEMBLIES SHALL ONLY BE BY-PASSED IF A TEMPORARY RP IS INSTALLED ON BY-PASS B.) NO BRANCH OR TEE SERVICE CONNECTIONS, OTHER THAN THE UTILITIES METER BY-PASS RETURN TEE, SHALL EXIST BETWEEN THE WATER METER AND BACKFLOW PREVENTER.

NO BYPASS

NO BYPASS

1 1/2"

DATE

MAY 2020

SHEET NO.

17.) THE ENGINEER OF RECORD SHALL SUBMIT METER SIZING CALCULATIONS BASED ON SERVICE DEMAND PER AWWA M-22 AND SUBJECT TO APPROVAL BY THE UTILITY DEPARTMENT. 18.) PARALLEL BACKFLOW ASSEMBLY MAY BE PERMITTED TO ALLOW FOR UNINTERRUPTED SERVICE AND SHALL PROVIDE THE SAME DEGREE OF PROTECTION OR GREATER.


NO PVC SHALL BE PERMITTED ON THE CITY SIDE WATER & REUSE METER & BACKFLOW PREVENTION ASSEMBLY ABOVE GROUND COMMERCIAL/MULTI-UNIT/SINGLE SERVICE/MASTER METER

(WITH BY-PASS AROUND METER ONLY) N.T.S.

**UTILITIES - WATER** 

WATER & REUSE

**METER & BACKFLOW** 

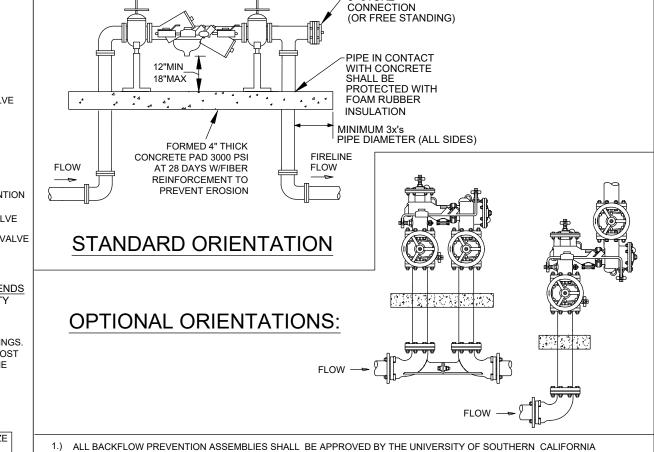

FOUNDATION FOR CROSS-CONNECTION CONTROL AND HYDRAULIC RESEARCH AND/OR 1047 OR 1048 ASSE AS APPLICABLE 45° FITTINGS MAY BE SUBSTITUTED FOR 90° FITTINGS. 3.) PIPE BETWEEN TAP & ISOLATION VALVE SHALL BE C900 PVC OR HDPE.

4.) IF TEEING OFF FOR POTABLE SERVICE, INSTALL INDICATOR VALVE BETWEEN TEE FOR POTABLE SERVICE AND FIRE SERVICE BACKFLOW ASSEMBLY 5.) ASSEMBLY SHALL BE PAINTED RED WITH ALKYD ENAMEL, EPOXY OR POLYURETHANE BASED PAINT, EXCEPT FOR

STAINLESS STEEL PARTS. 6.) VALVE ASSEMBLIES SHALL MEET NFPA 24 REQUIREMENTS AND INDICATOR VALVES SHALL BE PROVIDED. 7.) FOR CLEARANCE ISSUES, PLEASE REFER TO THE CURRENT FLORIDA FIRE PREVENTION CODE REQUIREMENTS.

8.) FOR FIRE PROTECTION SYSTEMS EQUIPPED WITH A FIRE PUMP, THE PIPE BETWEEN THE CHECK VALVE AND THE OUTSIDE CONNECTION SHALL BE EQUIPPED WITH AN APPROVED BALL DRIP. 9.) BACKFLOW PREVENTION ASSEMBLY TYPE SHALL BE DETERMINED BY THE CITY OF VENICE UTILITIES DEPARTMENT'S

MOST CURRENT CROSS-CONNECTION CONTROL PROGRAM. 10.) 5" STORZ INLET CONNECTION MAY BE REDUCED FOR PIPE SIZES LESS THAN 5".

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FAX (941) 480-3031

#### FIRE SERVICE BACKFLOW ASSEMBY SIZE 2" - 10"

1.) ALL PIPE FITTINGS SHALL BE COMPACT, DUCTILE IRON.

2.) ALL APPLICATIONS (RAW, POTABLE, REUSE, SEWER)

**UTILITIES - WATER CITY OF VENICE** FIRE SERVICE 401 WEST VENICE AVE. VENICE FL 34285

MAY 2020 SHEET NO. W-9 **BACKFLOW ASSEMBL** 

N.T.S.

DATE

**UTILITIES - SEWER** CITY OF VENICE 401 WEST VENICE AVE.

-45° STREET WYE

NO MORE THAN 1" BELOW

METAL CLEANOUT BOX

W/SQUARE OR SLOT

24"X24" 3000 PSI AT 28

DAYS CONCRETE WITH

FIBER REINFORCEMENT

COPPER TRACING WIRE

SANITARY SEWER SERVICE &

CLEANOUT DETAIL

-45° STREET ELBOW

— 2" RECESSED PLUG

PAD 4" THICK

- EXTENSION

- 2" SCHED, 40 PVC

-45° STREET WYE

-45° STREET ELBOW

-PROPERTY LINE

1.) ALL SERVICE LATERAL JOINTS SHALL BE

MINIMUM OF SIX INCHES IN DIAMETER.

4.) A DOUBLE-SWEEP CLEANOUT SHALL BE

5.) COPPERHEAD TRACING WIRE #12 AWG OR

THE BUILDING GENERAL CONTRACTOR

EQUAL SHALL BE USED. IT SHALL BE COLOR

SHALL INSURE THE APPLICABLE SERVICING SANITARY SEWER CLEANOUT CONNECTION

S PLACED AT FINISH GRADE WITH COVER

CERTIFICATION OF OCCUPATION (CO) IS

REQUESTED. NON COMPLIANCE MAY

8.) FOR CURBED ROADWAYS: CURB SHALL BE

PERPENDICULAR TO THE SEWER

ETCHED WITH THE LETTER "S" DIRECTLY

9) WHEN CONNECTING TO EXISTING SERVICE

AND REPLACE WITH SDR26 GASKETED

TITTINGS. USE MAXADAPTOR TO TRANSITION

RESULT IN A DELAY OF CO.

FROM VCP TO PVC.

AND IS WITH A CONCRETE PAD AT THE TIME

PROVIDED ON THE PRIVATE SIDE.

CODED TO GREEN FOR SEWER.

6.) AIR TEST REQUIRED.

3.) A TWO-WAY CLEANOUT SHALL BE PROVIDED A

THE RIGHT OF WAY ON THE PROPERTY LINE

GASKETED FROM MAIN WYE.

2.) ALL LATERAL SERVICES SHALL BE A

-GRAVITY SEWER MAIN

CLEANOUT TEE

CLEANOU

SERVICE

TRACING WIRE-

ACCESS BOX

**CLEANOUT PLAN** 

CLEANOUT PROFILE

VENICE FL 34285

(941) 486-2626

FAX (941) 480-3031

USF 7610-S OR 7621-S

VALVE BOX -

TWO-WAY-

CLEANOUT TEE


(MIN 8" DIAMETER)

SERVICE LATERAL

SEWER SERVICE & **CLEANOUT** 

MAY 2020 SHEET NO. S-4

N.T.S.

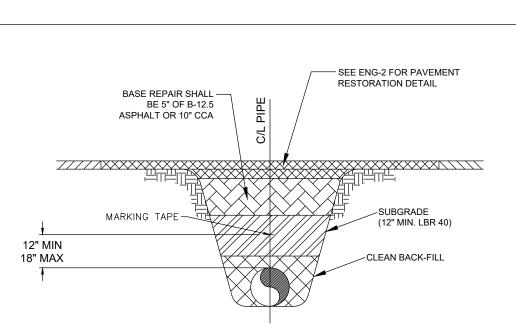

MARKING TAPE AND MESSAGES						
PIPE	TAPE COLOR	MESSAGE				
PVC STORM WATER	WHITE	CAUTION STORM WATER OR STORM DRAIN BELOW				
POTABLE WATER MAIN	BLUE	CAUTION POTABLE WATER MAIN BELOW				
REUSE WATER MAIN	PURPLE	CAUTION REUSE WATER MAIN BELOW				
SEWER FORCE MAIN	GREEN	CAUTION SEWER FORCE MAIN BELOW				
SEWER & SERVICE LATERALS	GREEN	CAUTION SEWER MAIN BELOW				

- 1.) COPPERHEAD TRACING WIRE #12 AWG OR EQUAL SHALL BE ATTACHED TO TOP OF PIPE AT 20' INTERVALS ON ALL RECLAIMED WATER. FORCE.
- THE PIPE CARRIES. (BLUE = WATER. GREEN = SEWER. PURPLE = REUSE) 2.) MINIMUM COVER SHALL BE 36" FROM TOP OF PIPE TO FINISHED GRADE
- MAXIMUM COVER SHALL BE 42" FROM FINISHED GRADE UNLESS OTHERWISE APPROVED. 3.) INSTALLATION OF PIPE SHALL BE IN CONFORMANCE WITH MANUFACTURER'S
- RECOMMENDATIONS. 4.) PAVEMENT RESTORATION SHALL CONFORM WITH DETAIL ENG-2 OF THESE
- 5.) CONFLICTS UTILIZE 45° BENDS WITH SEPARATION AS PER CITY DETAILS.
- 6.) ALL UTILITIES (PUBLIC & PRIVATE) THAT CROSS A DITCH/SWALE SHALL BE 36" MIN. BELOW THE ACTUAL/DESIGN BOTTOM OF CONVEYANCE. 7) MARKING TAPE SHALL BE 3" WIDE (MIN.) DETECTIBLE UNDERGROUND WARNING TAPE
- INSTALL CENTERED DIRECTLY OVER THE PIPE. 8.) SEE S-6 FOR GRAVITY SEWER PIPE TRENCH DETAIL

#### PRESSURE PIPE TRENCH DETAIL

**CITY OF VENICE** 

ENGINEERING DEPARTMENT 401 WEST VENICE AVE. VENICE FL 34285 (941) 486-2626 FAX (941) 480-3031

**UTILITIES - GENERAL UTILITY PIPE TRENCH** 

MAY 2020 SHEET NO. U-1

(941) 486-2626

CITY OF VENICE ENGINEERING DEPARTMENT 401 WEST VENICE AVE. VENICE FL 34285 FAX (941) 480-3031

AND BE NSF61 CERTIFIED.


**UTILITIES - GENERAL** TAPPING SLEEVE & VALVE

MAY 2020 SHEET NO. U-3

DATE

MAY 2020

SHEET NO.

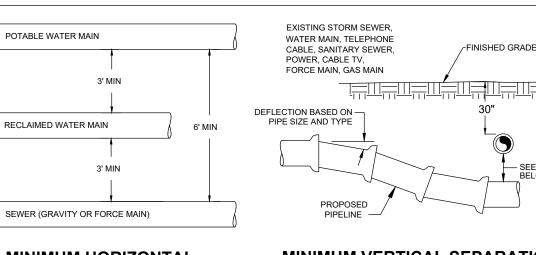

MINIMUM HORIZONTAL MINIMUM VERTICAL SEPARATION **DISTANCES (IN) SEPARATION DISTANCES (FT)** (OUTSIDE OF PIPELINE TO OUTSIDE OF PIPELINE) (OUTSIDE OF PIPELINE TO OUTSIDE OF PIPELINE) WATER MAIN WATER MAIN FORCE MAIN FORCE MAIN SANITARY SEWER REUSE MAIN

REUSE MAIN STORM WATER STORM WATER 6 6 6 6 6 6 OTHER UTILITIES 3 3 3 3 3 3 ) MAXIMUM JOINT DEFLECTION SHALL BE 90% OF MANUFACTURER'S RECOMMENDATION. WHEREVER POSSIBLE. THE LAYOUT OF UTILITIES SHALL PLACE SANITARY SEWER AND SEWER FORCE MAINS BELOW RECLAIMED MAINS AND BELOW WATER MAINS, RESPECTIVELY. WHERE WATER MAINS ARE ABOVE GRAVITY SEWERS OR WASTEWATER FORCE MAINS, A VERTICAL CLEARANCE OF 6 INCHES IS ACCEPTABLE. STORM SHALL BE PLACED BELOW

A. WHERE HORIZONTAL SEPARATION CANNOT BE MAINTAINED, C900 DR14 PVC PIPE SHALL BE USED FOR ONE OF THE PIPELINES B. WHERE VERTICAL CLEARANCE CANNOT BE MAINTAINED, ONE FULL LENGTH OF DR14 C900 PIPE SHALL BE INSTALLED CENTERED AT THE POINT OF CROSSING.

C. WHERE 36" MINIMUM DEPTH OF COVER CANNOT BE MAINTAINED. SPECIAL PROTECTION OR PIPE MATERIAL UPGRADE MAY BE REQUIRED, AT THE DISCRETION OF THE UTILITY DEPARTMENT.

.) NO UTILITY PIPE SHALL PASS THROUGH, OR COME IN CONTACT WITH ANY PART OF A SANITARY MANHOLE OR STORMWATER STRUCTURE WITHOUT APPROVAL FROM THE UTILITIES DIRECTOR OR CITY ENGINEER


#### **UTILITY CONFLICT & SEPARATION DETAIL**

**UTILITIES - GENERAL** CITY OF VENICE ENGINEERING DEPARTMEN 401 WEST VENICE AVE. VENICE FL 34285 (941) 486-2626 FAX (941) 480-3031

UTILITY CONFLICTS & SEPARATIONS

DATE MAY 2020 SHEET NO. U-5

N.T.S

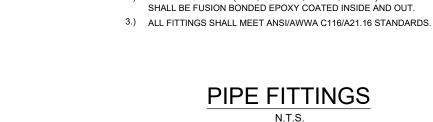

COLOR	MATERIAL/CLASS
BLUE	
WHITE	AWWA C900 PVC / DR 18 FUSIBLE C900 PVC / DR 18
PURPLE	HDPE PPI PE 4710 / DR 11
GREEN	(DUCTILE IRON PIPE SIZE)
BLUE	PE (POLYTUBING) / DR 9
PURPLE	PE (POLYTUBING) / DR 9
GREEN	ASTMD3034 / SDR 26 FUSIBLE PVC / SDR 26
GREEN	ASTMD3034 / SDR 26 / SDR 35 / SCH 40 PVC
	BLUE WHITE PURPLE GREEN BLUE PURPLE GREEN

#### PIPE MATERIAL SCHEDULE

CITY OF VENICE ENGINEERING DEPARTMENT

**UTILITIES - GENERAL** PIPE FITTINGS & 401 WEST VENICE AVE. VENICE FL 34285 (941) 486-2626 **MATERIAL** FAX (941) 480-3031

DATE MAY 2020 SHEET NO. U-6

MINIMUM LENGTH (FT) OF FORCE MAIN TO BE RESTRAINED ON EACH SIDE OF FITTING 45 BEND: 6 9 12 14 16 21 23 25 29 VU 4 6 7 9 10 13 15 16 19 VD 12 20 26 32 37 48 53 28 68 22.5 BEND: H | 3 | 4 | 6 | 7 | 8 | 10 | 11 | 12 | 14 VU 2 3 4 4 5 6 7 8 9 
 VD
 7
 10
 13
 15
 18
 23
 26
 28
 33
 11.25 BEND: H 2 2 3 3 4 5 5 6 7

MINIMUM LENGTH (FT) OF WATER OR REUSE MAIN									
TO BE RESTRAINED ON EACH SIDE OF FITTING									
FITTING			PIP	E SIZE (	INCHES)				
11111110	4	6	8	10	12	16	18	20	24
90 BEND: H	23	33	43	51	60	76	83	90	104
45 BEND: H	10	14	18	21	25	31	34	37	43
VU	6	8	11	13	16	20	22	24	28
VD	22	30	40	48	56	72	80	87	102
22.5 BEND: H	5	7	8	10	12	15	17	18	21
VU	3	4	5	6	7	10	11	12	14
VD	10	15	19	23	27	35	38	42	49
11.25 BEND: H	2	3	4	5	6	7	8	9	10
PLUGS:	52	73	96	115	136	174	193	211	246
ABBREVIATIONS: H=HORIZONTAL, VU=VERTICAL UP, VD=VERTICAL DOWN.									

1.) FOR TEE OR REDUCER FITTINGS SUBMIT RESTRAINED JOINT LENGTH CALCULATIONS TO CITY ENGINEER FOR REVIEW AND APPROVAL, USING THE ASSUMPTIONS LISTED ABOVE. 2.) RESTRAINED JOINT LENGTH FOR WATER AND REUSE MAINS BASED ON TEST PRESSURE OF 150 PSI. RESTRAINED JOINT

LENGTH FOR FORCE (SEWER) MAINS BASED ON TEST PRESSURE OF 100 PSI. CALCULATIONS WERE MADE USING EBAA IRON SOFTWARE (AVAILABLE AT WWW.EBAA.COM) AND THE FOLLOWING ASSUMPTIONS: GRANULAR MATERIAL (GM) SOIL TYPE TRENCH TYPE 3. BURY DEPTH OF 3 FT. AND SAFETY FACTOR OF 2 TO 1. IF FIELD CONDITIONS DIFFER FROM ABOVE ASSUMPTIONS EOR SHALL PROVIDE CALCULATIONS BASED ON ACTUAL CONDITIONS.

3.) RESTRAINED JOINT SHALL BE USED ON ALL JOINTS FROM ANY MAIN TEE TO ANY FIRE HYDRANT ASSEMBLY. 4.) THRUST BLOCKS WILL NOT BE ACCEPTED, UNLESS OTHERWISE APPROVED BY THE CITY ENGINEER. 5.) ALL HARDWARE SHALL BE 316 SS

PRESSURE MAIN RESTRAINED

### JOINT TABLE

CITY OF VENICE 401 WEST VENICE AVE VENICE FL 34285

ENGINEERING DEPARTMEN (941) 486-2626

FAX (941) 480-3031

**UTILITIES - GENERAL** RESTRAINE **JOINT TABLE** 

	MAY 2020
D	SHEET NO.
Ε	U-7

N.T.S.

DATE

DATE **REVISION** 



Phone (941)412-1293, Fax (941)412-1043 Certificate of Authorization No. 3943

DATE 11/25/2019 CKD. BY DRAWN DRA TER 06/04/20 DESIGN DRA TER 06/04/20 SCALE @ 22"x34" DMK NO. 19-012"

MICHAEL ARANDA THE GALLERIA SHOPS, LLC.

1460 E VENICE AVE UTILITY DETAILS

**ENGINEER OF RECORD** TIMOTHY E. ROANE, P.E. STATE OF FLORIDA NO. 63113

SHEET No.

ASSOCIATES ENGINEERS SURVEYORS 421 Commercial Court, Suite C Venice, Florida 34292

1222 SW 47th STREET SUITE 330 CAPE CORAL, FL. 33094

