GENERAL NOTES:

- ALL CONSTRUCTION TO BE IN ACCORDANCE WITH THE CITY OF VENICE LAND DEVELOPMENT REGULATIONS.
- THE CONTRACTOR SHALL RETAIN ON THE WORK SITE AT ALL TIMES COPIES OF ALL PERMITS NECESSARY FOR
- THE NORTH AMERICAN VERTICAL DATUM (NAVD) OF 1988 IS THE BENCHMARK DATUM FOR THIS PROJECT CONVERSION FACTOR: NAVD 1988 + 1.11 FT = NGVD 1929.
- ALL AREAS DESIGNATED AS "PRESERVE OR CONSERVATION" TO BE CLEARLY DELINEATED PRIOR TO

GENERAL CONSTRUCTION NOTES:

- 1. THERE SHALL BE NO CHANGE OR DEVIATION FROM THESE PLANS UNLESS APPROVED BY THE ENGINEER OR CITY OF VENICE.
- 2. ALL CLEARING AND GRUBBING DEBRIS TO BE BURNED OR REMOVED FROM SITE AND IS PART OF CLEARING AND GRUBBING ITEM
- HEALTHY AND ARE EXPECTED TO BE PART OF THE LANDSCAPE DEVELOPMENT. THEREFORE, IF ANY TREE(S) DAMAGED BY CONSTRUCTION OPERATION OR BY OTHER MEANS (EXCLUDING LIGHTNING, WINDSTORM AND OTHER ACTS OF GOD) PERISHES WITHIN THE CONSTRUCTION PERIOD. IT WILL BE THE RESPONSIBILI OF THE CONTRACTOR TO REMOVE AND DISPOSE OF THOSE TREES, NO ADDITIONAL COMPENSATION WILL BE MADE BY THE OWNER FOR THE LABOR, MATERIAL OR MACHINERY REQUIRED TO REMOVE SAID TREE(S), EXOTIC VEGETATION (E.G., MELALEUCA AND BRAZILIAN PEPPER) EXISTING WITHIN THE PROJECT AREA SHALL BE REMOVED AND PROPERLY DISPOSED OF IN AN APPROVED LANDFILL.
- WHERE EXCAVATIONS ARE IN CLOSE PROXIMITY OF TREES, THE CONTRACTOR SHALL USE EXTREME CARE IN NOT DAMAGING THE ROOT SYSTEM. NO EQUIPMENT, SUPPLIES OR VEHICLES SHALL BE STORED OR PARKED WITHIN THE DRIP LINE OF TREES TO REMAIN AND BE PRESERVED. IT WILL BE THE RESPONSIBILITY OF THE CONTRACTOR TO INFORM ALL OF HIS EMPLOYEES AND SUBCONTRACTORS OF THIS REQUIREMENT AND TO ENFORCE SAME
- LAY SOD AROUND ALL INLETS, MITERED ENDWALLS, HEADWALLS, SWALES, LAKE SLOPES, AND TWO FEET (2') WIDE STRIP ADJACENT TO ALL CURBING, AND AS DIRECTED BY THE ENGINEER, ALL PROPOSED GROUND ELEVATIONS ARE FINISHED SOD ELEVATIONS, FINISH EARTHWORK GRADING WILL BE 0.2 FEET BELOW ELEVATIONS SHOWN TO ALLOW FOR SOD THICKNESS. SODDING INCLUDES MAINTAINING SLOPES AND SOD UNTIL COMPLETION AND ACCEPTANCE OF TOTAL PROJECT OR GROWTH IS ESTABLISHED WHICHEVER COMES LAST. ALL EROSION SILTATION AND MAINTAINING GRADES IS THE RESPONSIBILITY OF THE
- CALL "SUNSHINE" (1-800-432-4770), COMCAST, FPL, CITY OF VENICE UTILITIES DEPARTMENT, TECO, AND FRONTIER PRIOR TO CONSTRUCTION AND CONNECTION TO EXISTING UTILITIES, IT IS THE CONTRACTOR'S RESPONSIBILITY TO PROTECT. EXISTING UTILITIES FROM DAMAGE.
- ALL UTILITY LINES, STORM DRAIN LINES AND ACCESSORIES SUCH AS, BUT NOT LIMITED TO MANHOLES, CLEANOUTS, SEWER AND WATER SERVICES, VALVES, FIRE HYDRANTS AND INLETS WILL BE CONSTRUCTED TO ALIGNMENT AND LOCATIONS SHOWN ON PLANS UNLESS OTHERWISE DIRECTED BY THE ENGINEER.
- 8. CLEARING, GRUBBING, STRIPPING, AND COMPACTION WILL BE INSPECTED BY THE ENGINEER PRIOR TO FILLING
- PRIOR TO THE START OF CONSTRUCTION ACTIVITIES, CONSERVATION/PRESERVE AREAS, EXISTING LAKES & WATERWAYS WITHIN AND ADJOINING THE AREA OF CONSTRUCTION ACTIVITY SHALL BE PROTECTED BY ERECTION OF TREE PROTECTION BARRICADES AND/OR SILT BARRIERS. TREE PROTECTION BARRICADES SHALL MEET THE STANDARDS OF THE CITY OF VENICE. SILT BARRIERS SHALL BE CONSTRUCTED IN ACCORDANCE WITH THE "BEST MANAGEMENT PRACTICES PLAN" AND THE "BMP DETAILS" SHOWN ON DWGS, B-1 THROUGH B-2 OF THE FULL CIVIL CONSTRUCTION PLANS. THE ENGINEER WILL DETERMINE THE EXTENT AND TYPE OF PROTECTIVE MEASURES TO BE CONSTRUCTED FOR PROTECTION OF CONSERVATION/PRESERVE AREAS, THE ENGINEER SHALL BE NOTIFIED WHEN PRESERVE AREA BARRICADES AND BARRIERS ARE IN PLACE
- THE SITE CONSTRUCTION STAKEOUT SHALL BE PERFORMED UNDER THE DIRECTION OF A FLORIDA REGISTERED SURVEYOR. AUTOCAD FILES WILL BE FURNISHED TO AID IN THE SITE CONSTRUCTION STAKEOUT. ANY DISCREPANCIES FOUND BETWEEN THE AUTOCAD FILES AND SITE CONSTRUCTION PLANS SHALL BE BROUGHT TO THE ENGINEER'S ATTENTION FOR CLARIFICATION PRIOR TO THAT STAKEOUT.
- 11. ALL DRAINAGE PIPE JOINTS SHALL BE WRAPPED PER FDOT INDEX NO. 280, SHEET
- 12. ROADWAY AND DRAINAGE STRUCTURES SHALL MEET FDOT STANDARD SPECIFICATIONS SECTION 346 OF 3000 PSI CONCRETE
- 13. THE WETLAND AND ASSOCIATED UPLAND VEGETATIVE BUFFER SHALL BE MAINTAINED IN ACCORDANCE WITH MANAGEMENT GUIDELINES CONTAINED WITHIN THE COMPREHENSIVE PLAN AS A CONSERVATION AREA OR PRESERVE. ALL ACTIVITIES INVOLVING FILLING, EXCAVATING, WELL DRILLING, ALTERING VEGETATION (INCLUDING TRIMMING OF BOTH TREES AND UNDERSTORY) AND STORING OF MATERIALS SHALL BE PROHIBITED WITHIN PRESERVATION AREAS. UNLESS WRITTEN APPROVAL IS FIRST OBTAINED FROM RESOURCE PROTECTION SERVICES TO FACILITATE IMPLEMENTATION OF APPROVED HABITAT MANAGEMENT PLANS OR THE REMOVAL OF NUISANCE/INVASIVE VEGETATION
- 14. A TREE REMOVAL AND PROTECTION PERMIT WILL BE REQUIRED PRIOR TO ANY CONSTRUCTION, CLEARING OR TREE REMOVAL. ALL WORK PERFORMED SHALL BE
- 15. EROSION AND SEDIMENT CONTROL BMPS IN ADDITION TO THOSE PRESENTED ON THE PLANS AND OUTLINED IN THE EROSION AND SEDIMENT CONTROL PLAN (ECP), BEST MANAGEMENT PRACTICES (BMP) PLAN, OR STORMWATER POLLUTION PREVENTION PLAN (SWPPP) SHALL BE IMPLEMENTED AS NECESSARY TO PREVENT TURBID DISCHARGES FROM FLOWING ONTO ADJACENT PROPERTIES OR ROADWAYS, OFF SITE STORMWATER CONVEYANCES OR RECEIVING WATERS OR ON SITE WETLANDS AND SURFACE WATERS. BMPS SHALL BE DESIGNED, INSTALLED, AND MAINTAINED BY THE SITE OPERATOR TO ENSURE THAT OFF SITE SURFACE WATER QUALITY REMAINS CONSISTENT WITH STATE AND LOCAL REGULATIONS, [THE OPERATOR IS THE ENTITY THAT OWNS OR OPERATES THE CONSTRUCTION ACTIVITY AND HAS AUTHORITY TO CONTROL THOSE ACTIVITIES AT THE PROJECT NECESSARY TO ENSURE COMPLIANCE.]
- OFFSITE SURFACE WATER DISCHARGES, DISCHARGES TO THE MS4, OR DISCHARGES TO ONSITE WETLANDS OR SURFACE WATERS WITH TURBIDITY IN EXCESS OF 29 NEPHELOMETRIC TURBIDITY UNITS (NTUS) ABOVE BACKGROUND LEVEL SHALL BE IMMEDIATELY CORRECTED. SUCH INCIDENTS SHALL BE REPORTED TO THE CITY OF VENICE WITHIN 24 HOURS OF THE OCCURRENCE. THE REPORT SHALL INCLUDE THE CAUSE OF THE DISCHARGE AND CORRECTIVE ACTIONS TAKEN.
- 17. FUEL AND OTHER PETROLEUM PRODUCT SPILLS THAT ENTER STORMWATER DRAINS OR WATERBODIES, OR FUEL AND OTHER PETROLEUM PRODUCT SPILLS THAT ARE IN EXCESS OF 25 GALLONS SHALL BE CONTAINED, CLEANED UP, AND IMMEDIATELY REPORTED TO THE CITY OF VENICE. SMALLER GROUND SURFACE SPILLS SHALL BE CLEANED UP AS SOON AS PRACTICAL.
- IF CONTAMINATED SOIL AND/OR GROUNDWATER IS DISCOVERED DURING DEVELOPMENT OF THE SITE, ALL ACTIVITY IN THE VICINITY OF THE CONTAMINATION SHALL IMMEDIATELY CEASE. AND THE CITY OF VENICE SHALL BE CONTACTED.
- 19. FERTILIZER APPLICATION SHALL BE CONSISTENT WITH THE CITY OF VENICE CODE.
- 20. NATIONAL POLLUTANT DISCHARGE ELIMINATION SYSTEM STORMWATER:
 - i. NPDES CONSTRUCTION GENERIC PERMIT COVERAGE SHALL BE OBTAINED AT LEAST 48 HOURS IN ADVANCE OF CONSTRUCTION COMMENCEMENT IN
- ii. A COPY OF THE CERTIFIED NPDES NOI, OR A COPY OF THE FDEP COVERAGE CONFIRMATION LETTER SHALL BE POSTED AT THE SITE IN ACCORDANCE WITH RULE 62-621.300(4)(A)PART III.C.2. F.A.C..
- iii. A COPY OF THE CERTIFIED NPDES NOI, OR A COPY OF THE FDEP COVERAGE CONFIRMATION LETTER SHALL BE PROVIDED TO AIR AND WATER QUALITY IN ACCORDANCE WITH RULE 62-621.300(4)(A)PART III.D.1, F.A.C..
- iv. THE SWPPP SHALL BE CERTIFIED IN ACCORDANCE WITH RULE 62-621,300(4)(A)PART V.D.6, F.A.C., AND A COPY OF THE CERTIFIED DOCUMENT SHALL BE SUBMITTED TO AIR AND WATER QUALITY AT LEAST 48 HOURS PRIOR TO THE COMMENCEMENT OF CONSTRUCTION.
- v. A COPY OF THE SWPPP, AND COPIES OF THE INSPECTION AND MAINTENANCE RECORDS SHALL BE MAINTAINED AT THE PROJECT SITE, AND SHALL BE READILY AVAILABLE TO STATE INSPECTORS.
- vi. NATIONAL POLLUTANT DISCHARGE ELIMINATION SYSTEM DEWATERING:
- THE DISCHARGE OF GROUNDWATER PRODUCED THROUGH DEWATERING, TO SURFACE WATERS, OR TO ANY PORTION OF THE MS4 WILL REQUIRE SEPARATE PERMITTING FROM THE DEP. PERMIT(S) SHALL BE OBTAINED PRIOR TO THE COMMENCEMENT OF DEWATERING. ANALYTICAL RESULTS FROM PRE-DISCHARGE TESTING SHALL BE PROVIDED TO AIR AND WATER QUALITY.
- 21. THE CONTRACTOR SHALL ENSURE THAT ADJACENT PROPERTIES ARE NOT IMPACTED BY WIND EROSION OR EMISSIONS OF UNCONFINED PARTICULATE MATTER IN ACCORDANCE WITH RULE 62-296.320(4)(c)1., FLORIDA ADMINISTRATIVE CODE, FROM THE CONSTRUCTION SITE BY TAKING ADEQUATE MEASURES TO STABILIZE
- 22. DEPARTMENT OF ENVIRONMENTAL PROTECTION WATER AND WASTEWATER PERMITS ARE REQUIRED.
- 23. ANY WELLS DISCOVERED ON SITE THAT WILL HAVE NO USE MUST BE PLUGGED BY A LICENSED WELL DRILLING CONTRACTOR IN AN APPROVED MANNER.
- 24. IN THE EVENT THAT THE CONSTRUCTION SITE IS ABANDONED PRIOR TO THE PROJECT COMPLETION, ALL CONSTRUCTION AND VEGETATIVE DEBRIS SHALL BE REMOVED FROM THE SITE AND DISPOSED OF AT AN APPROVED LANDFILL FACILITY.
- 25. A SEPARATE BUILDING PERMIT MUST BE APPLIED FOR AND ISSUED FOR EVERY SIGN, WALL, OUTDOOR LIGHTING AND STRUCTURE ON THE SITE. THE APPROVAL OF THESE CONSTRUCTION PLANS DOES NOT EXEMPT THE CONTRACTOR FROM OBTAINING THE NECESSARY BUILDING PERMITS.

CITY OF VENICE REQUIRED NOTES:

- ALL WORK CONDUCTED IN THE CITY OF VENICE RIGHT-OF-WAY (ROW) WILL REQUIRE THE ISSUANCE OF A ROW
- 2. ALL WORK CONDUCTED IN SARASOTA COUNTY AND/OR FDOT ROW SHALL REQUIRE A COPY OF STATE ISSUED
- TREE REMOVAL PERMIT MUST BE OBTAINED FROM THE CITY OF VENICE.
- 4. POST DEVELOPMENT RUNOFF DOES NOT EXCEED PRE-DEVELOPMENT RUNOFF VOLUME OR RATE FOR A 24-HOUR, 25-YEAR STORM EVENT
- ALL FIRE SERVICE BACKFLOW ASSEMBLIES SHALL BE INSTALLED BY A CERTIFIED CONTRACTOR WITH A CLASS I, II, OR V CERTIFICATE OF COMPETENCY ISSUED BY THE STATE FIRE MARSHALL AS PER F.S. 633.521.
- 6. CONSTRUCTION SITE MUST BE POSTED WITH 24-HOUR CONTACT INFORMATION.
- 7. ALL UTILITIES, WHETHER PUBLIC OR PRIVATE, SHALL MEET CITY OF VENICE STANDARDS.
- 8. CONTACT PUBLIC WORKS SOLID WASTE DIVISION (941-486-2422) FOR APPROVAL OF DUMPSTER LOCATION AND LAYOUT PRIOR TO CONSTRUCTION.

PARTIAL WATER UTILITY RECORD DRAWINGS

FOR

RANCH ROAD MULTI-FAMILY

SECTION 20, TOWNSHIP 38 S, RANGE 19 E CITY OF VENICE, FLORIDA

JANUARY 2024

REQUIRED APPROVALS:

SITE AND DEVELOPMENT PLAN APPROVAL

SPECIAL EXCEPTION - FOR MODIFICATION TO PARKING STANDARDS.

RECORD DRAWINGS

APPROVED

Sheet List Table

EXISTING CONDITIONS PLAN

HORIZONTAL CONTROL PLAN

MASTER DRAINAGE PLAN

STORMWATER DETAILS

MASTER UTILITY PLAN

MASTER UTILITY PLAN

MASTER UTILITY PLAN

UTILITY PLAN AND PROFILE

CITY OF VENICE WATER AND SEWER DETAILS

CITY OF VENICE WATER AND SEWER DETAILS

CITY OF VENICE WATER AND SEWER DETAILS

UTILITY PLAN AND PROFILE INDEX

MISCELLANEOUS DETAILS

COVER SHEET

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SITE PLAN

SITE PLAN

SITE PLAN

GENERAL NOTES

AERIAL SITE PLAN

SUBPHASING PLAN

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C1.4

C1.5

- C1.7

C1.8

C1.10

C1.11

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C2.9

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C3.102

C3.103

C3.2

C3.3

C3.6

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C3.8

C3.9

Sheet Title

PAVEMENT MARKINGS AND SIGNAGE PLAN

BEST MANAGEMENT PRACTICES PLAN

BEST MANAGEMENT PRACTICES DETAILS

PAVING GRADING AND DRAINAGE PLAN

PAVING GRADING AND DRAINAGE PLAN

PAVING GRADING AND DRAINAGE PLAN


POOL PAVING GRADING DRAINAGE DETAIL

COURTYARD PAVING GRADING DRAINAGE DETAIL

CITY OF VENICE PAVING AND SIDEWALK DETAILS

March 4, 2024

CONDITIONAL USE - FOR BUILDING HEIGHT IN EXCESS OF 42 FEET.

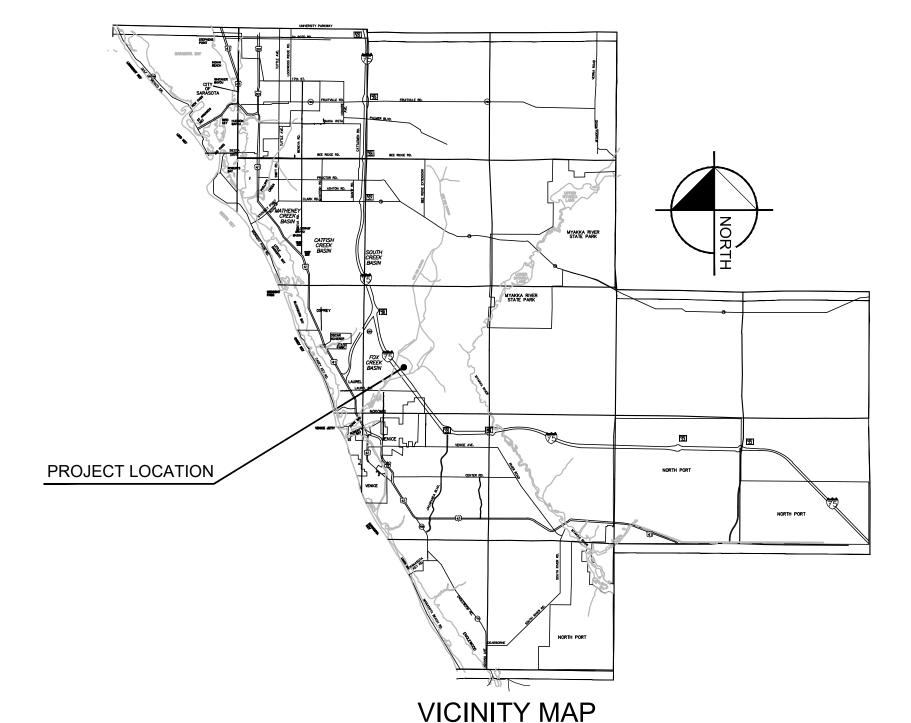

DEVELOPER: SOUTH CITY PARTNERS, LLC 3715 NORTHSIDE PKWY, SUITE 1-310

- ATLANTA, GA 30327
- PH: (404) 400-1322 CONTACT: BRYAN BELLISSIMO

ENGINEER: KIMLEY HORN AND ASSOCIATES, INC.

- 1800 2ND STREET, SUITE 900 SARASOTA, FL 34236 PH: (941)379-7600 CONTACT: ANDREW J. PLUTA, P.E.
- SURVEYOR: BRITT SURVEYING, INC. 680 U.S. BYPASS N, UNIT 1 VENICE, FL 34285 PH: (941) 493-1396

CONTACT: RANDALL E. BRITT, P.L.S.

ARCHITECT: DYNAMIK DESIGN 5901 PEACHTREE DUNWOODY ROAD. **BUILDING C, SUITE 250** ATLANTA, GA 30328 PH: (678) 506-8830 CONTACT: RUSSELL SIGMAN, AIA

LANDSCAPE ARCHITECT: B+C STUDIO, INC. 1320 ELLSWORTH INDUSTRIAL BLVD NW. SUITE A1400, ATLANTA, GA 30318 PH: (678) 990-7691 **CONTACT: TRAE ADAMS**

GEOTECH: NATIVE GEOSCIENCE 2014 EDGEWATER DRIVE, UNIT 246 ORLANDO, FL 32804 PH: (407) 342-1443 CONTACT: BRIAN W. JORY, P.E.



LAND USE DEVELOPMENT DATA

PARCEL AREA: 15.85 ACRES

PRESENT ZONING: PUD - PLANNED UNIT DEVELOPMENT

ABUTTING ZONING: WEST: INTERSTATE 75

EAST: PUD NORTH: PUD

1700 RANCH RD PROJECT ADDRESS: 2600 RUSTIC RD AND

SOUTH: INTERSTATE 75

0362-00-1002 & 0362-00-1007

PROJECT AREA: 15.85 ACRES

PROPOSED NUMBER OF UNITS SHOWN: 303 MULTI-FAMILY RENTAL APARTMENT HOMES WITH A 6.745 SQUARE FOOT AMENITY CENTER BUILDING

OVERALL DENSITY: 303 UNITS / 15.845 AC. = 19.12 UNITS PER ACRE (MAXIMUM ALLOWED = 304 UNITS TOTAL)

LAND USE:

BUILDING (MULTI-FAMILY APARTMENTS + AMENITY CENTER)	2.82 ACRES	(17.79%)
ROADS, SIDEWALKS, PAVERS AND PARKING	5.48 ACRES	(34.57%)
LAKES @ CONTROL WATER EL.	1.91 ACRES	(12.05%)
OTHER PERVIOUS AREA	5.64 ACRES	(35.58%)
TOTAL AREA	15.85 ACRES	(100%)

PROPOSED BUILDING SETBACKS: BUILDING SETBACK FROM I-75 EQUAL TO BUILDING HEIGHT (1:1)

RECLAIMED WATER: PROVIDED BY CITY OF VENICE.

WATER: POTABLE WATER SUPPLY WILL BE FROM CITY OF VENICE UTILITIES, BUT WILL BE MASTER METERED.

SEWER: WASTEWATER SERVICES WILL BE PROVIDED BY CITY OF VENICE UTILITIES.

GARBAGE: GARBAGE PICKUP WILL BE PROVIDED BY CITY OF VENICE.

ROADWAYS: ACCESS TO THIS PROJECT IS PROVIDED FROM RANCH ROAD, RUSTIC ROAD, AND CANOE BEND AVE.

PARKING LOT: TO BE PRIVATELY MAINTAINED.

LOADING ZONES REQUIRED: 6

LOADING ZONES PROVIDED: 6

EASEMENTS: REFER TO SHEETS A-4 AND A-6 THROUGH A-8 FOR EXISTING AND PROPOSED EASMENT INFORMATION.

TREE LOCATION: A TREE PERMIT WAS ISSUED FOR THIS PROJECT UNDER THE MASS GRADING PERMIT. REFER TO PLTR21-00285. 1050 INCHES NEW TREES ARE REQUIRED. REFER TO SEPARATE LANDSCAPE PLANS.

NOTE: THE SUBJECT PROPERTY LIES IN FLOOD ZONE "X" ACCORDING TO FLOOD INSURANCE RATE MAP FOR SARASOTA COUNTY, FLORIDA, COMMUNITY NO. 12115C0245F, DATED NOVEMBER 4, 2016, AND ISSUED BY THE FEDERAL EMERGENCY MANAGEMENT AGENCY. FEMA DATUM IS NORTH AMERICAN VERTICAL DATUM 1988 (NAVD 88).

ENVIRONMENTAL AND SURFACE WATER MANAGEMENT SYSTEM:

DRAINAGE SYSTEM WILL BE PRIVATELY MAINTAINED

WELLS: THERE ARE NO KNOWN EXISTING WELLS WITHIN THE PROJECT BOUNDARY

IMPERVIOUS/PERVIOUS AREAS:	ACRES	PERCENTAG
IMPERVIOUS AREA:	8.30	52.4%
PERVIOUS AREA (INCL. LAKE):	<u>7.55</u>	<u>47.6%</u>
TOTAL:	15.85	100%

ADA: ALL SIDEWALK STREET CROSSINGS AT CURBS, GUTTERS AND INTERSECTIONS SHALL COMPLY WITH THE AMERICANS WITH DISABILITIES ACT AND FLORIDA ACCESSIBILITY CODE.

LANDSCAPE PLANS: A TREE PERMIT WAS ISSUED FOR THIS PROJECT UNDER THE MASS GRADING PERMIT. REFER TO PLTR21-00285. 1050 INCHES

TREE MITIGATION PLANS: A TREE PERMIT WAS ISSUED FOR THIS PROJECT UNDER THE MASS GRADING PERMIT, REFER TO PLTR21-00285, 1050 INCHES NEW TREES ARE REQUIRED. REFER TO SEPARATE LANDSCAPE PLANS.

REQUIRED PARKING CALCULATION:

RESIDENTIAL USE: 2 SPACES PER UNIT

PRIVATE CLUBS: 1 SPACE PER THREE SEATS OR 1 SPACE PER 200 SQUARE FEET OF NON-STORAGE AREA

REQUIRED PARKING SPACES = 303 UNITS * 2 SPACES + 6,745 SF AMENITY CENTER * (1 SPACE PER 200 SF) = 606 SPACES + 34 SPACES TOTAL SPACES REQUIRED = 640 SPACES REQUIRED (13 ADA)

PARKING SPACES PROVIDED:

PROVIDED PARKING SPACES = 19 (ADJACENT TO AMENITY CENTER) + 24 (UNDER CARRIAGE HOMES) + 12 (2 GARAGES) + 430 (SURFACE) TOTAL SPACES PROVIDED = 485 SPACES PROVIDED (24 ADA) PARKING RATIO = 1.60

UTILITY COMPANIES:

TECO GAS 5657 NORTH McINTOSH 8261 VICO COURT SARASOTA, FLORIDA SARASOTA, FLORIDA 34240-7844 34233 COMCAST CABLE

5205 FRUITVILLE ROAD

SARASOTA, FLORIDA


FRONTIER 1701 RINGLING BLVD. SARASOTA, FLORIDA 941-906-6711

VENICE UTILITIES 401 W. VENICE AVE VENICE, FL 34285 (941)882-7297 CONTACT: PATIENCE ANATASIO

I HEREBY CERTIFY THAT THE DESIGN OF THIS PROJECT, AS PREPARED UNDER MY PERSONAL DIRECTION AND CONTROL, COMPLIES WITH ALL APPLICABLE STANDARDS, INCLUDING THE "MANUAL OF UNIFORM MINIMUM STANDARDS FOR DESIGN, CONSTRUCTION AND MAINTENANCE FOR STREETS AND HIGHWAYS" AS ADOPTED BY THE FLORIDA DEPARTMENT OF TRANSPORTATION PURSUANT TO SUBSECTIONS 335.075(1) AND (4), FLORIDA STATUTES.

DATE:

ANDREW J. PLUTA, P.E. FLA. P.E. LICENSE # 92225 CA. NO. 00035106

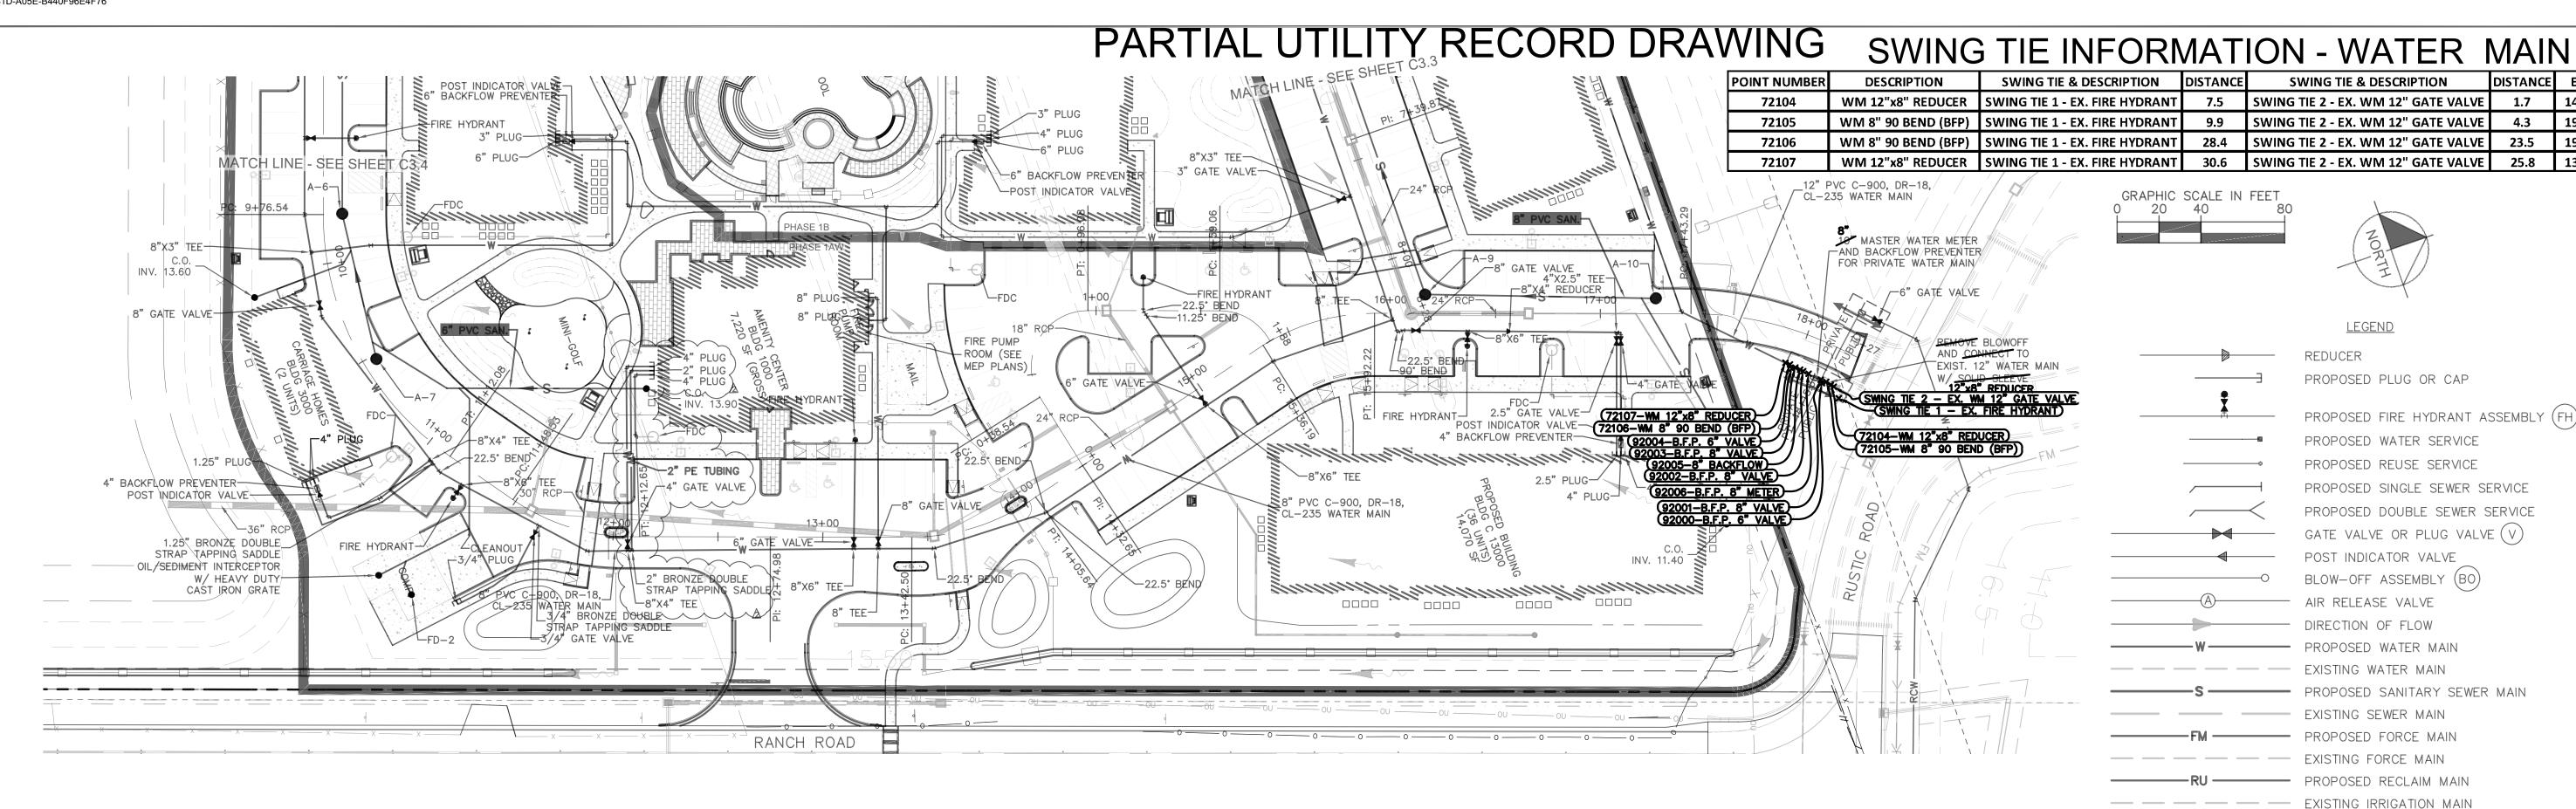

ALL WATER, A.S.L., IRRIGATION, AND FORCE MAINS SHALL HAVE 3' OF COVER UNLESS OTHERWISE NOTED.

ALL WATER AND IRRIGATION MAINS SHALL BE PVC, C-900, DR-18, UNLESS OTHERWISE NOTED.

SDR-26, UNLESS OTHERWISE NOTED. ALL VALVE COVERS AND/OR PADS THAT AREA WITHIN, ADJACENT TO OR IN CLOSE PROXIMITY TO SIDEWALK SHALL

ALL SANITARY SEWER MAINS AND SERVICES SHALL BE PVC,

ALL WATER MAINS LESS THAN OR EQUAL TO 2" SHALL BE PE TUBING.

BE ADJUSTED TO MATCH SIDEWALK GRADES.

20

-10

ALL VALVES TO BE INSTALLED OUTSIDE OF ALL CURBS.

ALL FIRE HYDRANTS SHALL BE LOCATED 5' (MIN.) TO 10' (MAX.) FROM EDGE OF PAVEMENT.

ALL PROFILES ARE ROTATED FOR CLARITY.

12+00

13+00

11 + 00

SEE UTILITY DETAIL DRAWINGS FOR WATER, IRRIGATION AND SEWER SERVICE TERMINATIONS.

ALL POST INDICATOR VALVES (PIVs) SHALL BE PLACED OUTSIDE OF SIDEWALKS. CONTRACTOR TO VERIFY FINAL PLACEMENT.

ALL FORCE MAINS SHALL BE PVC, C-900, DR-18, UNLESS OTHERWISE NOTED.

ALL WATER SERVICES ARE 1", UNLESS OTHERWISE NOTED. FIELD DEFLECT WATER MAIN TO CLEAR BEHIND INLETS WHERE REQUIRED.

WATER MAINS AND IRRIGATION MAINS SHALL BE 3' FROM RIGHT-OF-WAY LINE (TYPICAL), UNLESS OTHERWISE NOTED OR SHOWN.

10' WIDE UTILITY EASEMENTS ADJACENT TO ROAD RIGHT-OF-WAYS (BOTH SIDES).

RESTRAINED JOINT PIPE SHALL BE USED FOR THE WATER, A.S.L., IRRIGATION AND FORCE MAINS AS PER DETAILS ON SHEET C-5A.

ALL SINGLE AND DOUBLE WATER AND IRRIGATION SERVICES UNDER ROADWAYS ARE TO BE SLEEVED.

17 + 00

16 + 00

ALL WATER LINES SHALL BE PIGGED PRIOR TO CHLORINATION AND PRESSURE TESTING.

THE MAXIMUM ALLOWABLE PRESSURE PIPE DEFLECTION IS 75% OF THE MANUFACTURER'S RECOMMENDED MAXIMUM DEFLECTION.

UTILITY SYMBOLS ON THE PLAN MAY APPEAR LARGER THAN ACTUAL SIZE OR MOVED FROM INTENDED LOCATION FOR CLARITY. UTILITY APPURTENANCES ARE TO BE INSTALLED PER DETAILS IN PLAN SET OR REFERENCED STANDARD DETAILS.

20

-10

18+0018+25

CALL 2 WORKING DAYS BEFORE YOU DIG

IT'S THE LAW! Know what's **below**. **DIAL 811**

DISTANCE

28.4

30.6

SWING TIE & DESCRIPTION

SWING TIE 2 - EX. WM 12" GATE VALVE

SWING TIE 2 - EX. WM 12" GATE VALVE

SWING TIE 2 - EX. WM 12" GATE VALVE

SWING TIE 2 - EX. WM 12" GATE VALVE

LEGEND

PROPOSED PLUG OR CAP

PROPOSED WATER SERVICE PROPOSED REUSE SERVICE

POST INDICATOR VALVE

— AIR RELEASE VALVE

- EXISTING WATER MAIN

EXISTING SEWER MAIN FM ----- PROPOSED FORCE MAIN

DIRECTION OF FLOW --- PROPOSED WATER MAIN

BLOW-OFF ASSEMBLY (BO)

PROPOSED SANITARY SEWER MAIN

PROPOSED SINGLE SEWER SERVICE

PROPOSED DOUBLE SEWER SERVICE

GATE VALVE OR PLUG VALVE (V)

PROPOSED FIRE HYDRANT ASSEMBLY (FH)

REDUCER

DISTANCE EL

19.8

19.7

13.4

DRAWING AND

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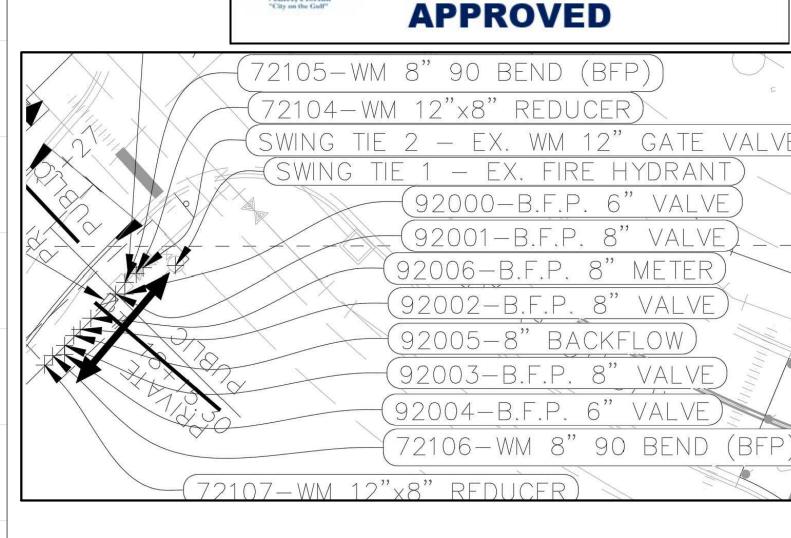
1.7

4.3

25.8

Call before you diq. SUNSHINE STATE ONE CALL OF FLORIDA, INC.

RECORD DRAWINGS March 4, 2024



_8" PVC C-900, DR-18, CL-235 WATER MAIN -PROPOSED GRADE _4" PVC C-900, DR-18, CL-235 WATER MAIN -PROPOSED GRADE EXISTING GROUND __4'_COVER_ABOVE_PIPE 3' COVER ABOVE PIPE 8" PVC C-900, DR-18, CL-235 WATER MAIN LEXISTING GROUND 12 _8" PVC C-900, DR-18, CL-235 WATER MAIN _8" PVC C-900, DR-18, CL-235 WATER MAIN 110 LF OF 8" PVC SDR-26 @ 0.50% 8" PVC @ 0.50% 24" RCP-30" RCP-SWING TIE INFORMATION - MASTER BACKFLOW ASY. POINT NUMBER DESCRIPTION SWING TIE & DESCRIPTION DISTANCE **SWING TIE & DESCRIPTION** DISTANCE EL **SWING TIE 2 - EX. WM 12" GATE VALVE** 92000 B.F.P. 6" VALVE SWING TIE 1 - EX. FIRE HYDRANT 10.8 SWING TIE 2 - EX. WM 12" GATE VALVE 7.0 22.7 92001 B.F.P. 8" VALVE SWING TIE 1 - EX. FIRE HYDRANT 12.3 -4 SWING TIE 2 - EX. WM 12" GATE VALVE 92002 B.F.P. 8"VALVE SWING TIE 1 - EX. FIRE HYDRANT 22.6 21.4 20.5 22.6 92003 B.F.P. 8"VALVE WING TIE 1 - EX. FIRE HYDRANT 25.4 SWING TIE 2 - EX. WM 12" GATE VALVE 21.8 22.1 92004 B.F.P. 6" VALVE SWING TIE 1 - EX. FIRE HYDRANT SWING TIE 2 - EX. WM 12" GATE VALVE 18.0 20.8 92005 8" BACKFLOW SWING TIE 1 - EX. FIRE HYDRANT 23.0 SWING TIE 2 - EX. WM 12" GATE VALVE **SWING TIE 2 - EX. WM 12" GATE VALVE** -8 92006 B.F.P. 8" METER

14+00

ALIGNMENT "B" PROFILE HORZ. 1" = 40'

15+00

VERT. 1" = 4

PARTIAL UTILITY RECORD DRAWING P#INT BREAK SURVEYING, LLC

Deffery & Morrow


8111 Blaikie Court, Suite E Sarasota, Fl 34240 Phone: (941) 378-4797 Fax: (941) 378-0058


HEREBY CERTIFY THAT THE AS-BUILT MEASUREMENTS SHOWN HEREON ARE TRUE AND CORRECT TO THE BEST OF MY KNOWLEDGE AND BELIEF AS SURVEYED IN THE FIELD UNDER MY DIRECTION, TOGETHER WITH AS-BUILT MEASUREMENTS FROM MARKERS POSITIONED AND INFORMATION PROVIDED CONTRACTOR. DATE OF LAST FIELD MEASUREMENTS: 12/15/23

NO. 6296 HIS ITEM HAS BEEN ELECTRONICALLY SIGNED AND SEALED BY JEFFERY MORROW P.S.M. USING A DIGITAL SIGNATURE. PRINTED COPIES OF THIS DOCUMENT ARE NOT CONSIDERED SIGNED AND SEALED AND THE

RANC M

SHEET NUMBER

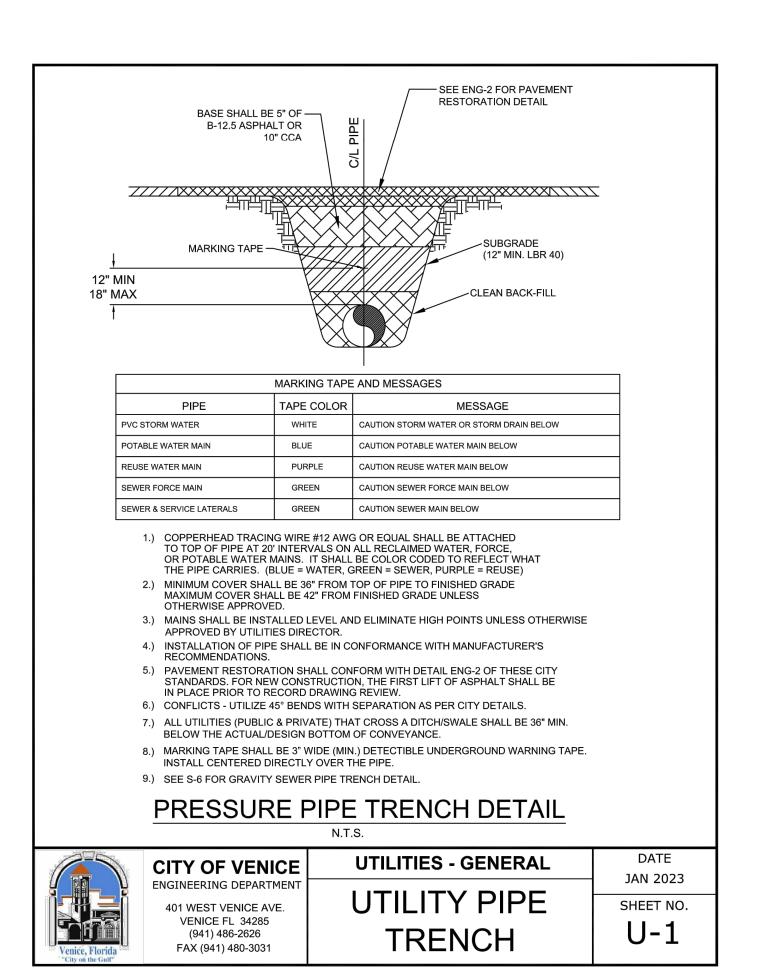

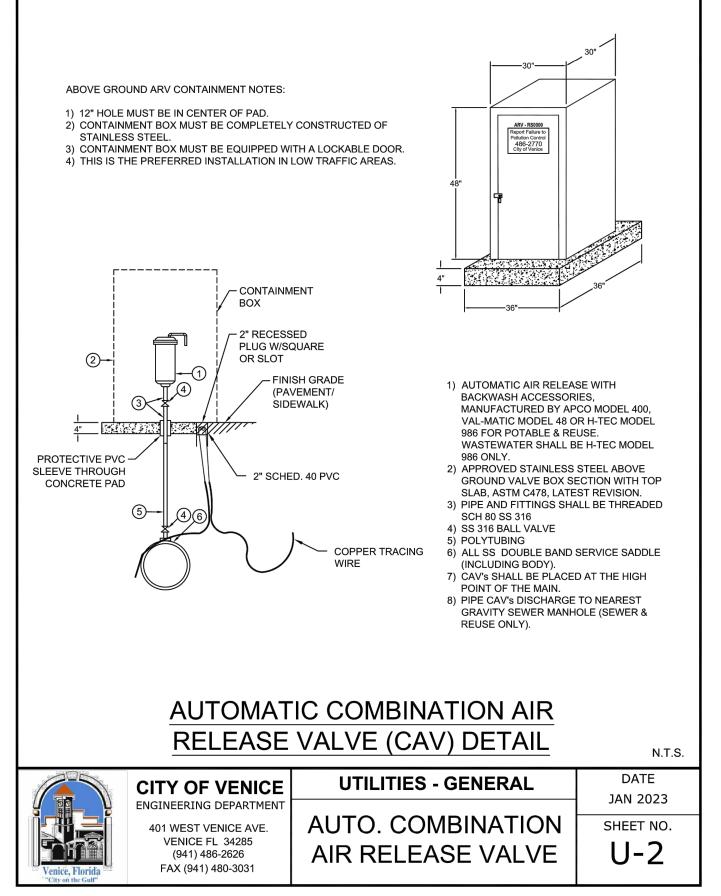

1.) ALL PIPE FITTINGS SHALL BE COMPACT, DUCTILE IRON.

FUSION BONDED EPOXY COATED INSIDE AND OUT.

COLOR

BLUE

WHITE

PURPLE

GREEN

5.) ALL FITTINGS FOR SANITARY SEWER SHALL BE HEAVY WALL

) ALL HARDWARE SHALL BE 316 SS.

SERVICE

POTABLE WATER MAIN

RAW WATER MAIN

(MIN. 4" DIAMETER)

REUSE MAIN

FORCE MAIN

ALL APPLICATIONS (RAW, POTABLE, REUSE, SEWER) SHALL BE

ALL FITTINGS SHALL MEET ANSI/AWWA C116/A21.16 STANDARDS.

PIPE FITTINGS

MATERIAL/CLASS

AWWA C900 PVC / DR 18

FUSIBLE C900 PVC / DR 18

CERT-A-LOK C900 PVC / DR 18


HDPE PPI PE 4710 / DR 11 / DIPS


(WITH UTILITIES DEPARTMENT APPROVAL)


JAN 2023

SHEET NO.

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CENTERED AT THE POINT OF CROSSING.

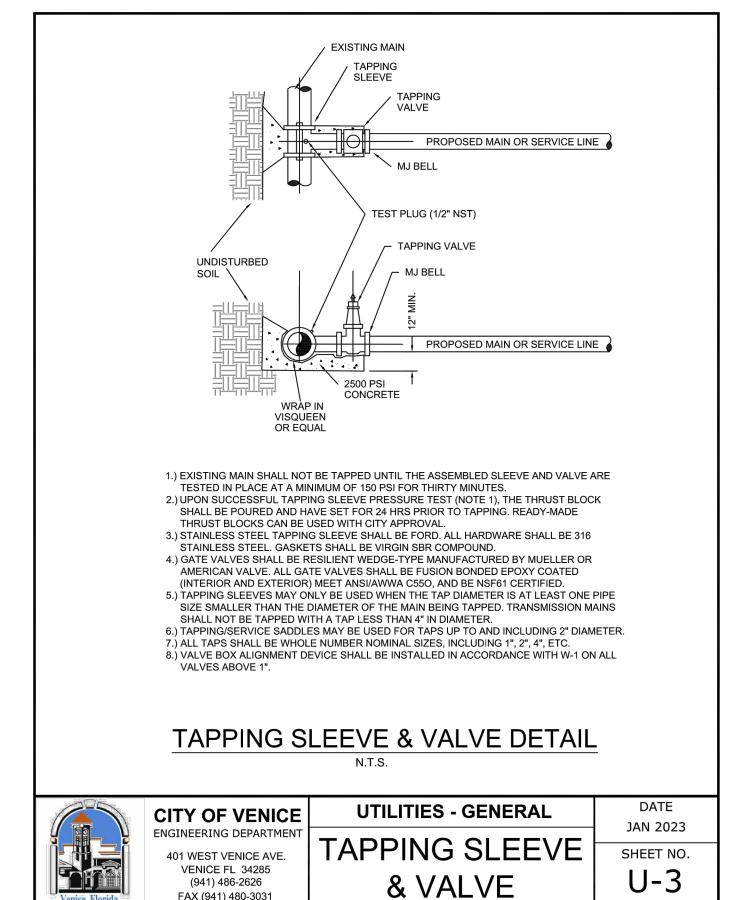CITY OF VENICE

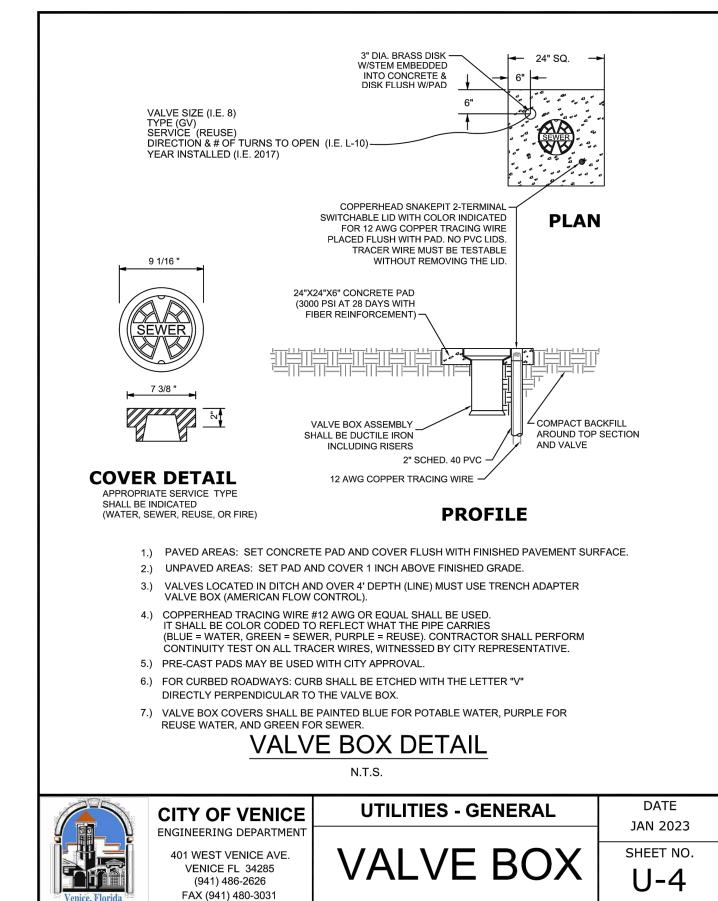
ENGINEERING DEPARTMENT

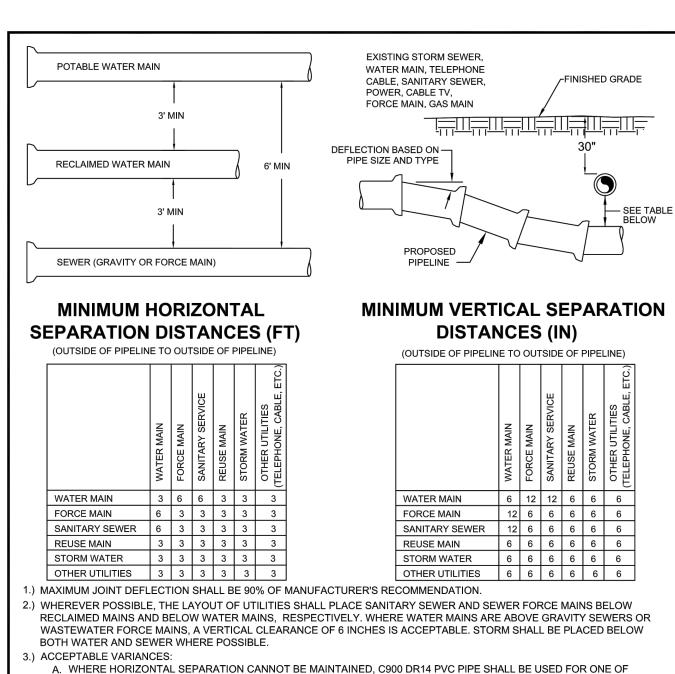
401 WEST VENICE AVE

VENICE FL 34285

(941) 486-2626

FAX (941) 480-3031

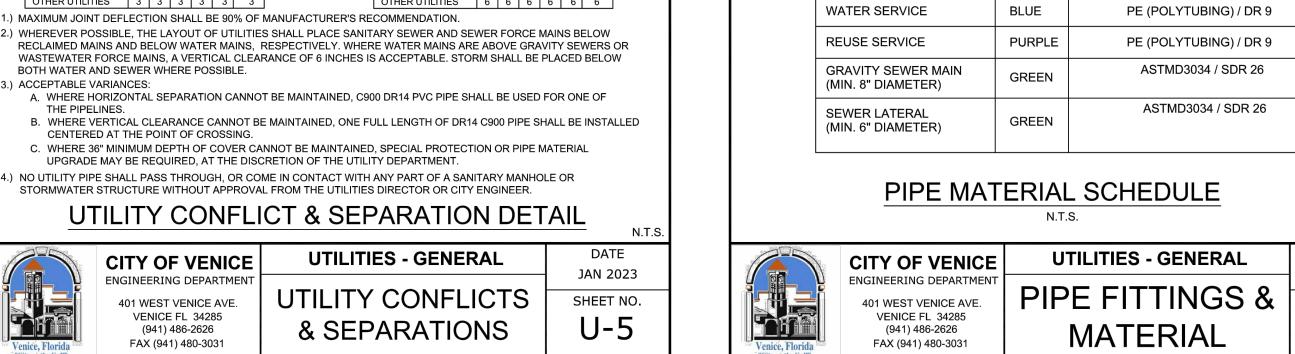

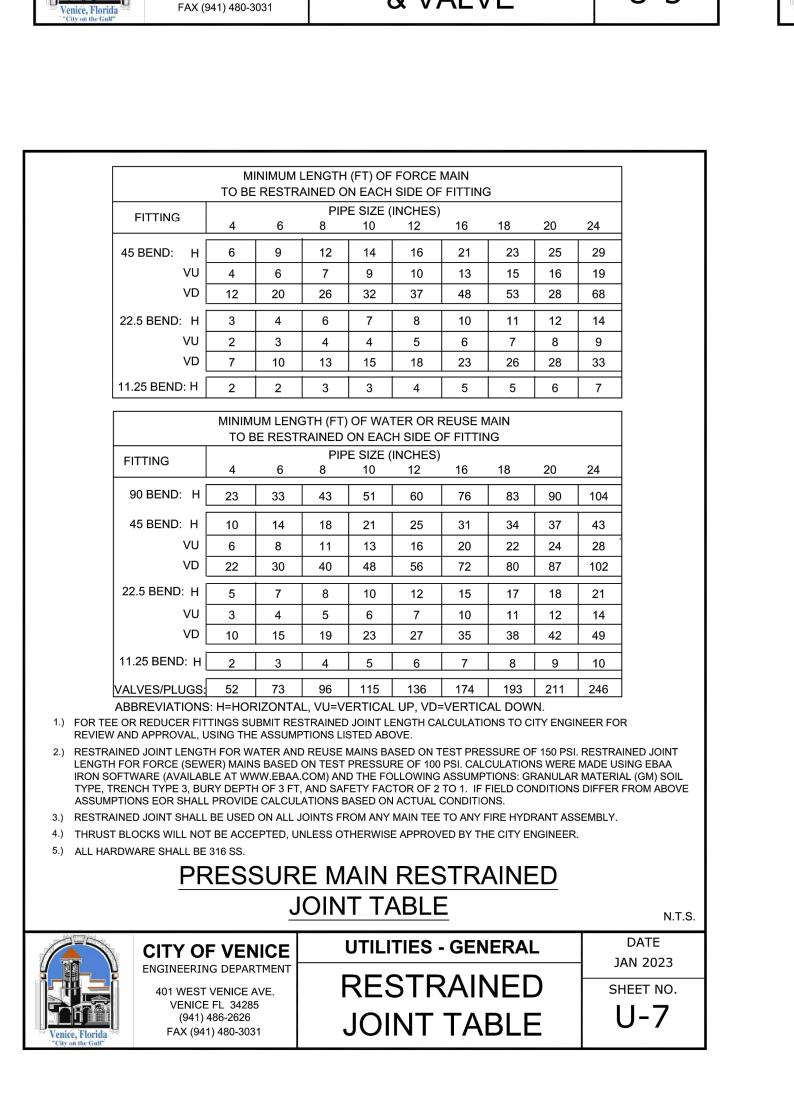





NICE **(**)


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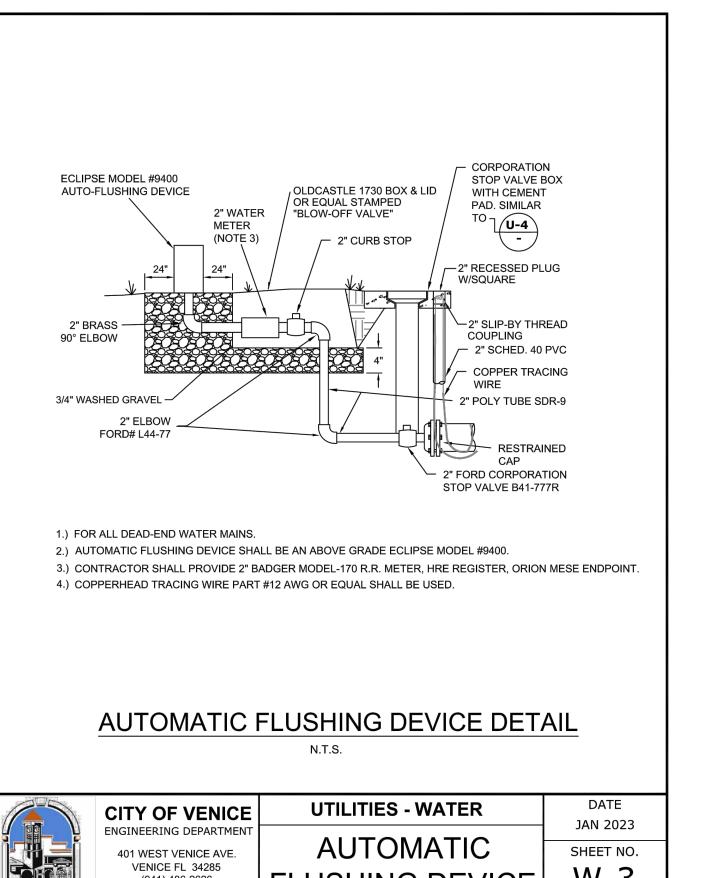
SHEET NUMBER


C3.8



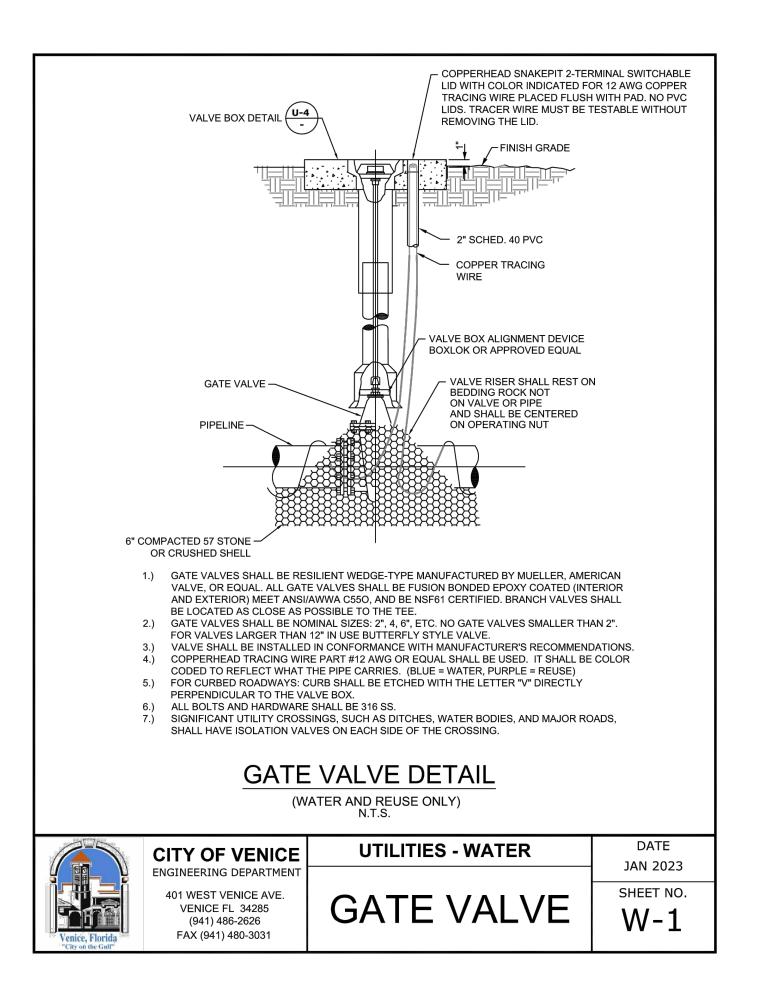

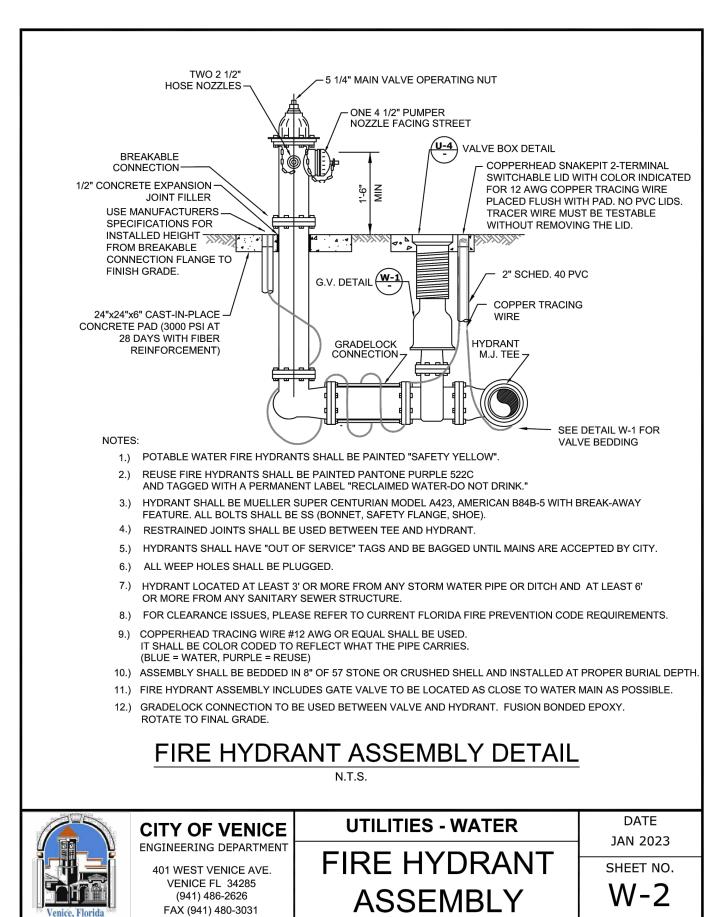

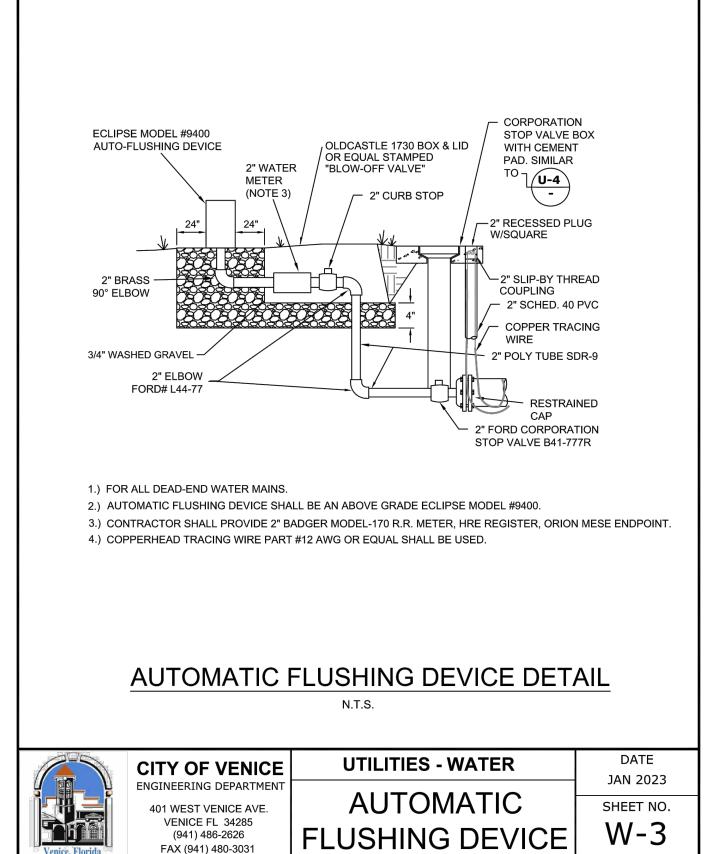

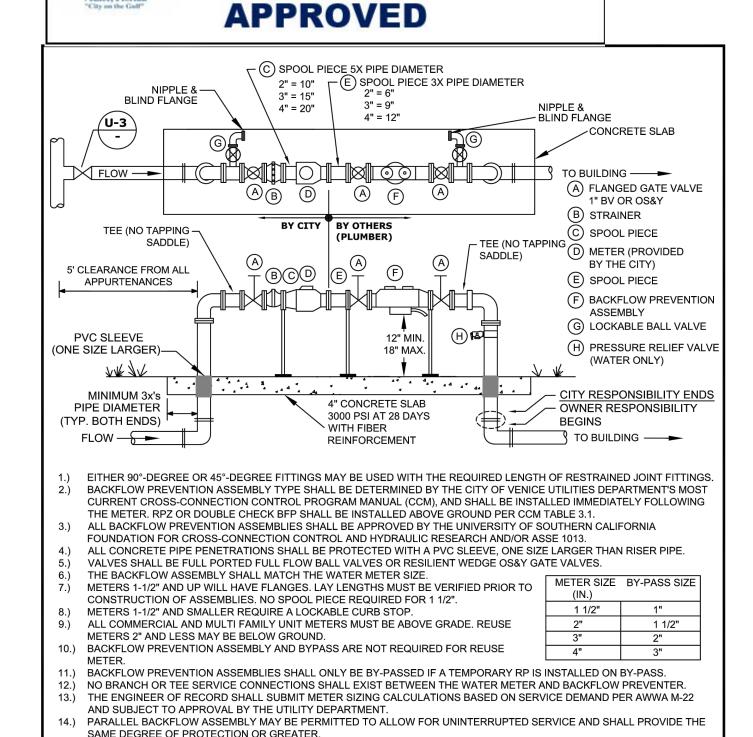


RECORD DRAWINGS


March 4, 2024

ABOVE GROUND METER, 2" & LARGER DATE **UTILITIES - WATER** CITY OF VENICE JAN 2023

REUSE METER, WATER METER, & BACKFLOW PREVENTION ASSEMBLY

15.) NO PVC SHALL BE PERMITTED ON THE CITY SIDE.

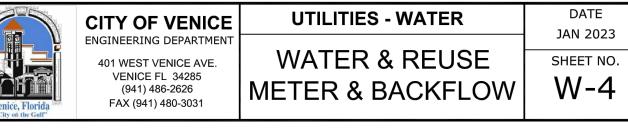

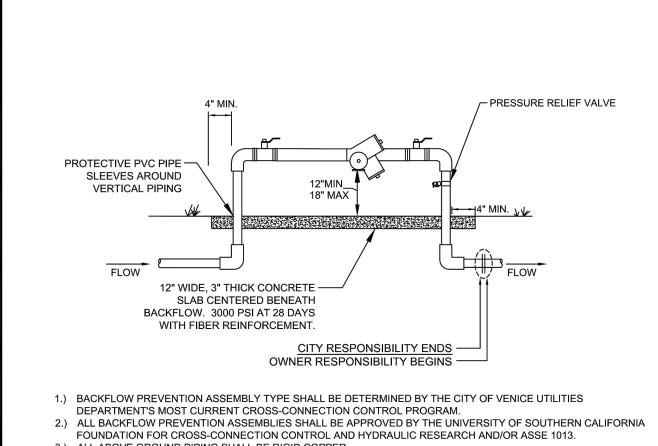


- 3.) ALL ABOVE GROUND PIPING SHALL BE RIGID COPPER 4.) THE WATER METER AND BACKFLOW PREVENTER SHALL BE THE SAME SIZE.
- 5.) INSTALLED IMMEDIATELY AFTER THE UTILITY WATER METER, PER THE CROSS CONNECTION CONTROL MANUAL UNLESS OTHERWISE APPROVED IN WRITING BY THE CITY OF VENICE UTILITIES DIRECTOR AND WITH A SIGNED
- WAIVER AGREEMENT BY THE CUSTOMER. 6.) NO BRANCH OR TEE CONNECTIONS SHALL EXIST BETWEEN THE WATER METER AND BACKFLOW PREVENTER.
- 7.) ALL METER BOXES SHALL BE SET FLUSH WITH FINISHED GRADE. 8.) SHEETING SHALL BE A PVC TYPE MATERIAL WITH A MINIMUM OF 40 MIL. THICKNESS.
- 9.) PROTECTIVE PIPE SLEEVES SHALL BE PVC PIPE ONE SIZE LARGER THAN RISER OR OTHER CITY APPROVED


ABOVE GROUND BACKFLOW PREVENTION ASSEMBLY


10.) PRESSURE RELIEF VALVE SHALL BE INSTALLED. 11.) LINE DOWNSTREAM OF METER AND PRIOR TO BACKFLOW SHALL BE POLYETHYLENE.


12.) NO PVC SMALLER THAN 4" DIAMETER SHALL BE INSTALLED ON CITY-OWNED UTILITIES

	CITY OF VENICE	UTILITIES - WATER	DATE JAN 2023
Venice, Florida "City on the Gulf"	ENGINEERING DEPARTMENT 401 WEST VENICE AVE. VENICE FL 34285 (941) 486-2626 FAX (941) 480-3031	BACKFLOW ASSEMBLY (NO MASTER METER)	SHEET NO. W-5

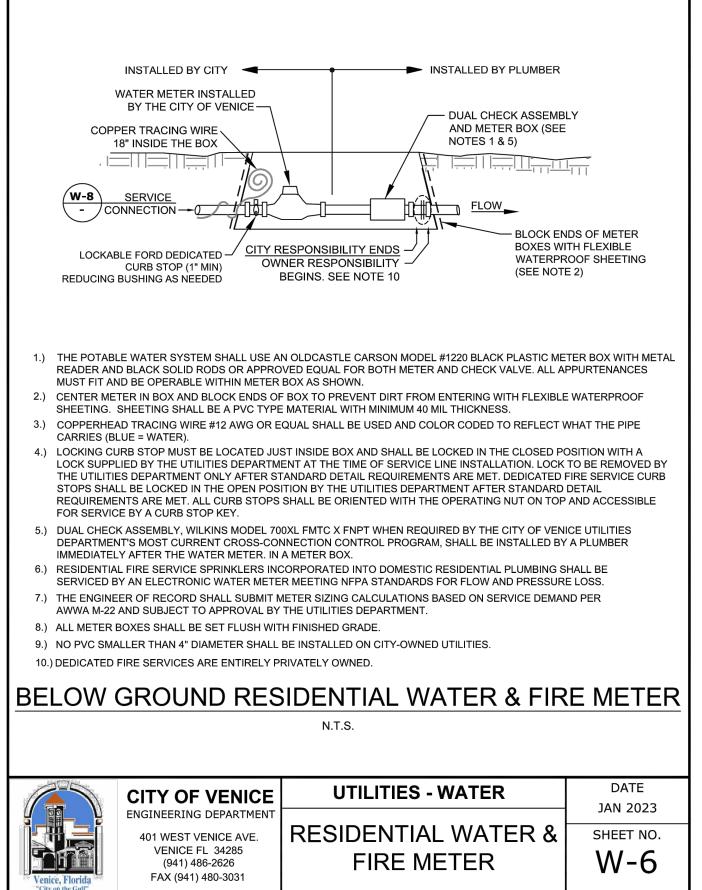

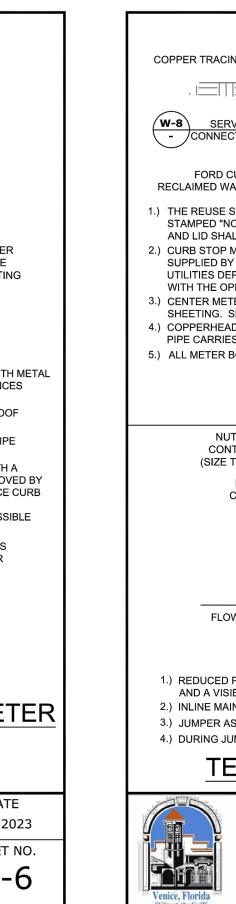

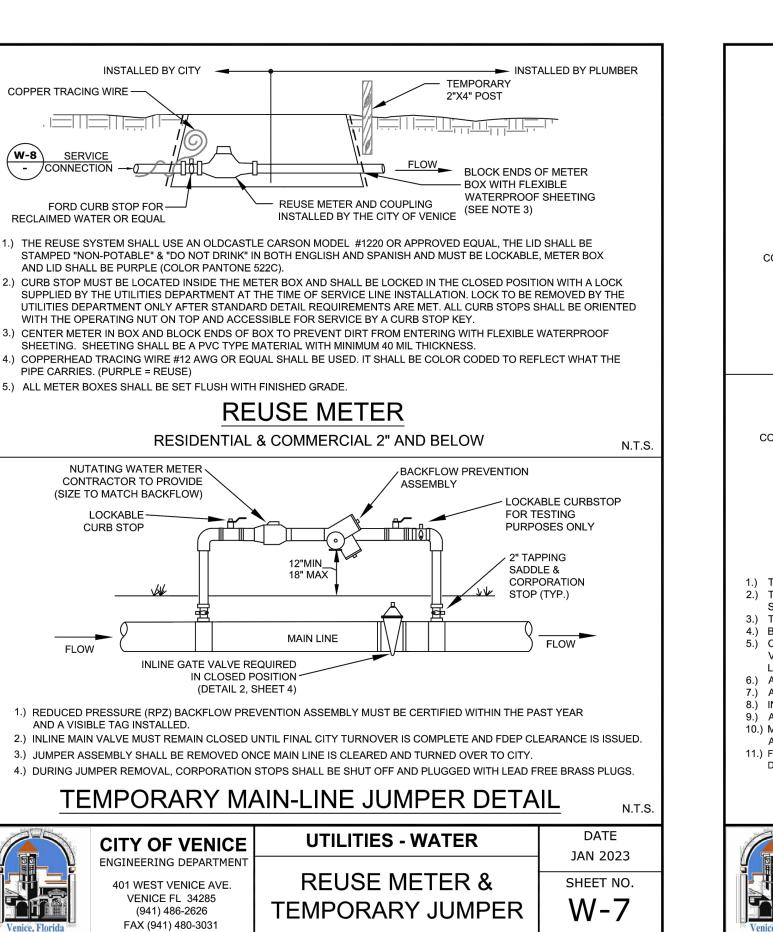

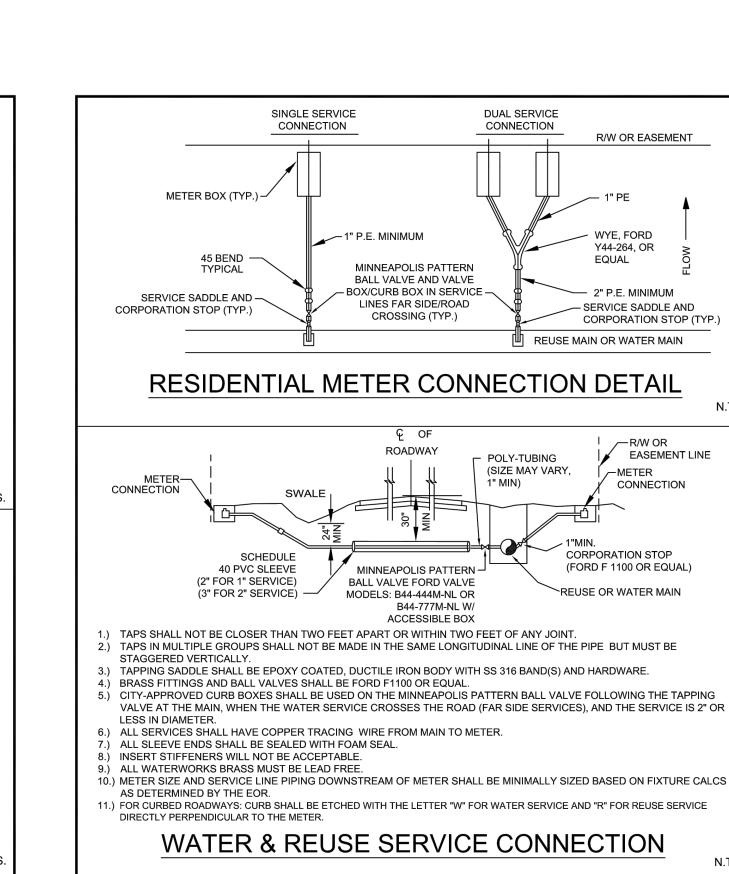

CITY OF VENICE


ENGINEERING DEPARTMENT

401 WEST VENICE AVE.

VENICE FL 34285

(941) 486-2626

FAX (941) 480-3031

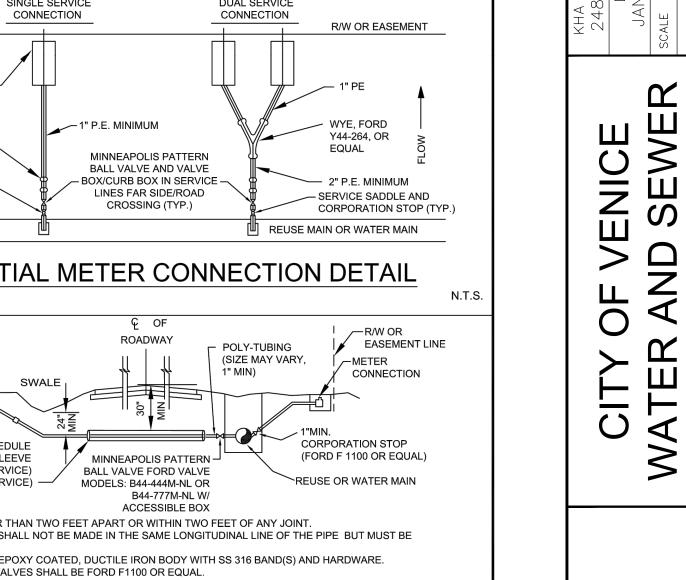

UTILITIES - WATER

RESIDENTIAL METER &

SERVICE CONNECTION

JAN 2023

SHEET NO.

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SHEET NUMBER C3.9