






GENERAL NOTES:

- A. ALL EXTERIOR LIGHTING SHALL BE AUTOMATICALLY CONTROLLED BY A COMBINATION OF A PHOTOCELL AND AN ASTRONOMICAL TIME SWITCH, CAPABLE OF TURNING OFF LIGHTS WHEN DAYLIGHT IS PRESENT OR DURING NON-OCCUPIED HOURS (8:00 AM TO 5:00 PM), IN ACCORDANCE WITH FBC ENERGY CONSERVATION §C405.2.5 AND ASHRAE 90.1 §9.4.1.4.
- B. AUTOMATIC CONTROLS SHALL BE CONFIGURED TO REDUCE LIGHTING POWER BY AT LEAST 30% DURING OFF-PEAK HOURS SUCH AS MIDNIGHT TO 5 A.M., OR WHEN THE SPACE IS VACANT. (FBC §C405.2.6; ASHRAE 90.1 §9.4.1.1.2)
- C. EXTERIOR LIGHTING POWER DENSITY (LPD) SHALL NOT EXCEED THE MAXIMUM VALUES LISTED IN FBC TABLE C405.5.2(2); (FBC §C405.5.2; ASHRAE 90.1 TABLE 9.4.2.2)
- D. LUMINAIRES INSTALLED FOR EXTERIOR APPLICATIONS SHALL BE FULL CUTOFF OR SHIELDED TO MINIMIZE LIGHT TRESPASS AND GLARE ONTO ADJACENT PROPERTIES AND THE NIGHT SKY.
- E. THESE DRAWINGS ARE PROVIDED FOR LIGHTING LAYOUT AND ILLUMINANCE MODELING PURPOSES ONLY. LIGHT LEVEL CALCULATIONS HAVE BEEN PREPARED TO DEMONSTRATE COMPLIANCE WITH APPLICABLE CODES: IESNA RECOMMENDATIONS, AND LOCAL JURISDICTIONAL REQUIREMENTS.
- F. FIXTURE LOCATIONS, ORIENTATIONS, AND MOUNTING HEIGHTS SHOWN ARE INTENDED FOR PHOTOMETRIC MODELING AND MAY NOT REFLECT FINAL ELECTRICAL CONSTRUCTION CONDITIONS.
- G. FINAL CIRCUITING, CONDUIT ROUTING, WIRING METHODS, SWITCHING ARRANGEMENTS, AND ELECTRICAL COMPONENT COORDINATION SHALL BE PER THE APPROVED ELECTRICAL PERMIT DRAWINGS AND DETAILS.
- H. CONTRACTOR SHALL COORDINATE MOUNTING HEIGHTS, MOUNTING DETAILS, CONTROL DEVICES, AND POWER REQUIREMENTS PRIOR TO ROUGH-IN AND INSTALLATION.
- I. ALL LIGHT FIXTURES SHALL OPERATE IN A BLEVEL MODE. LIGHT OUTPUT SHALL BE AUTOMATICALLY DIMMED TO 50% DURING PERIODS OF NO OCCUPANCY AND SHALL INCREASE TO FULL OUTPUT UPON OCCUPANT OR VEHICLE DETECTION. AFTER A SET TIMEOUT PERIOD, FIXTURES SHALL RETURN TO THE DIMMED STATE. FIXTURE CONTROLS SHALL BE PROGRAMMED TO COMPLY WITH ALL APPLICABLE ENERGY AND LIGHTING CODES INCLUDING LOCAL ORDINANCES.
- J. PROFESSIONAL UNITS HOURS OF OPERATIONS 8AM-5PM.

LIGHT FIXTURE SPECIFICATIONS:

FIXTURE: F1A  
MANUFACTURER: EURI LIGHTING  
MODEL: EFL-130W-MD  
LUMENS: 1200 LUMENS  
COLOR TEMPERATURE: 3000K  
INPUT VOLTAGE: 120VAC  
POWER CONSUMPTION: 12.5W  
CONTROLS: INTEGRAL DISK-TO-DAWN SENSOR WITH TIME SWITCH OVERRIDE AND AUTOMATIC TRANSITION FROM DIMMED TO FULL BRIGHTNESS UPON MOTION DETECTION

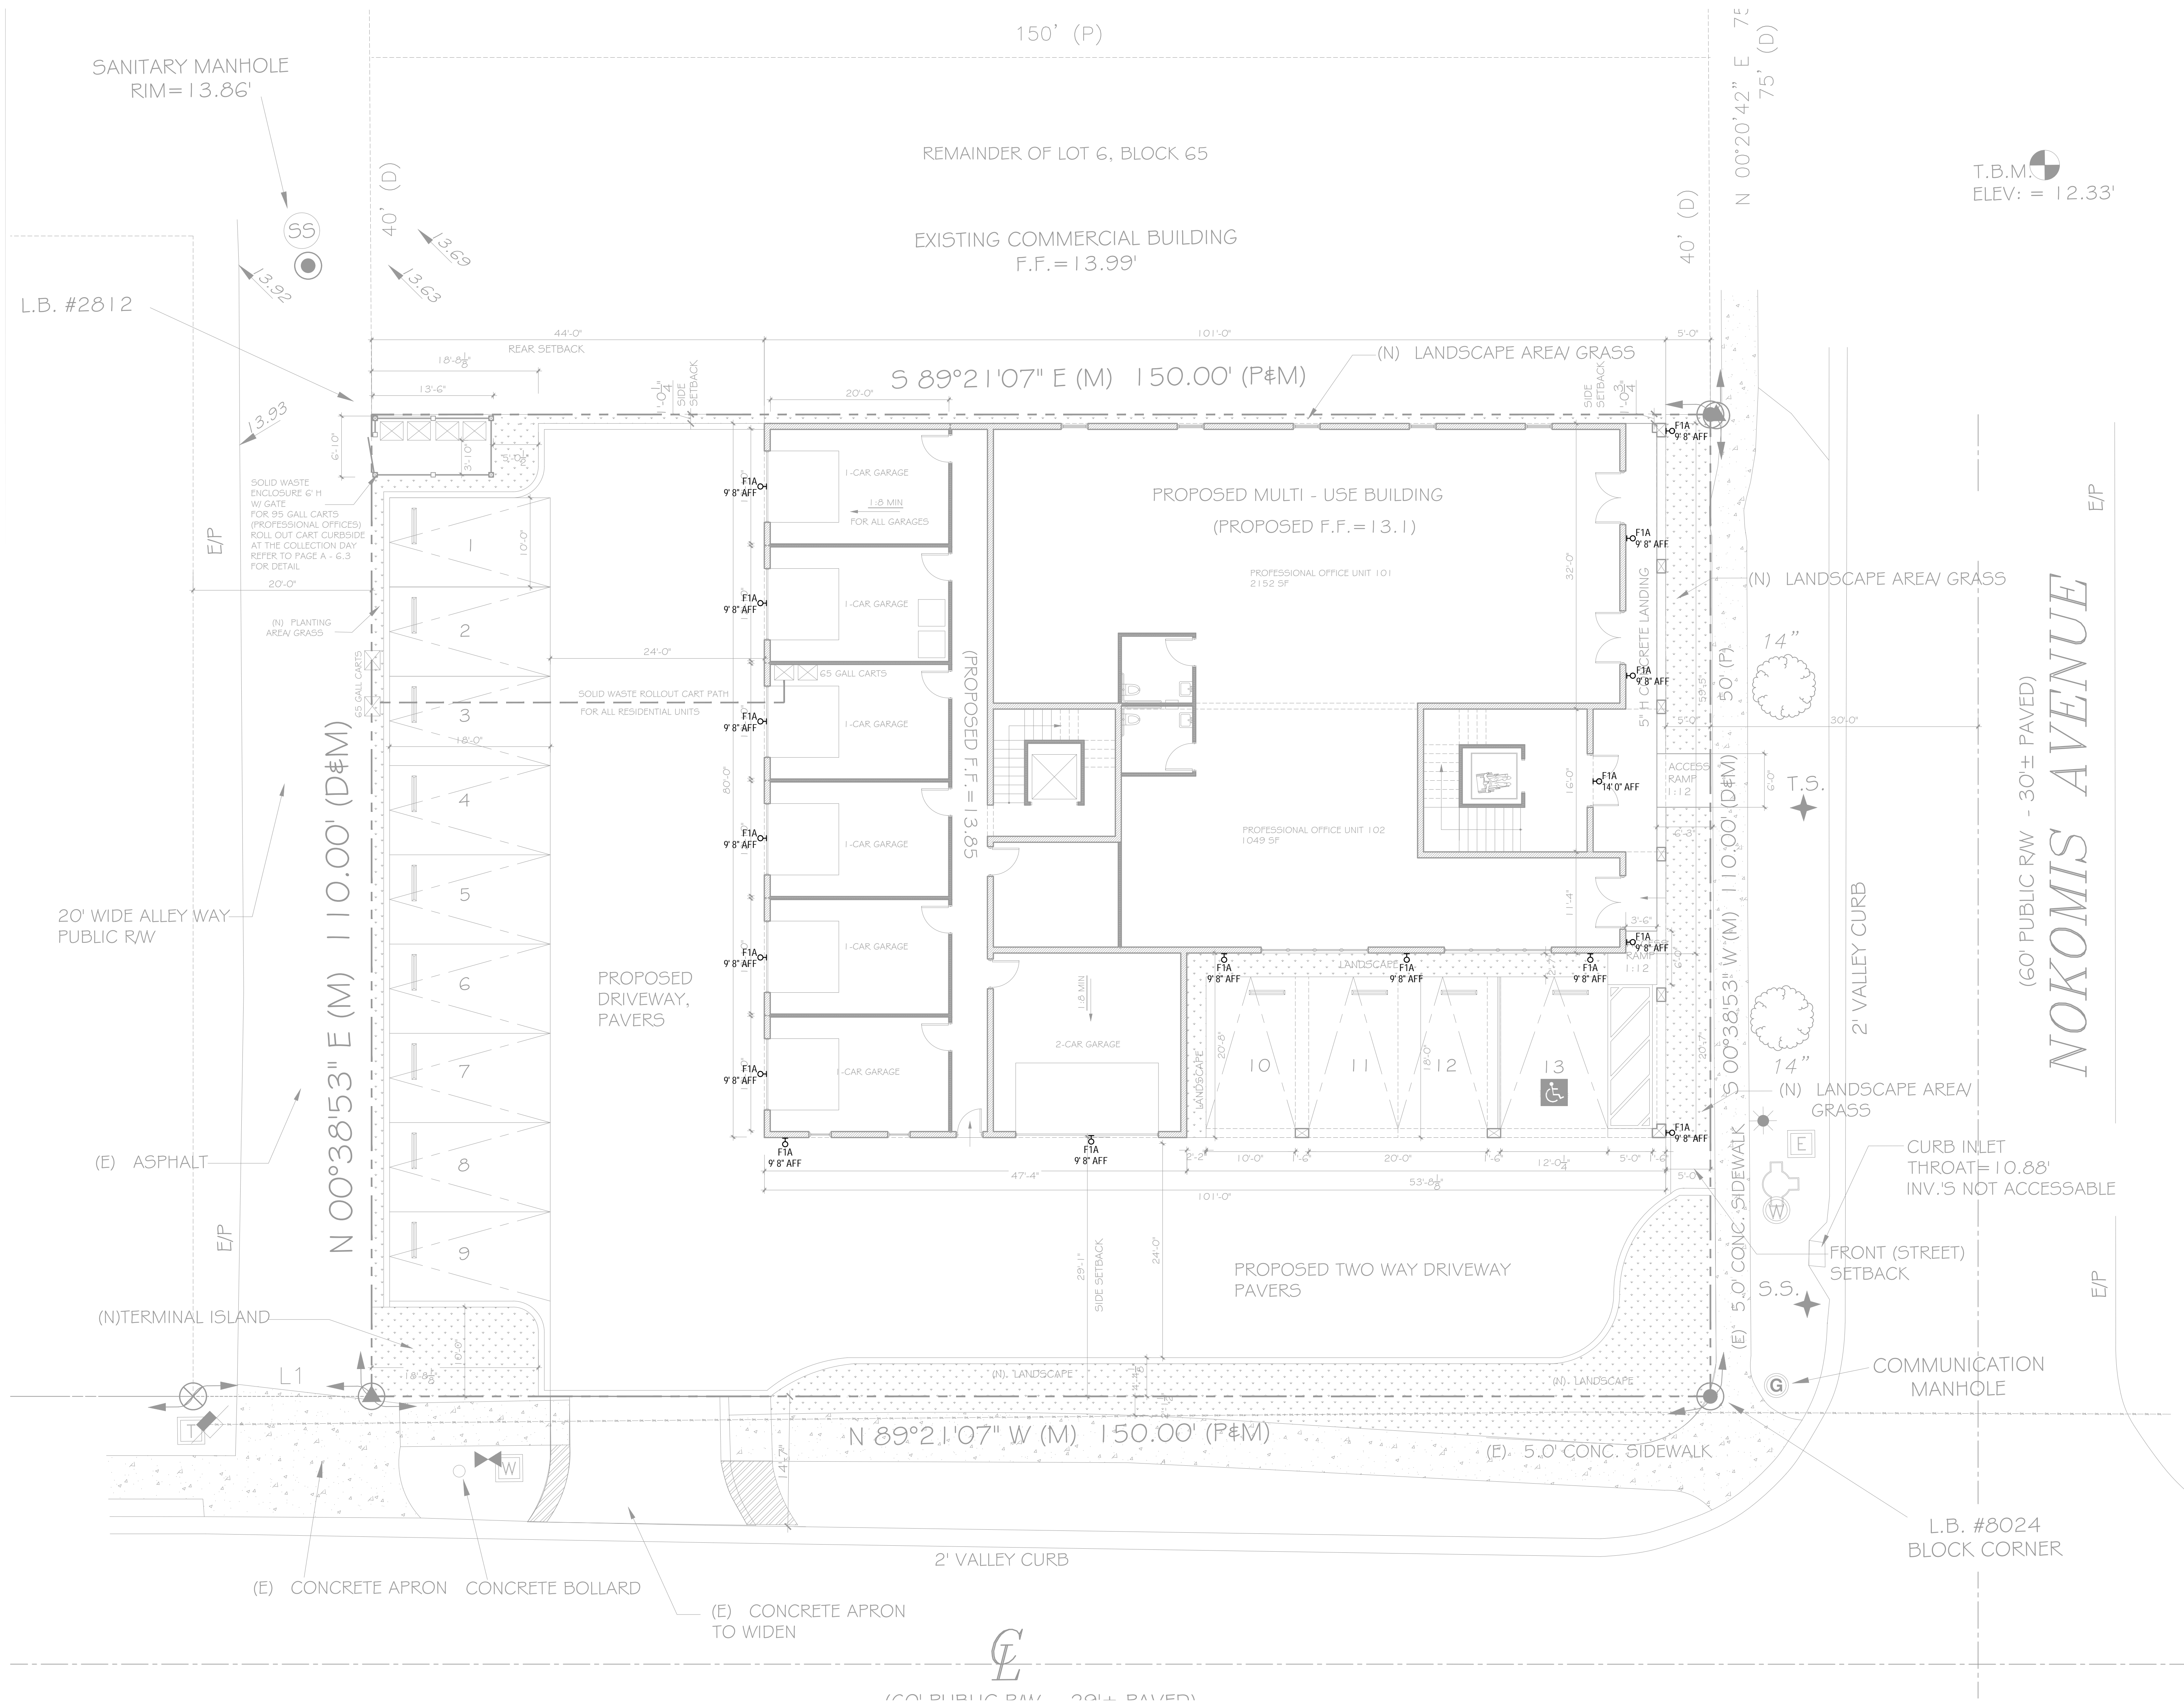



**GENERAL NOTES:**

A. THIS SHEET IS TO REFLECT PHOTOMETRIC CALCULATIONS ONLY.

1. EXTERIOR LIGHTING POWER DENSITY (LPD) SHALL NOT EXCEED THE MAXIMUM VALUES LISTED IN FBC TABLE C405.5.2(2). (FBC C405.5.2; ASHRAE 90.1 TABLE 9.4.2-2)

2. LUMINAIRES INSTALLED FOR EXTERIOR APPLICATIONS SHALL BE FULL CUTOFF OR SHIELDED TO MINIMIZE LIGHT TRESPASS AND GLARE ONO ADJACENT PROPERTIES AND THE NIGHT SKY.

3. THESE DRAWINGS ARE PROVIDED FOR LIGHTING LAYOUT AND ILLUMINANCE CALCULATIONS. LIGHT LEVEL CALCULATIONS HAVE BEEN PREPARED TO DEMONSTRATE COMPLIANCE WITH APPLICABLE CODES, IESNA RECOMMENDATIONS, AND LOCAL JURISDICTIONAL REQUIREMENTS.

E. ALL LIGHT FIXTURES SHALL OPERATE IN A B-LEVEL MODE. LIGHT OUTPUT SHALL BE AUTOMATICALLY DIMMED TO 50% DURING PERIODS OF NO OCCUPANCY AND SHALL INCREASE TO FULL OUTPUT UPON OCCUPANT OR VEHICLE DETECTION. AFTER A SET TIMEOUT PERIOD, FIXTURES SHALL RETURN TO THE DIMMED STATE. FIXTURE CONTROLS SHALL BE PROGRAMMED TO COMPLY WITH ALL APPLICABLE ENERGY AND LIGHTING CODES INCLUDING LOCAL ORDINANCES.

F. ALL EXTERIOR LIGHTING SHALL BE AUTOMATICALLY CONTROLLED BY A COMBINATION OF A PHOTOCELL AND AN ASTRONOMICAL TIME SWITCH, CAPABLE OF TURNING OFF LIGHTS WHEN DAYLIGHT IS PRESENT OR DURING NON-OCCUPIED HOURS (8:00 AM TO 5:00 PM), IN ACCORDANCE WITH FBC ENERGY CONSERVATION C404.5.25 AND ASHRAE 90.1 9.4.1.4.

## KEY NOTES

1. LIGHT LEVELS WITHIN 10 FT OF SITE PERIMETER EXCEED TYPICAL LIMITS DUE TO REQUIRED ILLUMINATION OF EGRESS PATHS AND EXTERIOR EXITS. FIXTURES SHALL BE CONTROLLED VIA PHOTOCELL AND ASTRONOMICAL TIME SWITCH PER FBC §C405.2.5 AND ASHRAE 90.1 §9.4.1.4, TURNING OFF DURING DAYLIGHT/NON-OCCUPIED HOURS (8:00 AM-5:00 PM). FIXTURES SHALL DIM TO 50% OUTPUT WHEN UNOCCUPIED.

### LIGHT FIXTURE SPECIFICATIONS:

**FIXTURE: F1A**  
**MANUFACTURER: EURI LIGHTING**  
**MODEL: EFL-130W-MD**  
**LUMENS: 1200 LUMENS**  
**COLOR TEMPERATURE: 3000K**  
**INPUT VOLTAGE: 120VAC**  
**POWER CONSUMPTION: 12.5W**  
**CONTROLS: INTEGRAL DUSK-TO-DAWN SENSOR WITH TIME-SWITCH OVERRI**  
**AND AUTOMATIC TRANSITION FROM DIMMED TO FULL BRIGHTNESS UPON**  
**MOTION DETECTION.**



Calculation Summary							
Label	CalcType	Units	Avg	Max	Min	Avg/Min	Max/Min
ENTRY	Illuminance	Fc	6.20	7.0	5.4	1.30	
PARKING LOT	Illuminance	Fc	1.63	5.7	0.2	8.15	28.50
SIZE PERIMETER	Illuminance	Fc	0.34	1.6	0.0	N.A.	N.A.
UNDER COVER PARKING	Illuminance	Fc	5.67	5.9	5.4	1.05	1.09




GENERAL NOTES:

- A. ALL EXTERIOR LIGHTING SHALL BE AUTOMATICALLY CONTROLLED BY A COMBINATION OF A PHOTOCELL AND AN ASTRONOMICAL TIME SWITCH, CAPABLE OF TURNING OFF LIGHTS WHEN DAYLIGHT IS PRESENT OR DURING NON-OCCUPIED HOURS (8:00 AM TO 5:00 PM), IN ACCORDANCE WITH FBC ENERGY CONSERVATION §C405.2.5 AND ASHRAE 90.1 §9.4.1.4.
- B. AUTOMATIC CONTROLS SHALL BE CONFIGURED TO REDUCE LIGHTING POWER BY AT LEAST 30% DURING OFF-PEAK HOURS SUCH AS MIDNIGHT TO 6 A.M., OR WHEN THE SPACE IS VACANT. (FBC §C405.2.6; ASHRAE 90.1 §9.4.1.1.2)
- C. EXTERIOR LIGHTING POWER DENSITY (LPD) SHALL NOT EXCEED THE MAXIMUM VALUES LISTED IN FBC TABLE C405.5.2(2); (FBC §C405.5.2; ASHRAE 90.1 TABLE 9.4.2.2)
- D. LUMINAIRES INSTALLED FOR EXTERIOR APPLICATIONS SHALL BE FULL CUTOFF OR SHIELDED TO MINIMIZE LIGHT TRESPASS AND GLARE ONTO ADJACENT PROPERTIES AND THE NIGHT SKY.
- E. THESE DRAWINGS ARE PROVIDED FOR LIGHTING LAYOUT AND ILLUMINANCE MODELING PURPOSES ONLY. LIGHT LEVEL CALCULATIONS HAVE BEEN PREPARED TO DEMONSTRATE COMPLIANCE WITH APPLICABLE CODES, IESNA RECOMMENDATIONS, AND LOCAL JURISDICTIONAL REQUIREMENTS.
- F. FIXTURE LOCATIONS, ORIENTATIONS, AND MOUNTING HEIGHTS SHOWN ARE INTENDED FOR PHOTOMETRIC MODELING AND MAY NOT REFLECT FINAL ELECTRICAL CONSTRUCTION CONDITIONS.
- G. FINAL CIRCUITING, CONDUIT ROUTING, WIRING METHODS, SWITCHING ARRANGEMENTS, AND ELECTRICAL COMPONENT COORDINATION SHALL BE PER THE APPROVED ELECTRICAL PERMIT DRAWINGS AND DETAILS.
- H. CONTRACTOR SHALL COORDINATE MOUNTING HEIGHTS, MOUNTING DETAILS, CONTROL DEVICES, AND POWER REQUIREMENTS PRIOR TO ROUGH-IN AND INSTALLATION.
- I. ALL LIGHT FIXTURES SHALL OPERATE IN A BI-LEVEL MODE. LIGHT OUTPUT SHALL BE AUTOMATICALLY DIMMED TO 50% DURING PERIODS OF NO OCCUPANCY AND SHALL INCREASE TO FULL OUTPUT UPON OCCUPANT OR VEHICLE DETECTION. AFTER A SET TIMEOUT PERIOD, FIXTURES SHALL RETURN TO THE DIMMED STATE. FIXTURE CONTROLS SHALL BE PROGRAMMED TO COMPLY WITH ALL APPLICABLE ENERGY AND LIGHTING CODES INCLUDING LOCAL ORDINANCES.

**LIGHT FIXTURE SPECIFICATIONS:**

**FIXTURE: F1A**  
MANUFACTURER: EURI LIGHTING  
MODEL: EFL-130W-MD  
LUMENS: 12000 LUMENS  
COLOR TEMPERATURE: 3000K  
INPUT VOLTAGE: 120VAC  
POWER CONSUMPTION: 12.5W  
CONTROLS: INTEGRAL DUSK-TO-DAWN SENSOR WITH TIME-SWITCH OVERRIDE AND AUTOMATIC TRANSITION FROM DIMMED TO FULL BRIGHTNESS UPON MOTION DETECTION

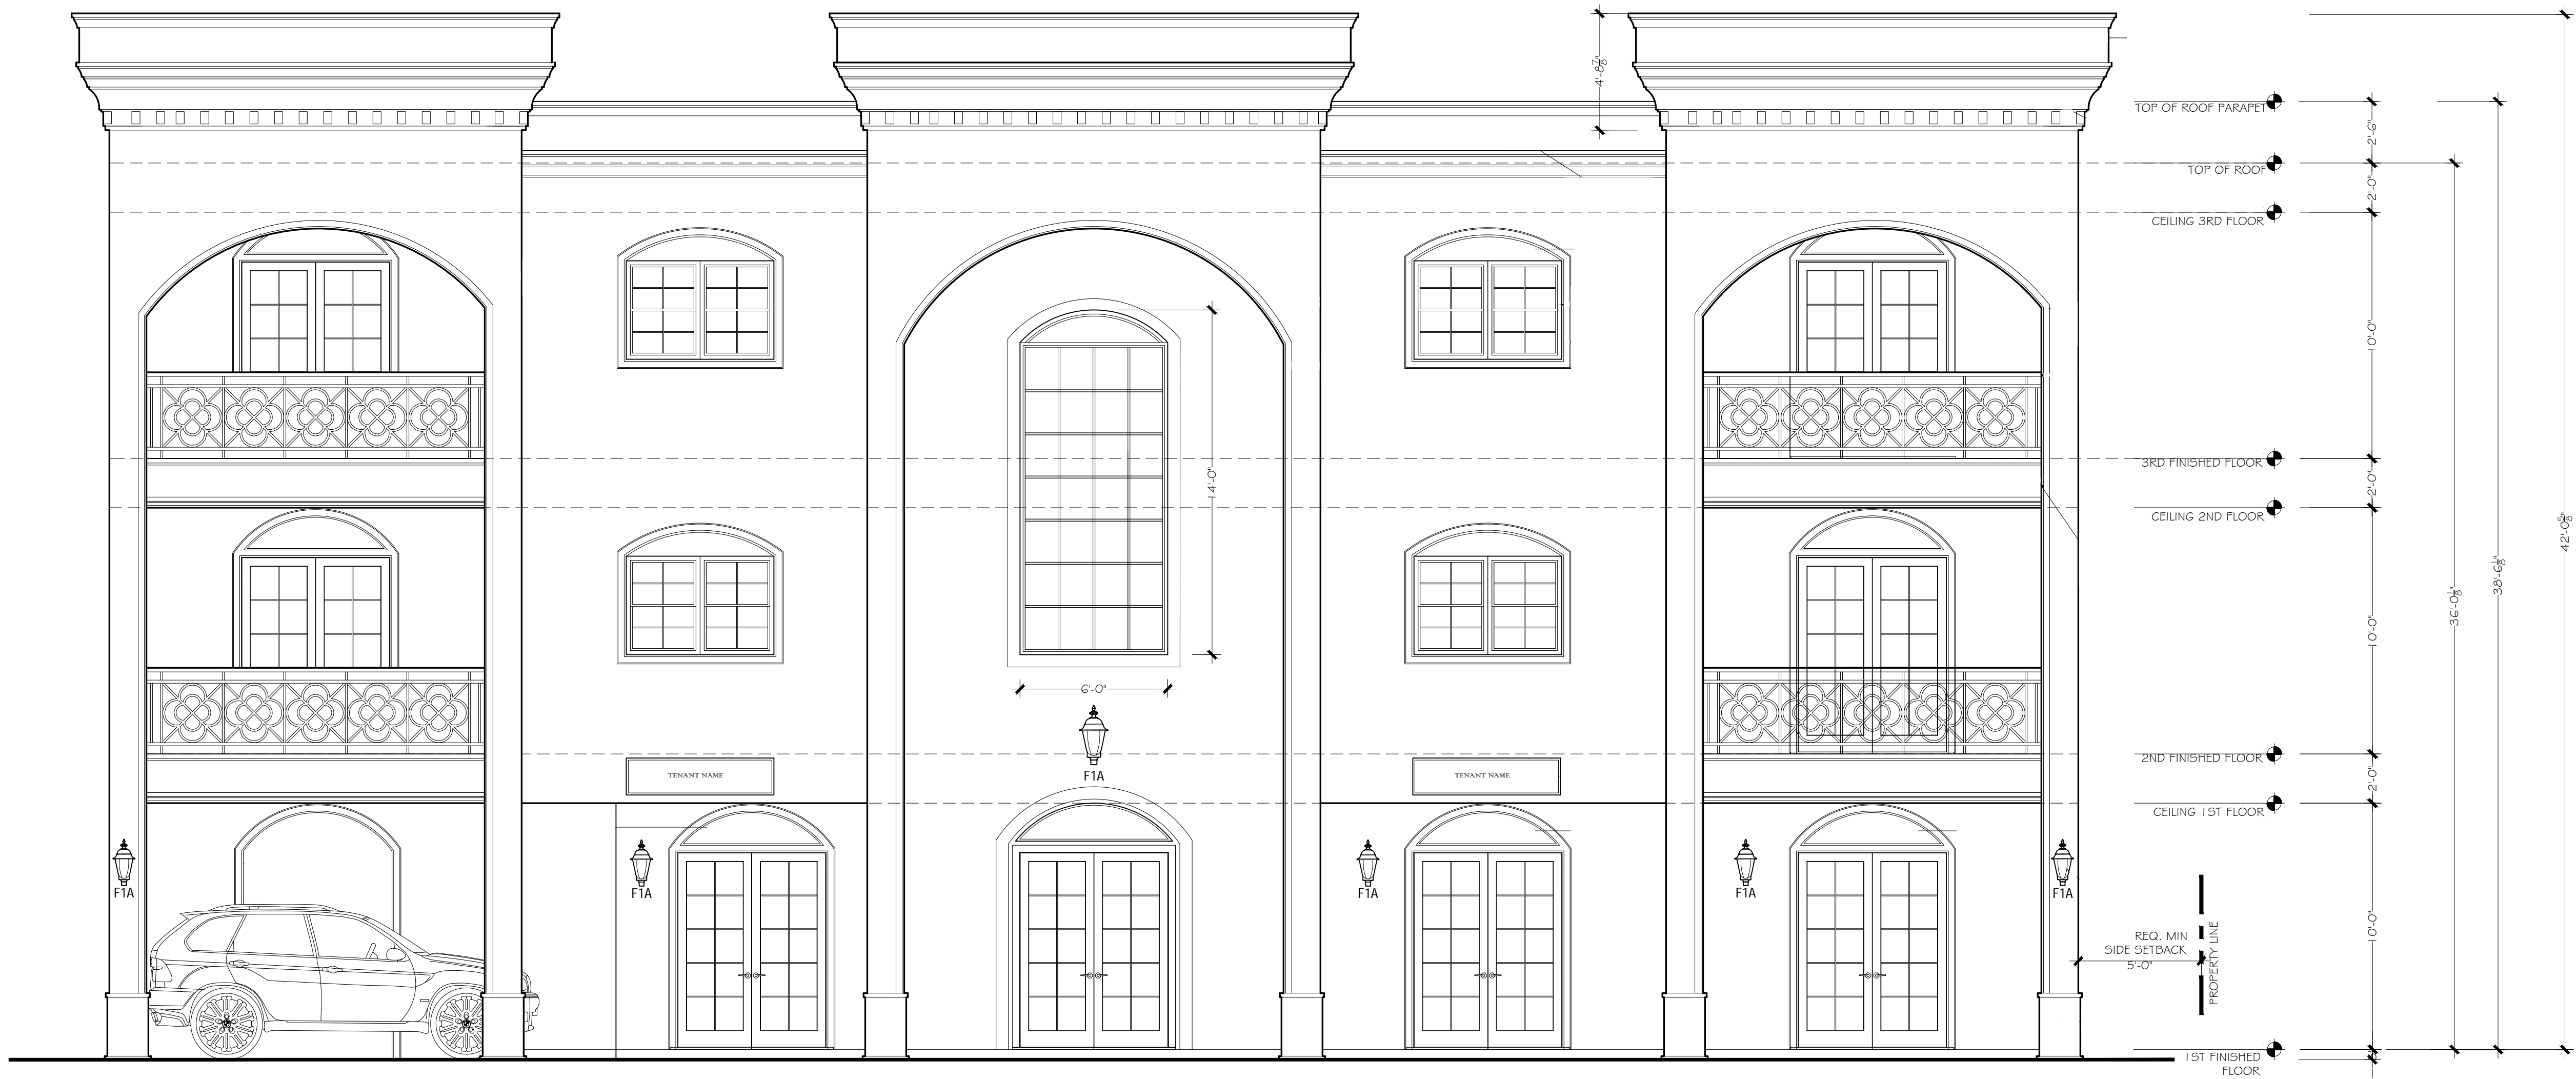

1 LIGHTING FRONT EAST ELEVATION  
E101 SCALE: 1/8" = 1'-0"



2 LIGHTING SOUTH SIDE ELEVATION  
E101 SCALE: 1/8" = 1'-0"

Client:

Project Title:

Stamp:

Rev #

Date:

Drawn By:

Checked By:

Date:


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Sheet Title:

LIGHTING -  
ELEVATION PLANS

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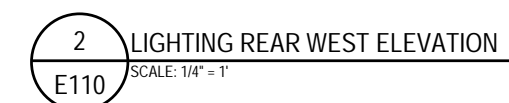
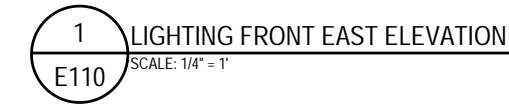
E101





CONTROLS: INTEGRAL DUSK-TO-DAWN SENSOR WITH TIME-SWITCH OVERRIDE AND AUTOMATIC TRANSITION FROM DIMMED TO FULL BRIGHTNESS UPON MOTION DETECTION

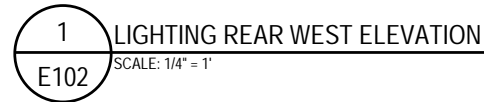







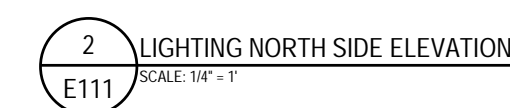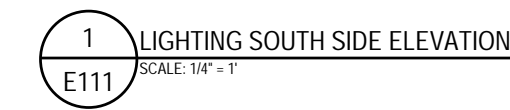

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Date:

Date:

30

By:

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Number:

## LIGHTING - RENDERING IMAGES

Number

E111





**KISEL**  
Engineers

[illegible]

By            Date

By            Date

Project Number:

Post Number:

E112